

OF TRAVEL

SLOPE 1:10

OF TRAVEL

SLOPE 1:10_

SQUARE OFF THE FULL WIDTH OF THE ROADWAY AT THE END OF WORK DAY

TEMPORARY PAVEMENT TRANSITION DETAIL

SOIL SLOPE-


4" OR GREATER

EXCAVATION

ROADWAY SLOPE PROTECTION

NOT TO SCALE

TEMPORARY SIGNS

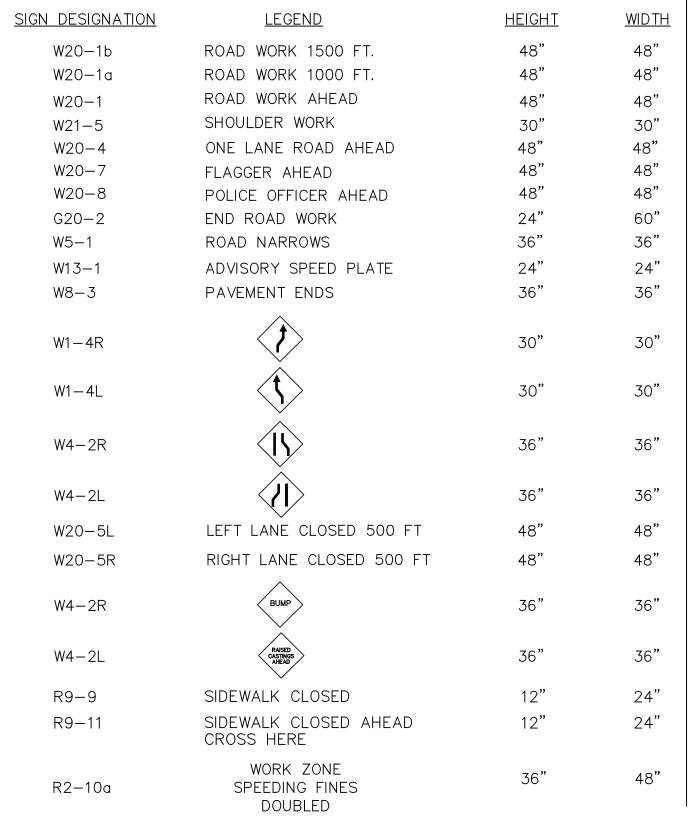


WAREHAM CRANBERRY HIGHWAY (ROUTES 6 & 28) STATE FED. AID PROJ. NO. SHEETS 53 MASS XXXX PROJECT FILE NO. 117106 TRAFFIC MANAGEMENT PLANS

GENERAL NOTES

- 1. ALL CONSTRUCTION SIGNING, DRUMS, BARRICADES AND OTHER DEVICES SHALL CONFORM WITH THE 2003 MANUAL ON UNIFORM TRAFFIC CONTROL DEVICES (M.U.T.C.D.) AS AMENDED.
- 2. ALL DRUMS SHALL BE SET AT 20' ON CENTER MAX. UNLESS OTHERWISE NOTED OR ADJUSTED BY THE ENGINEER.
- 3. ALL DRUMS SHALL BE APPROXIMATELY PLACED AND MOVED AS NECESSARY TO MAINTAIN ADEQUATE ABUTTER ACCESS AT ALL TIMES. WORK MAY REQUIRE ADDITIONAL SIGNS, DRUMS AND OTHER TRAFFIC CONTROL DEVICES, GRADING AND TEMPORARY PAVEMENT FOR PASSAGE OF PEDESTRIAN, VEHICULAR AND EMERGENCY TRAFFIC THROUGH THE WORK AREAS. BOTH DURING AND AFTER WORKING HOURS, TO MAINTAIN SUCH ACCESS.
- 4. THE CONTRACTOR SHALL NOTIFY EACH ABUTTOR AT LEAST 24 HOURS IN ADVANCE OF THE START OF ANY WORK THAT WILL REQUIRE THE TEMPORARY CLOSURE OF ACCESS, SUCH AS CONDUIT INSTALLATION, EXISTING PAVEMENT EXCAVATION, TEMPORARY DRIVEWAY PAVEMENT PLACEMENT AND SIMILAR OPERATIONS.
- 5. A MINIMUM OF ONE LANE OF TRAFFIC IN EACH DIRECTION ON TWO WAY STREETS SHALL BE MAINTAINED AT ALL TIMES, EXCEPT THAT DURING WORKING HOURS, TRAFFIC MAY BE REDUCED TO ONE LANE UNDER POLICE CONTROL FOR SHORT TIME PERIODS WHEN REQUIRED FOR THE WORK, AS SHOWN.
- 6. GRADE SEPARATIONS IN EXCESS OF 2" DURING NON-WORKING HOURS WILL REQUIRE DELINEATION BY USE OF DRUMS.
- 7. EXCAVATION EDGES IN EXCESS OF 4" DEEP SHALL BE PROTECTED DURING NON-WORKING HOURS BY BACKFILLING WITH A WEDGE OF GRAVEL OR SOIL TO COMPACTED 1:4 SLOPE.
- 8. 11' MINIMUM LANE WIDTHS SHALL BE MAINTAINED.
- 9. NON-ESSENTIAL TRAFFIC CONTROL DEVICES SHALL BE COVERED OR REMOVED DURING NON-WORKING HOURS.
- 10. THE GENERAL SEQUENCE OF WORK IS DEPENDENT UPON THE REMOVAL AND RELOCATION OF THE EXISTING UTILITY POLES AND WIRES THAT ARE FOUND TO BE IN CONFLICT WITH THE PROPOSED WORK, BY THE UTILITY COMPANIES. THE CONTRACTOR SHALL SCHEDULE THE WORK IN EACH AREA TO COORDINATE WITH THE POLE RELOCATION WORK.
- 11. ADVISORY SPEED PLATES (W13-1) SHALL BE USED IF APPROPRIATE AND AS DIRECTED BY THE ENGINEER.

PEDESTRIAN BYPASS

TO BE USED IN CONJUNCTION WITH THE PROPOSED LANE CLOSURE DETAILS AND DURING CONSTRUCTION STAGING AND AS DIRECTED BY THE ENGINEER.

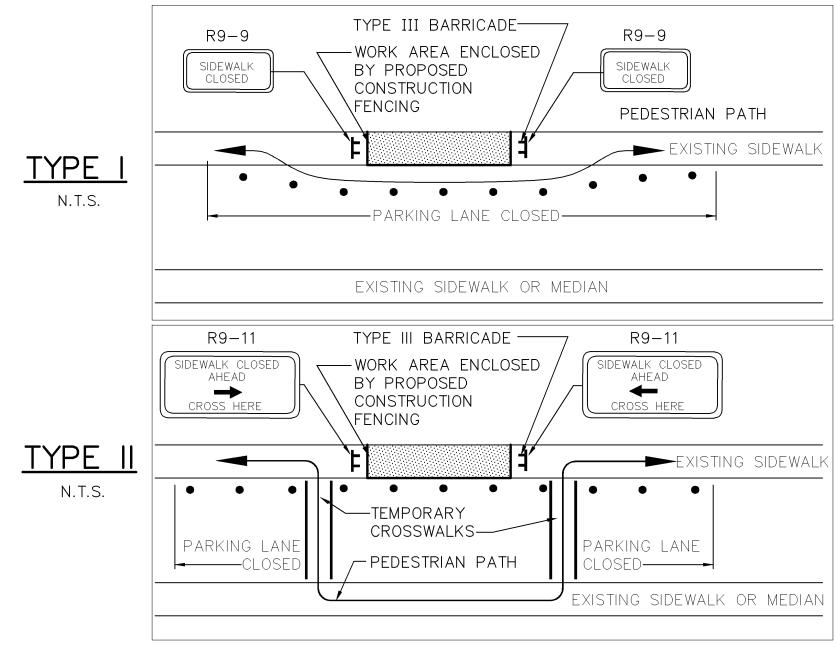

$\overline{W}_{20}-4$ ONE LANE BI-DIRECTIONAL TRAFFIC AT INTERSECTIONS NOT TO SCALE 1. ADVANCE WARNING SIGN PLACEMENT TO BE ADJUSTED AS NECESSARY

NOT TO SCALE

W20-8 *

-WORK AREA

_ DRUMS @ 15' O.C.

* OR W20-7 WHEN FLAGGER IS USED

NOTE:

W20-4


DRUMS @ 15' O.C. -

`G'ヹ W20−8

250′ 250′

MIN. MIN.

DRUMS @ 15' O.C.-

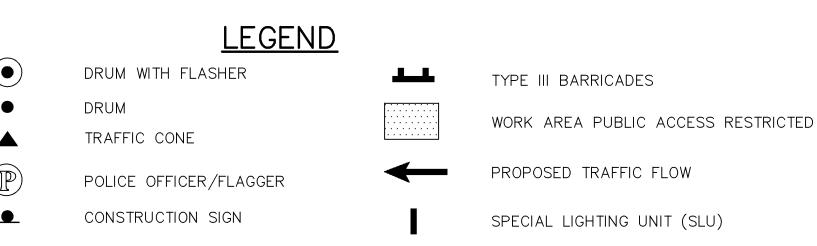

NTS

- 1. ADDITIONAL ADVANCE WARNING MAY BE NECESSARY.
- 2. CONTROLS FOR PEDESTRIAN TRAFFIC ONLY, ARE SHOWN. VEHICULAR TRAFFIC SHALL BE MAINTAINED AS SHOWN ELSEWHERE.
- 3. STREET LIGHTING SHOULD BE CONSIDERED WHEN LOCATING CONTROL DEVICES.


4. DIRECTION OF PEDESTRIAN TRAVEL.

5. IF THE WORK ZONE DOES NOT PERMIT PEDESTRIANS TO TRAVEL ADJACENT TO IT AS SHOWN IN PEDESTRIAN BYPASS TYPE I, TEMPORARY CROSSWALKS WITH APPROPRIATE SIGNS SHALL BE INSTALLED TO CROSS PEDESTRIANS TO THE OPPOSITE SIDE OF THE STREET AS SHOWN IN PEDESTRIAN BYPASS TYPE II, AND AS DIRECTED BY THE ENGINEER.

WAREHAM CRANBERRY HIGHWAY (ROUTES 6 & 28)

STATE	FED. AID PROJ. NO.	SHEET NO.	TOTAL SHEETS
MASS.	XXXX	54	81
PROJECT FILE NO. 117106			

TRAFFIC MANAGEMENT PLANS

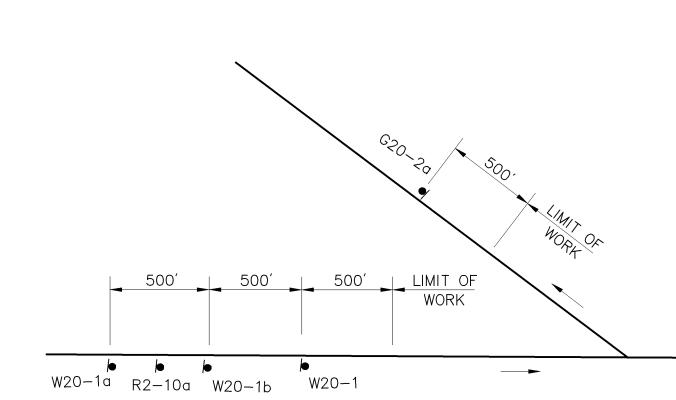


ROUTE 6 & 28 (CRANBERRY HIGHWAY)


TEMPORARY SIGNS

SIGN DESIGNATION	<u>LEGEND</u>	<u>HEIGHT</u>	<u>WIDTH</u>
W20-1a	ROAD WORK 1500 FT.	48"	48"
W20-1b	ROAD WORK 1000 FT.	48"	48"
W20-1	ROAD WORK AHEAD	48"	48"
G20-2a	END ROAD WORK	24"	60"
R2-10a	WORK ZONE SPEEDING FINES DOUBLED	36"	48"

ADVANCE WARNING SIGN SCHEMATIC

N.T.S. ALL ADVANCE SIGNS TO BE IN PLACE FOR THE DURATION OF THE PROJECT.

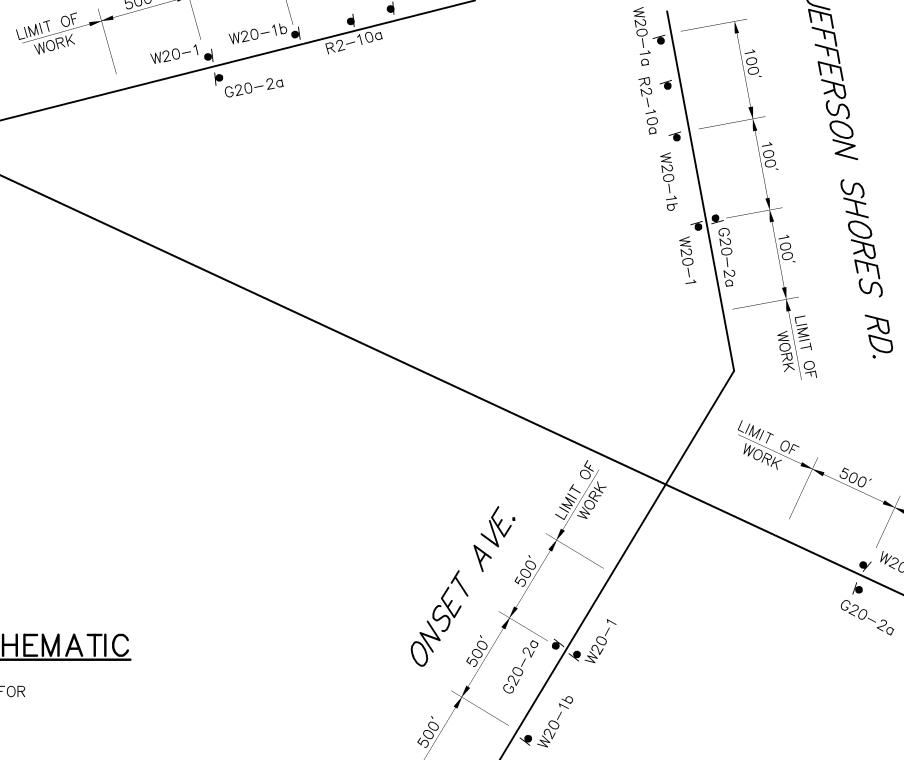

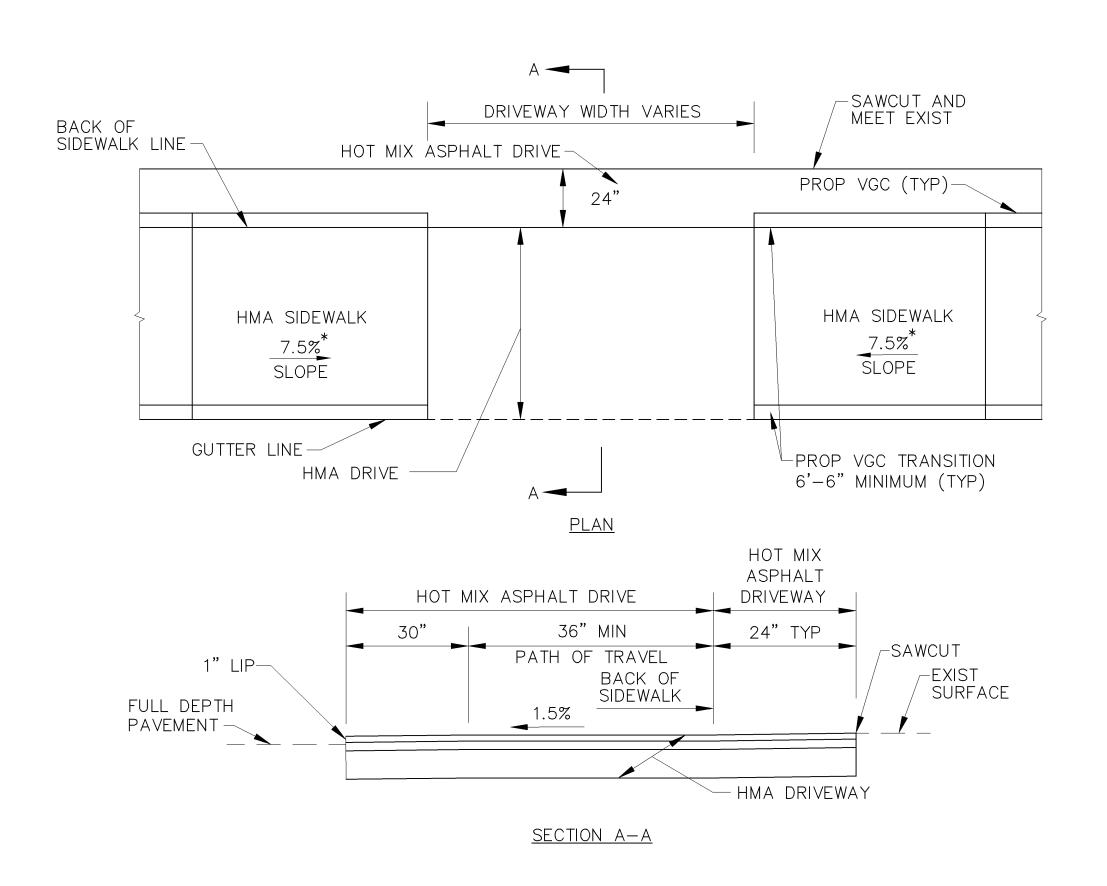


TYPICAL DRIVEWAY WITH FULL DEPTH PAVEMENT CONSTRUCTION — TYPE A

SCALE: NOT TO SCALE

DATE: APRIL 2003

DWG: DRIVE-12

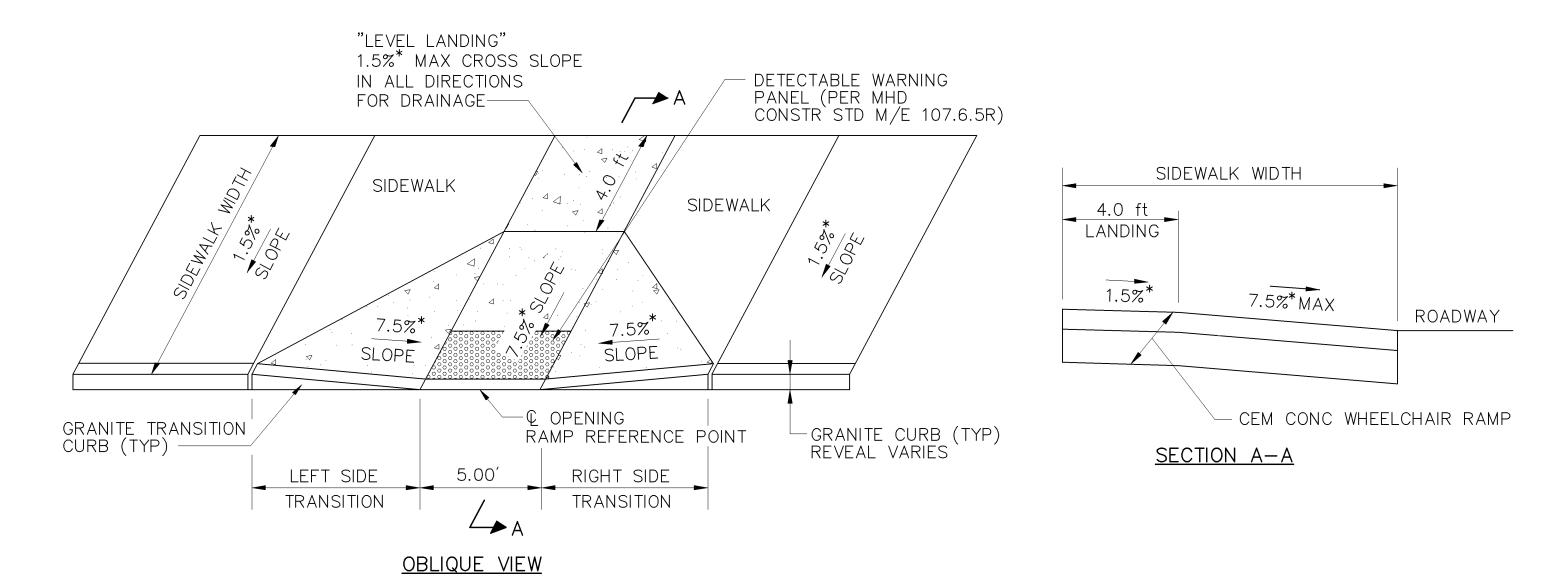


* TOLERANCE FOR CONSTRUCTION ±0.5%


WHEELCHAIR RAN	1P			
SCALE: NOT TO SCALE				
DATE: OCT 2008				
DWG: WCR-01				

WAREHAM CRANBERRY HIGHWAY (ROUTES 6 & 28)

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MASS.	XXXX	55	81	
PROJECT FILE NO. 117106				

CONSTRUCTION DETAILS

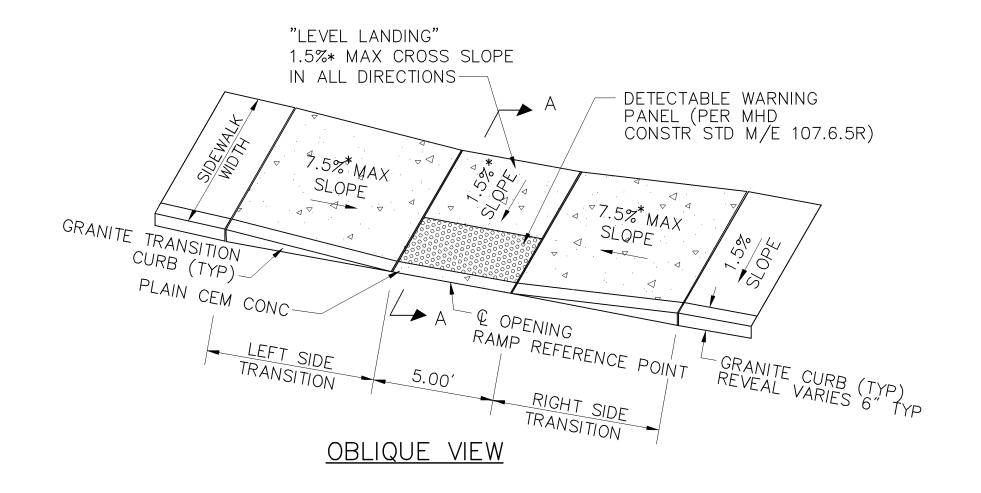

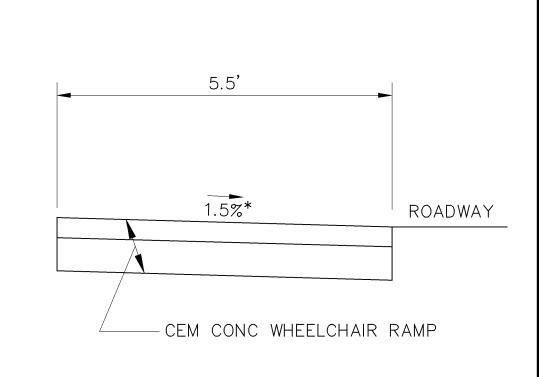


SECTION A-A

* TOLERANCE FOR CONSTRUCTION ±0.5%

WHEELCHAIR RAMP WIDTH LESS THAN 6.5 FT

SCALE: NOT TO SCALE
DATE: OCT 2008

DWG: WCR-03

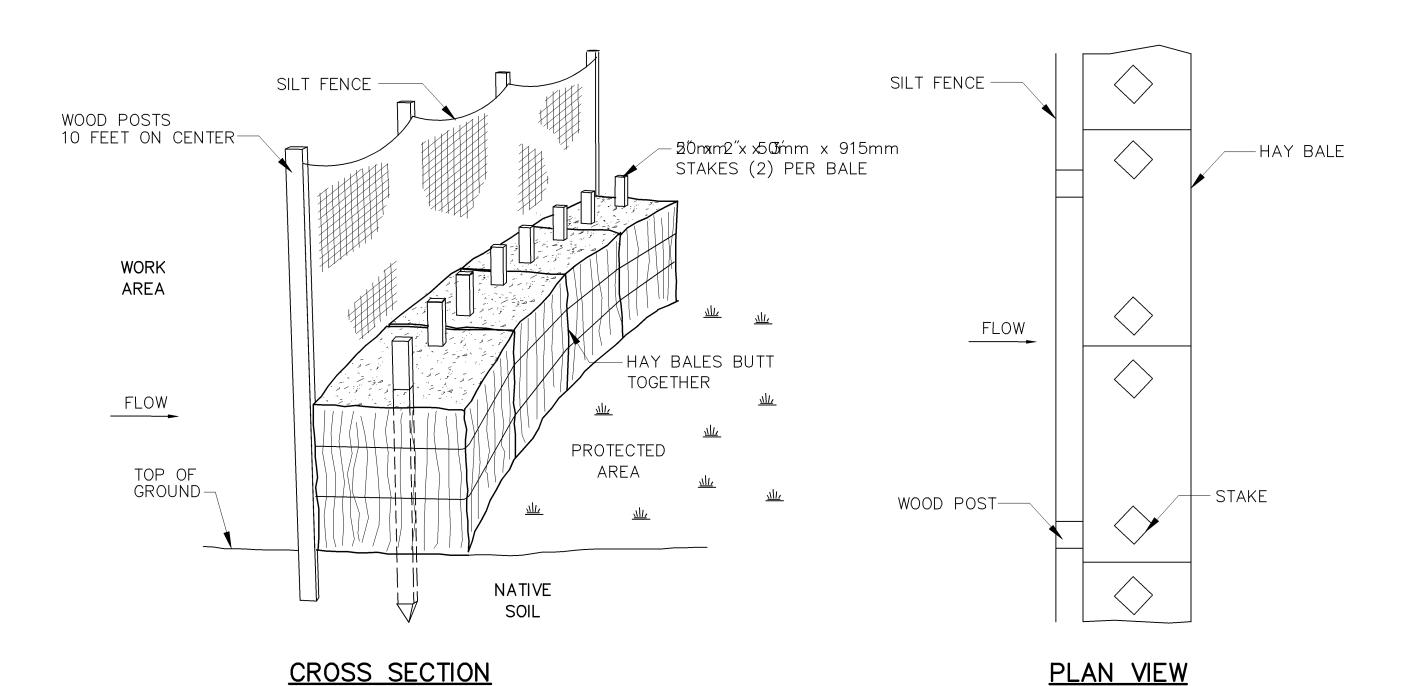

CONSTRUCTION NOTES:

- 1. FILTER CLOTH SHALL BE FASTENED SECURELY TO POSTS WITH WIRE TIES OR STAPLES AND POSTS
- SHALL BE SPACED EVERY 300486T.
- 2. WHEN TWO SECTIONS OF FILTER CLOTH ADJOIN EACH OTHER THEY SHALL BE OVERLAPPED BY
- 650MMESANANIFOEDEDED. 3. ENTRENCH SILT FENCE BUT NOT HAY BALES.
- 4. INSPECTIONS SHALL BE FREQUENT AND REPAIR OR REPLACEMENT SHALL BE MADE PROMPTLY AS

EROSION CONTROL BARRIER

SCALE: NOT TO SCALE


DATE: -


DWG: -

WAREHAM CRANBERRY HIGHWAY (ROUTES 6 & 28)

STATE	FED. AID PROJ. NO.	SHEET NO.	TOTAL SHEETS
MASS.	XXXX	56	81
	PROJECT FILE NO.	117106	

CRITICAL SECTIONS

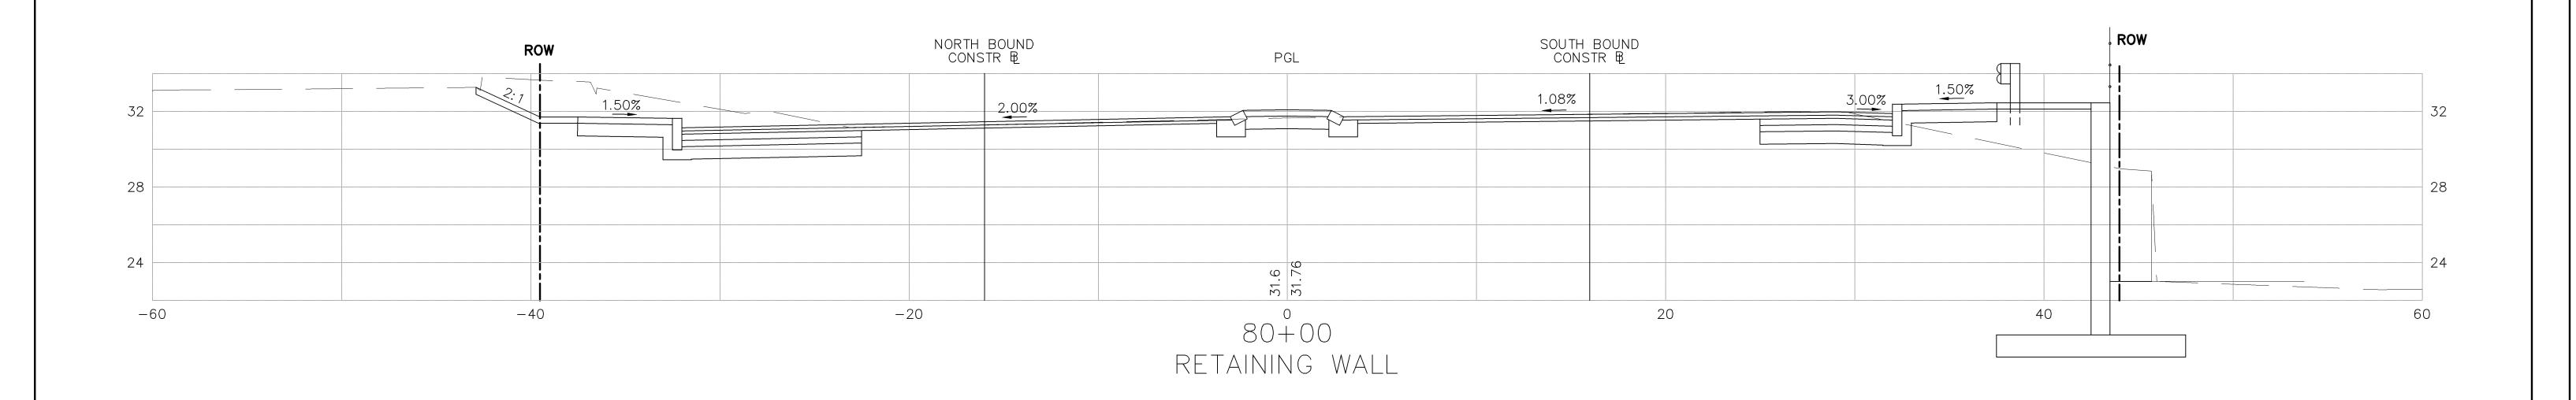

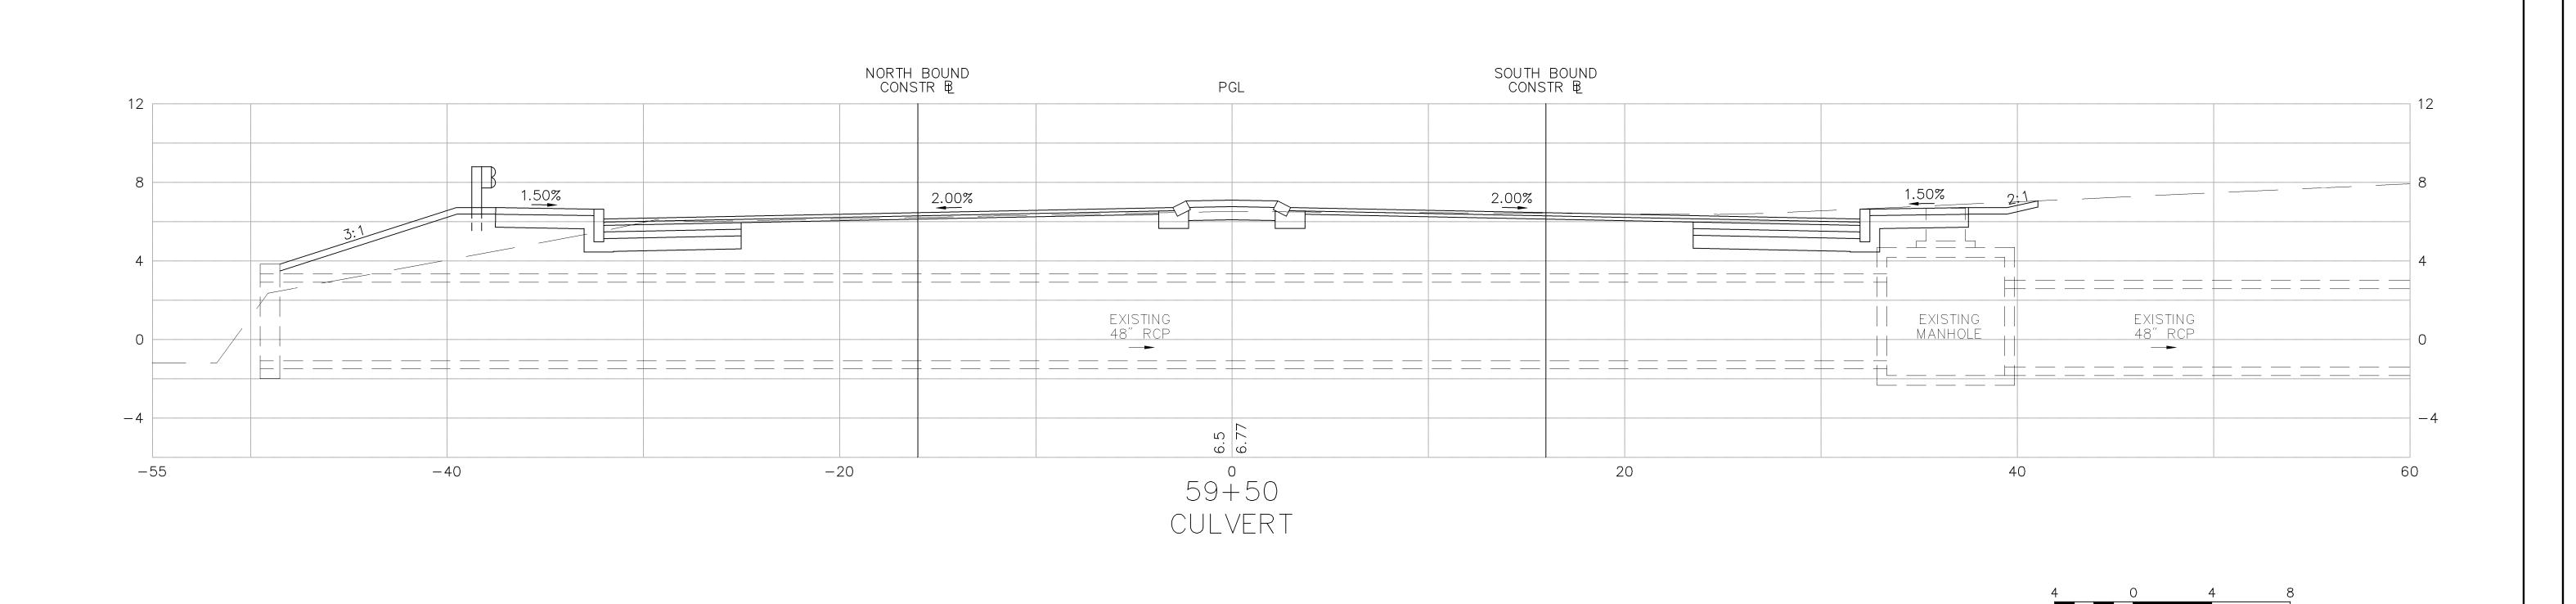

SCALE IN FEET

WAREHAM CRANBERRY HIGHWAY (ROUTES 6 & 28)

STATE	FED. AID PROJ. NO.	SHEET NO.	TOTAL SHEETS		
MASS.	XXXX	57	81		
PROJECT FILE NO. 117106					

CRITICAL SECTIONS

