

DRAWING INDEX
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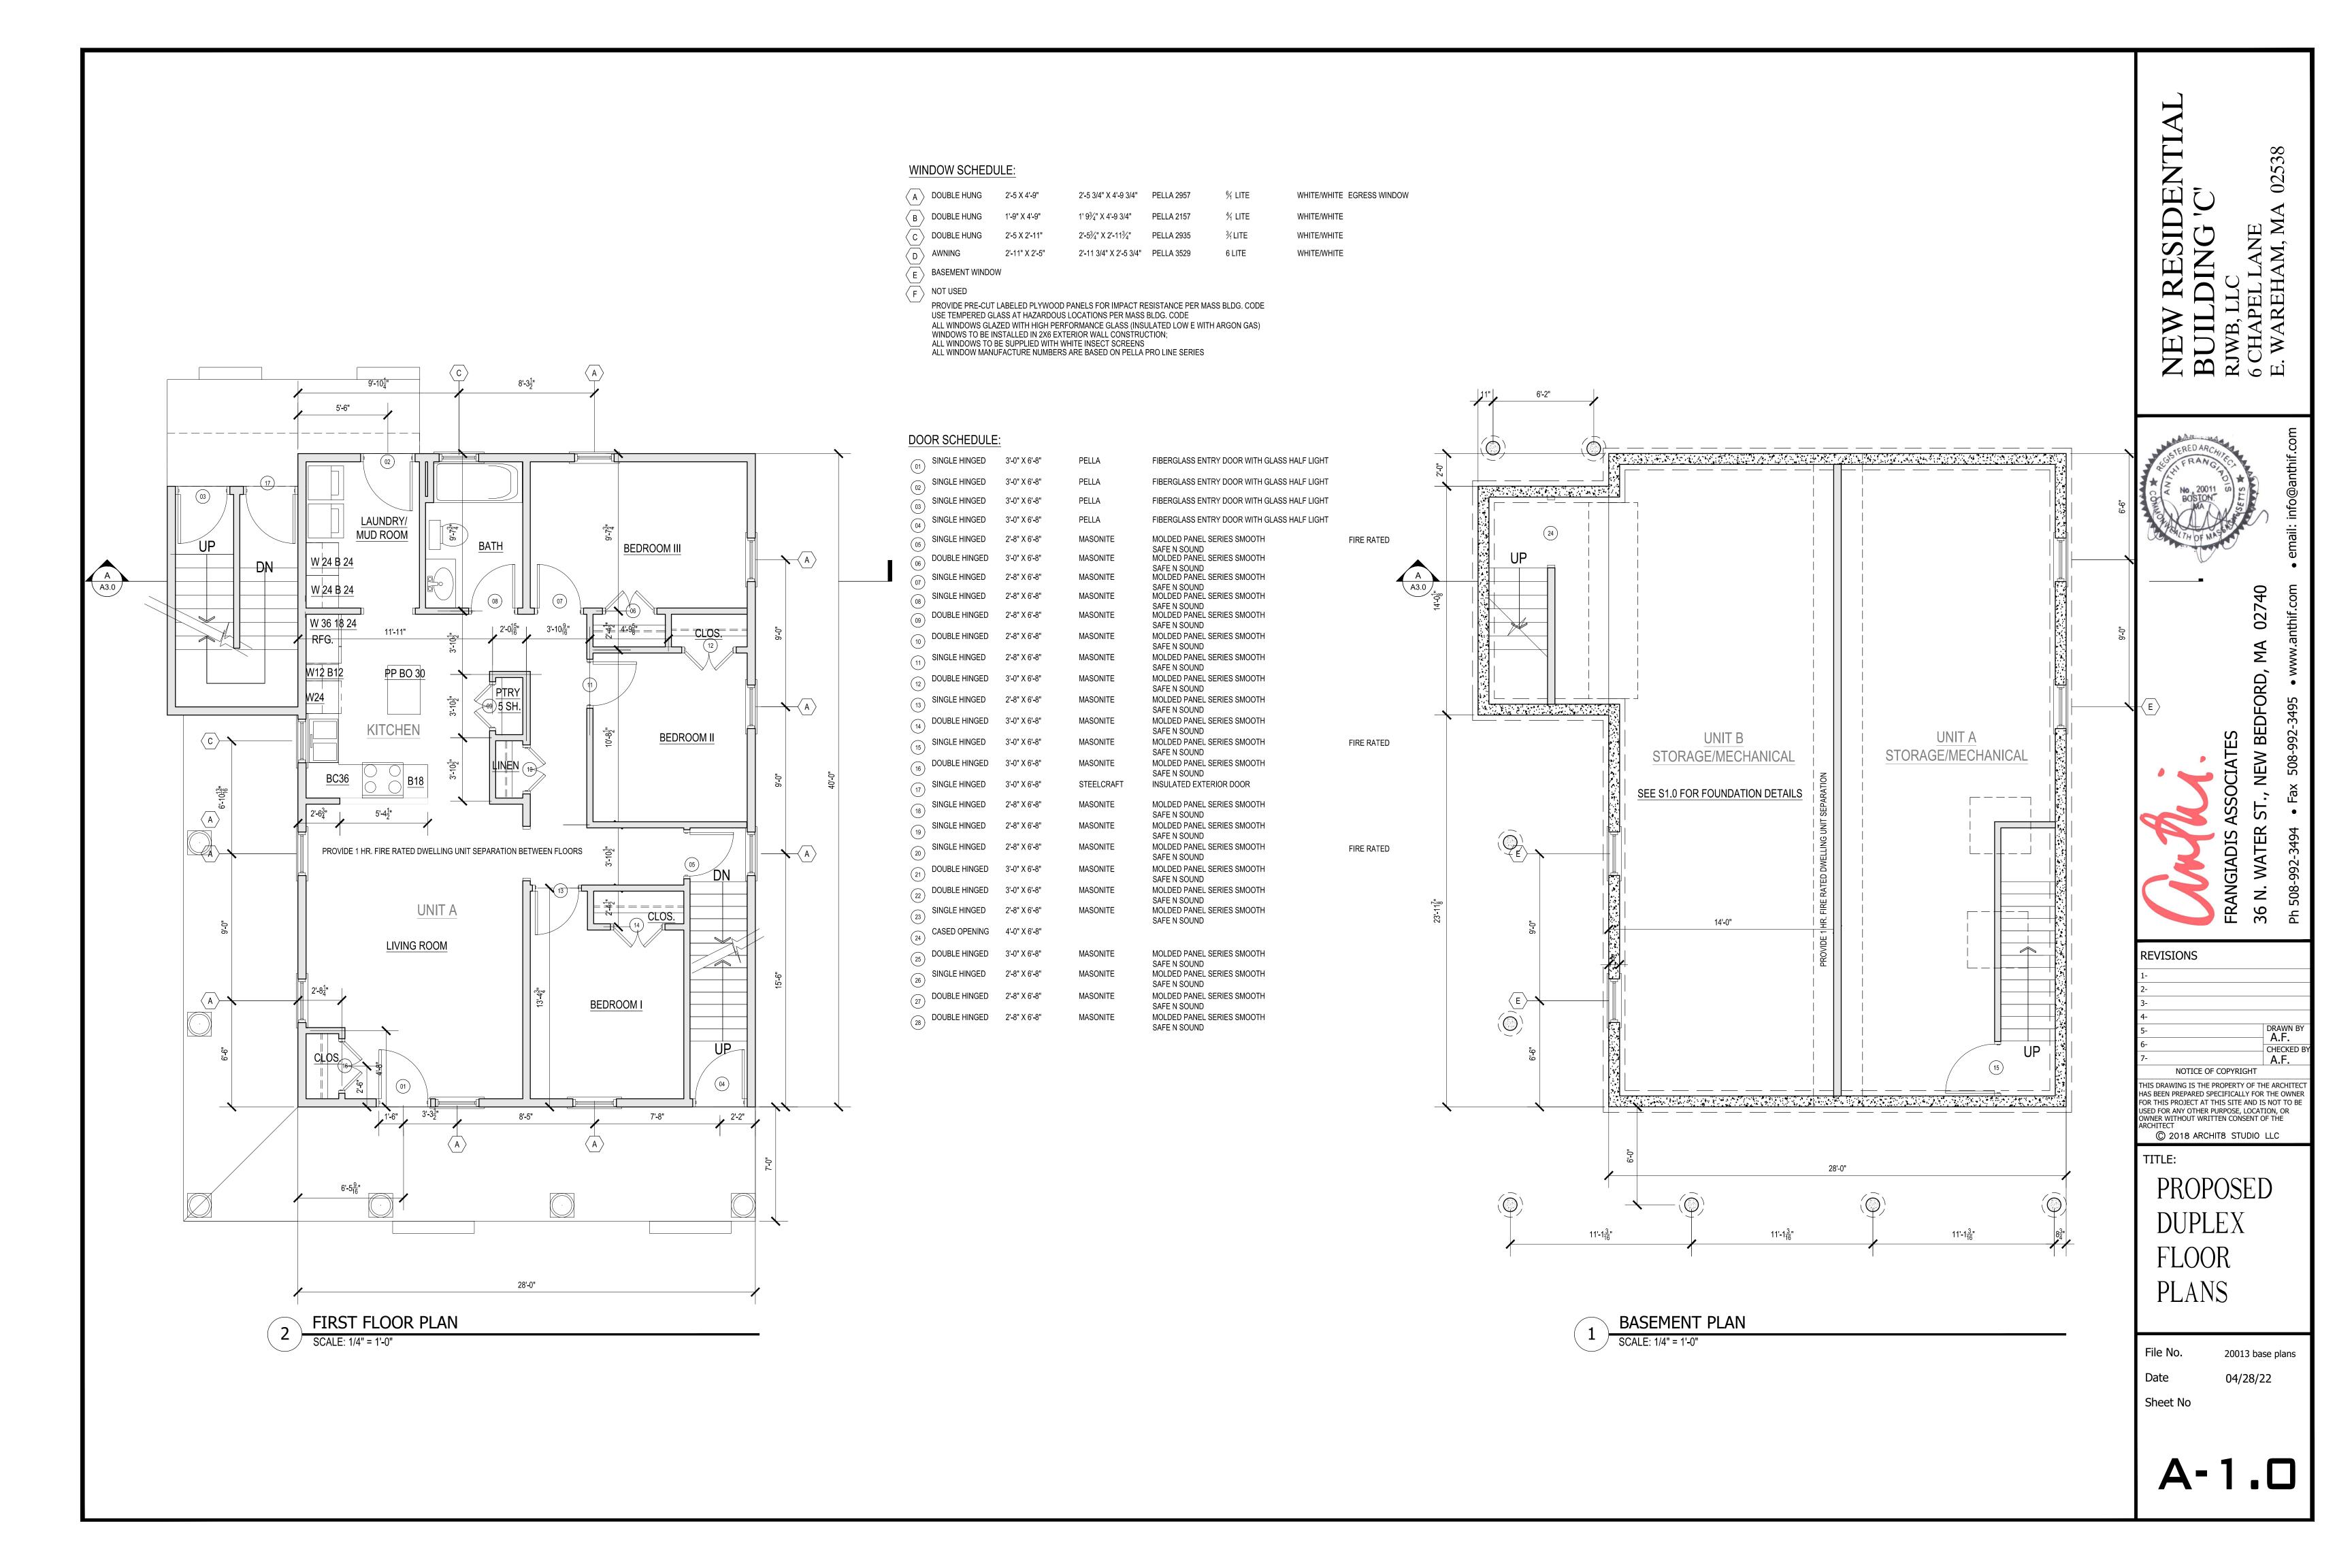
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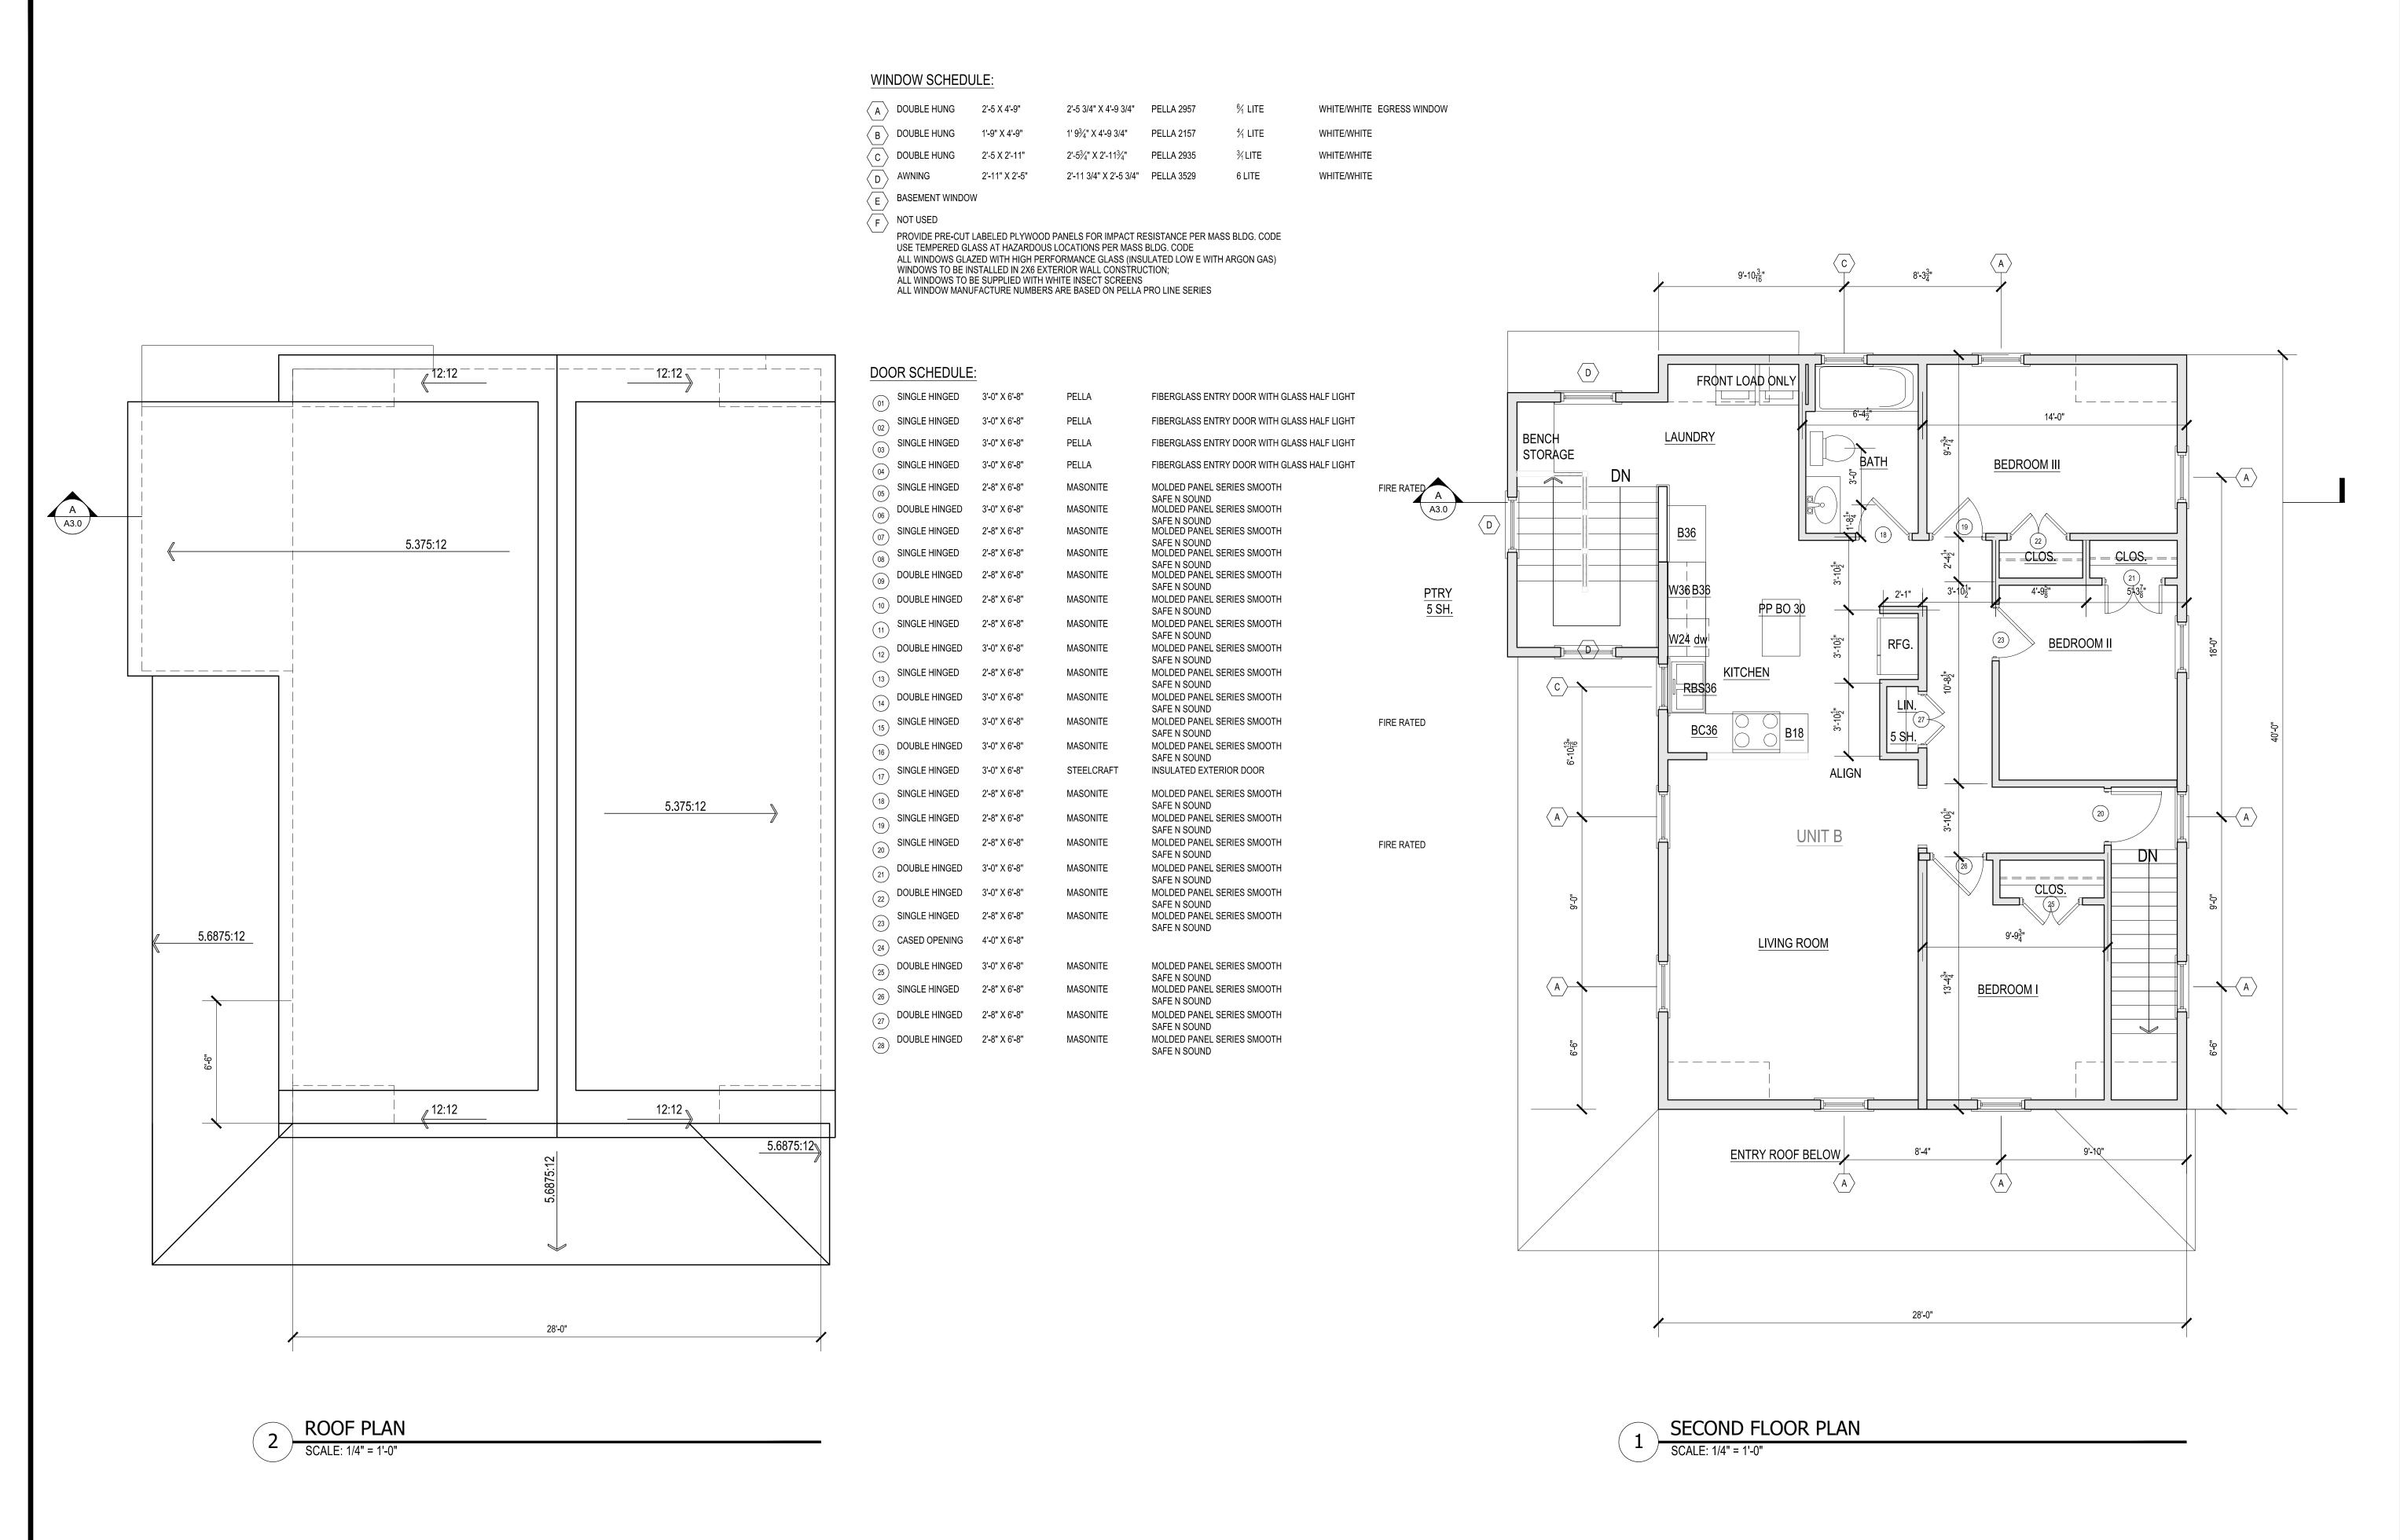
PROJECT AREA CALCULATIONS

Basement - Crawl Space	1232 SF
First Floor Unit A	1232 SF
Second Floor Unit B	1232 SF

2022 28, SET **PERMIT**







W RESIDENTIA ILDING 'C' B, LLC

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REVISIONS

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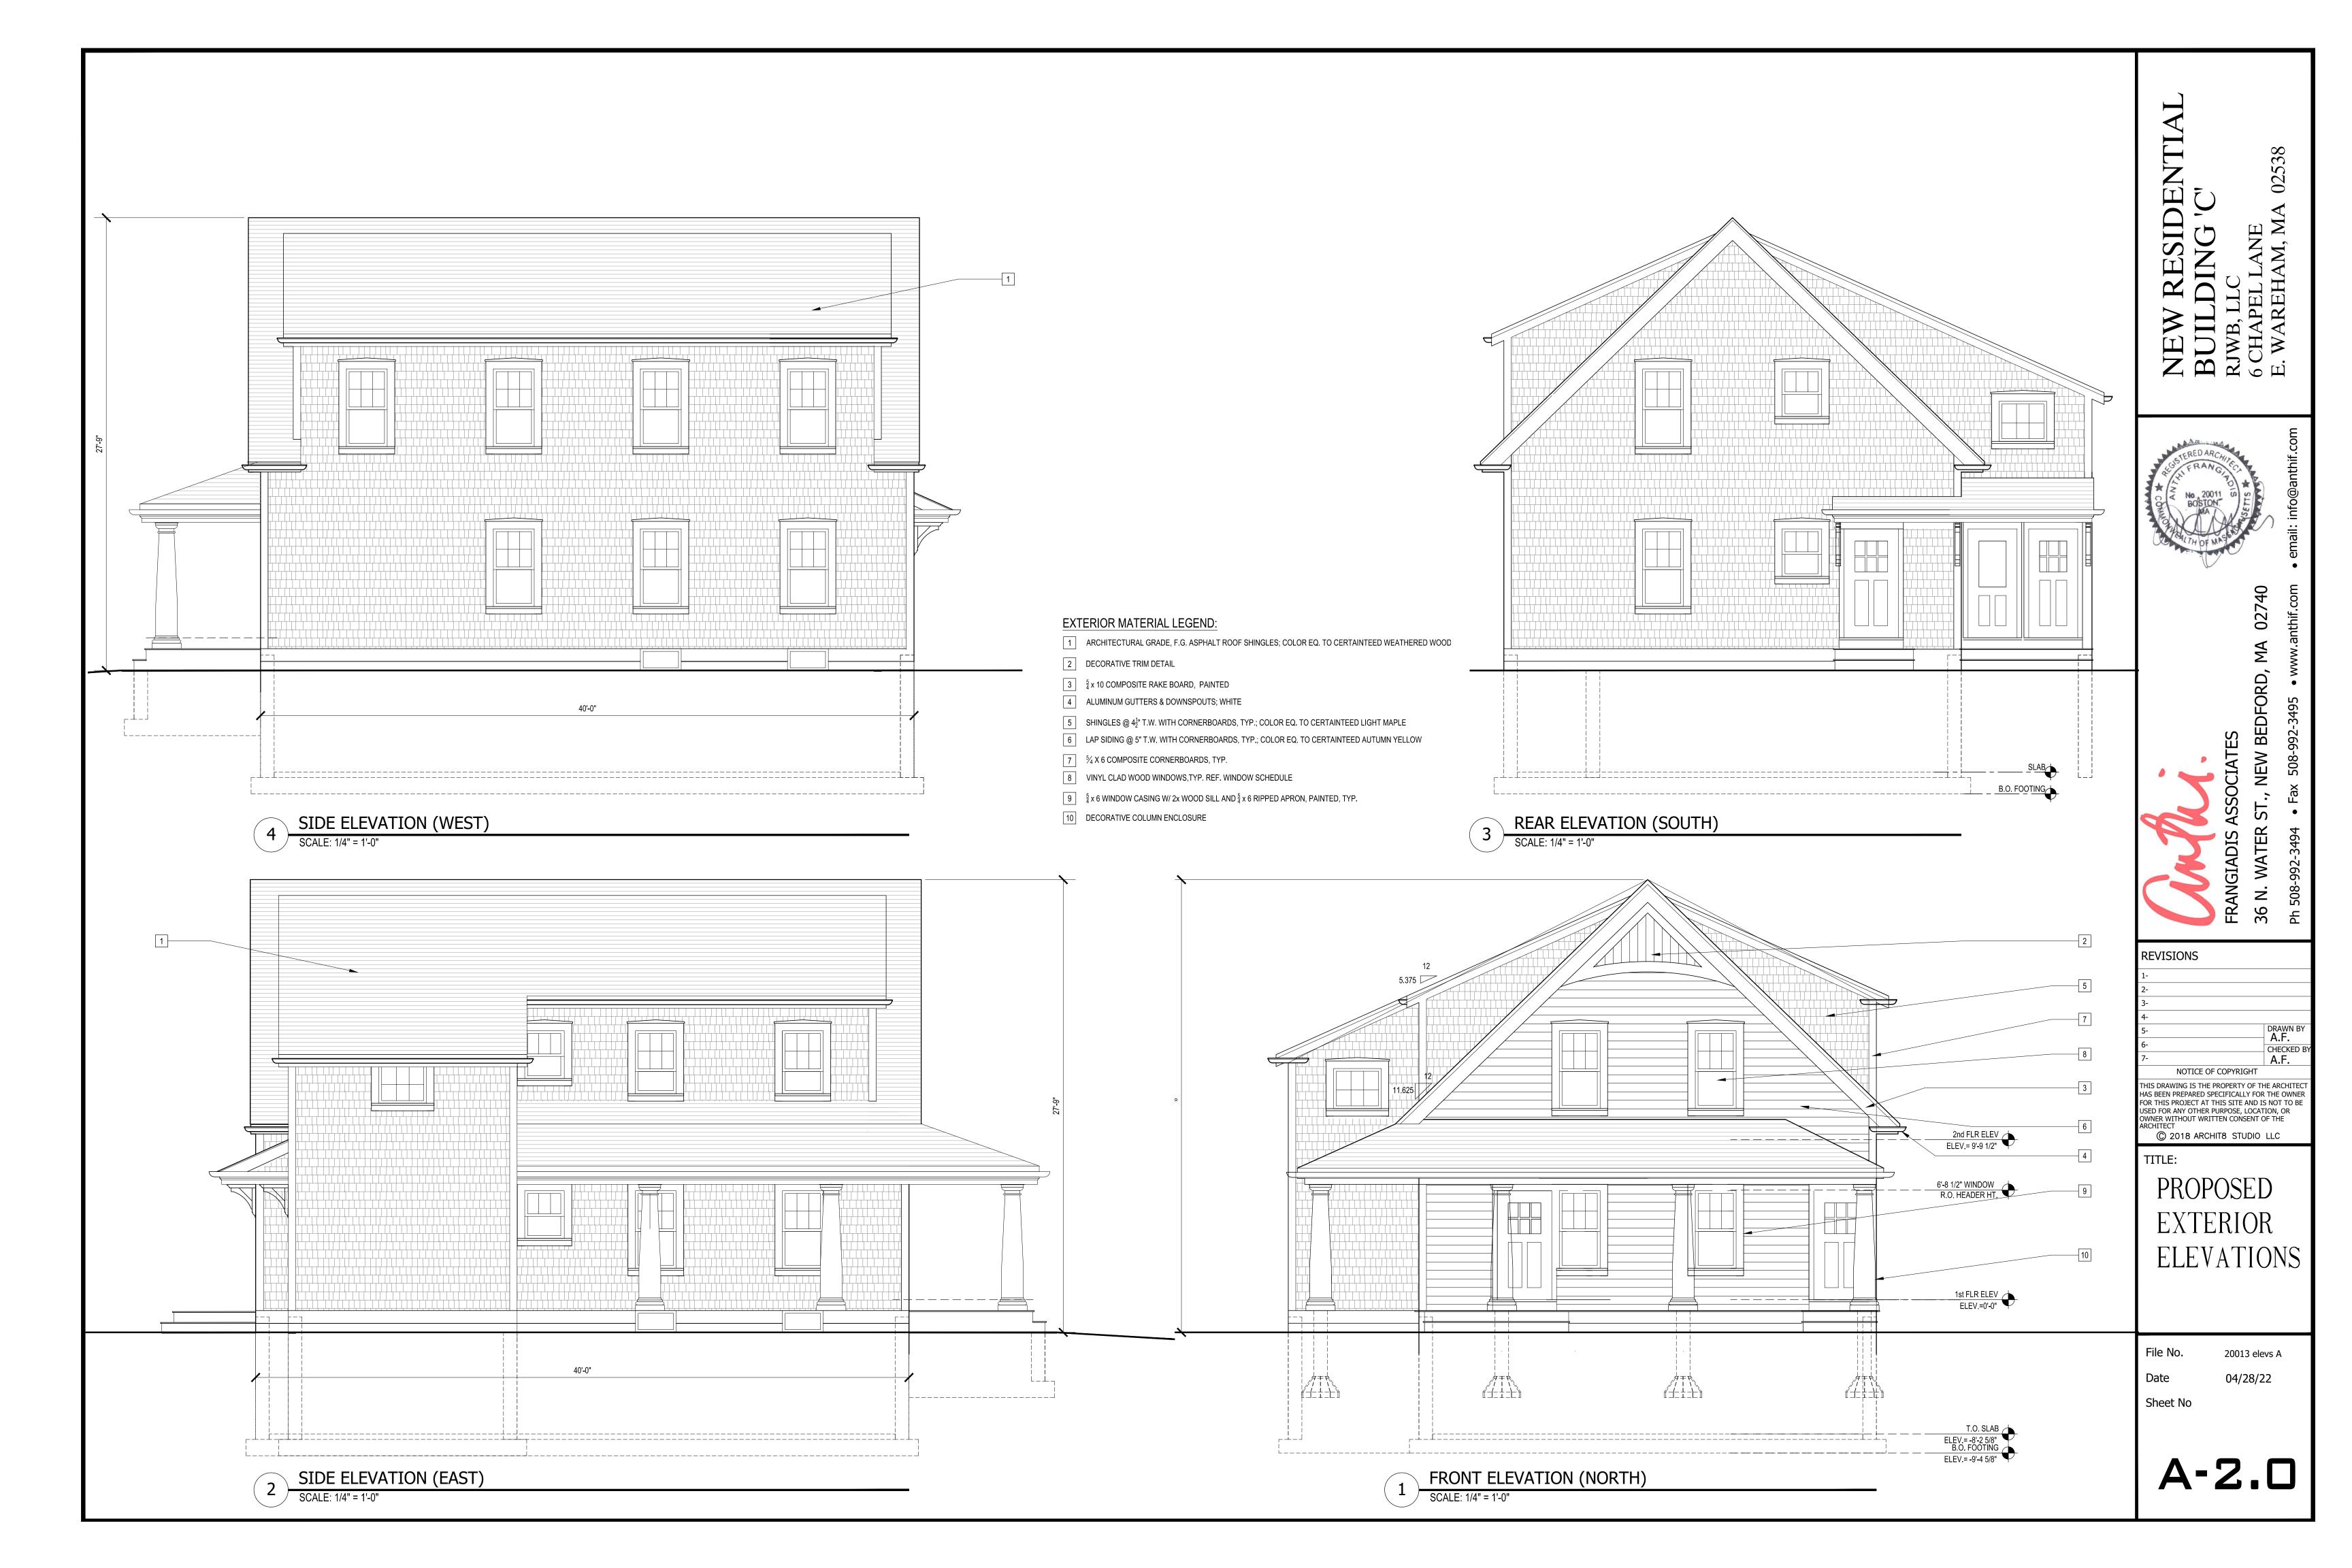
PROPOSED
DUPLEX
FLOOR
PLANS


File No. Date

Date 04/28/22 Sheet No

A-1.1

20013 BASE PLANS



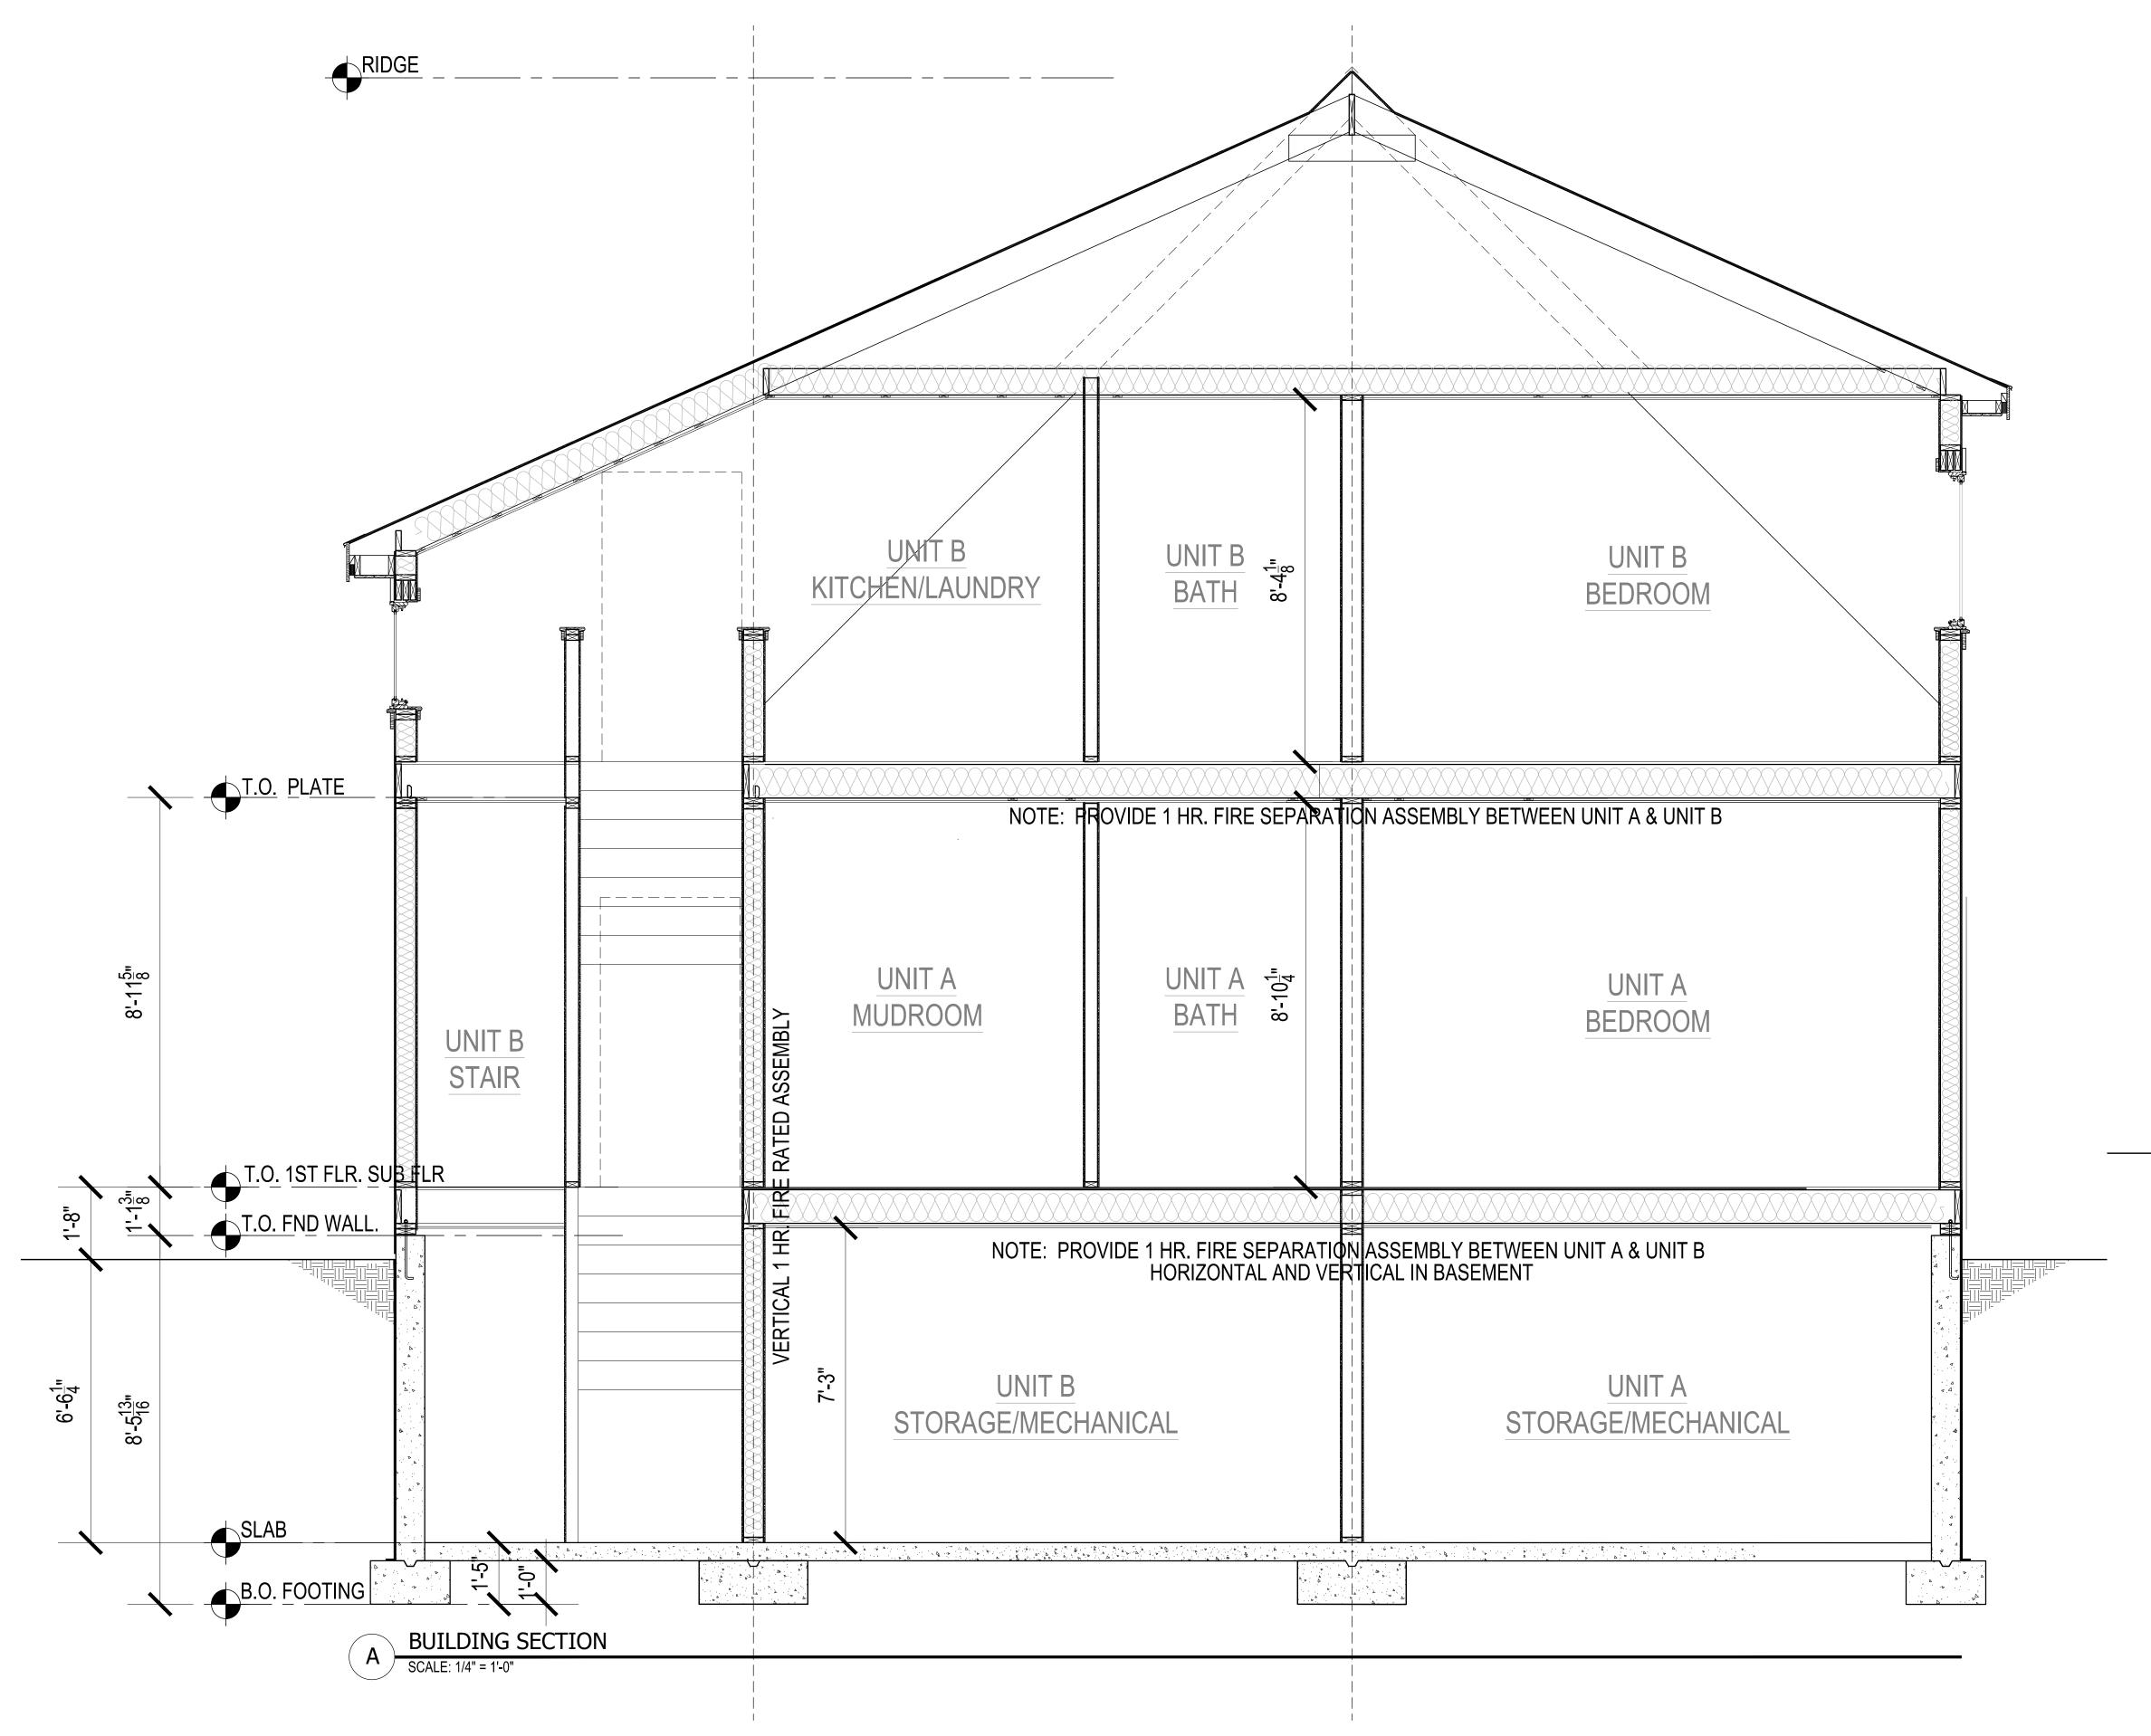

TYPICAL SECTION NOTES:

EXTERIOR WALLS:

- SHINGLES @ 4-1/2" ± EXPOSURE OR CLAPBOARD SIDING @ 5" EXPOSURE
- TYVEK HOUSE WRAP OR EQUAL
- 1/2" CDX PLYWOOD SHEATHING - BATT INSULATION (R-21)
- 2 x 6 STUDS 16" O.C.
- 1/2" GWB PAINTED

ROOF CONSTRUCTION:

- F.G. ASPHALT SHINGLES (ARCHITECT GRADE)
- 30# SATURATED BUILDING FELT - ICE & WATERSHIELD @ EAVES,
- VALLEYS, RISING WALLS
- 1/2" CDX PLYWOOD ROOF SHEATHING
- 2 x 10 RAFTERS w/ SIMPSON H2.5 CLIPS @ 16" O.C.
- (UNLESS OTHERWISE NOTED)
- INSULATION (R-30) (AT ALL FINISHED LOCATIONS)
- 1 x 3 STRAPPING @ 16" O.C.
- 1/2" GWB PAINTED

TYP. FLOOR CONSTRUCTION:

- 3/4" ENG. PLYWOOD SUBFLOOR GLUED & NAILED OVER - 2 X 10 @ 16"O.C.. (ALT. TJI 110@ 16" O.C.) - R-38 FIBERGLASS BATT INSULATION FOR STC 50 RATING

(AT ALL FINISHED LOCATIONS) - 1 x 3 STRAPPING @ 16" O.C.

- 5/8" FIRERATED GWB PAINTED

BASEMENT/FOUNDATION WALL: - BITUMINOUS DAMPPROOFING - 8" REINF. CONCRETE FOUNDATION WALL KEYED TO

- CONT. 12" DEEP X 20" WIDE CONC. FTG.



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TITLE:

PROPOSED BUILDING SECTION

Date 04/28/22

20013 elevs bldg a

Sheet No

A-3.0

GENERAL STRUCTURAL NOTES

- 1. ALL CONSTRUCTION SHALL BE IN ACCORDANCE WITH THE MASSACHUSETTS STATE BUILDING CODE (9TH EDITION)
- 2. THE CONTRACTOR SHALL NOT SCALE THE CONTRACT DRAWINGS.
- 3. TYPICAL AND CERTAIN SPECIFIC CONDITIONS HAVE BEEN DETAILED ON THE FOR CONDITIONS NOT SPECIFICALLY SHOWN, THE CONTRACTOR SHALL PREPARE DETAILS SIMILAR TO THOSE SHOWN AND SUBMIT THEM WITH THE RELEVANT SHOP DRAWINGS TO THE ENGINEER
- 4. ALL EXISTING CONDITIONS. DIMENSIONS. AND ELEVATIONS SHALL BE VERIFIED BY THE CONTRACTOR PRIOR TO SUBMISSION OF RELEVANT SHOP DRAWINGS FOR REVIEW AND PRIOR TO COMMENCEMENT OF FABRICATION AND CONSTRUCTION.
- 5. THE CONTRACTOR SHALL NOTIFY THE ENGINEER IN WRITING OF FIELD CONDITIONS WHICH ARE IN CONFLICT WITH THE STRUCTURAL CONTRACT DOCUMENTS.
- 6. THE DESIGN, ADEQUACY, AND SAFETY OF ERECTION BRACING, SHORING, TEMPORARY SUPPORTS, AND OTHER METHODS OF CONSTRUCTION ARE THE RESPONSIBILITY OF THE CONTRACTOR.
- 7. THE CONTRACTOR SHALL COORDINATE THE STRUCTURAL CONTRACT DOCUMENTS WITH CIVIL, ARCHITECTURAL, MECHANICAL, PLUMBING, AND ELECTRICAL DRAWINGS BEFORE COMMENCEMENT OF WORK AND SHALL NOTIFY THE ENGINEER OF ANY CONFLICTS.

<u>DESIGN LOADS</u>

- 1. FLOOR LIVE LOADS
 - A. ATTIC 20 PSF

B. FIRST FLOOR - 40 PSF

- 2. ROOF LIVE LOADS A. 20 PSF
- 3. DEAD LOAD ROOF & FLOOR 10 PSF
- 4. WIND LOADS
 - A. REFERENCE WIND VELOCITY = 110 MPH
 - B. REFERENCE WIND PRESSURE = 21 PSF C. EXPOSURE = B
 - D. DESIGN PRESSURE FOR VERTICAL PARTS OF STRUCTURE:
 - BEYOND SALIENT CORNERS = 25.2 PSF WITHIN SALIENT CORNERS = 35.7 PSF

CAST-IN-PLACE CONCRETE

- 1. DESIGN AND PLACEMENT OF ALL CONCRETE WORK AND REINFORCING SHALL CONFORM TO THE LATEST ACI CODES AND MANUALS 301, 315, AND 318.
- 2. THE CONTRACTOR SHALL PROVIDE TIES AND BRACING WHERE NECESSARY DURING CONSTRUCTION, TO REMAIN IN PLACE UNTIL THE STRUCTURES ARE COMPLETE.
- 3. DESIGN AND ERECTION OF ALL FORMWORK SHALL BE IN ACCORDANCE WITH ACI 347 AND SHALL
- 4. ALL CAST-IN-PLACE CONCRETE SHALL CONTAIN TYPE I OR II PORTLAND CEMENT AND SHALL
- 5. ALL CONCRETE EXPOSED TO THE WEATHER SHALL BE AIR ENTRAINED. ALL INTERIOR CONCRETE
- SHALL BE NON AIR ENTRAINED. SEE SPECIFIC REQUIREMENTS IN THE SPECIFICATIONS.
- 6. ALL CAST-IN-PLACE CONCRETE SHALL CONFORM WITH THE FOLLOWING:

BE SUPPLIED BY THE SAME MANUFACTURER FOR THE ENTIRE PROJECT.

616, INCLUDING SUPPLEMENT S1, GRADE 60.

BE THE RESPONSIBILITY OF THE CONTRACTOR.

- SLABS ON GRADE FOUNDATION WALLS AND FOOTINGS
- 3000 PSI 7. ALL REINFORCING STEEL SHALL BE DEFORMED BARS CONFORMING TO ASTM A615 OR ASTM A

3000 PSI

STRENGTH AT 28 DAYS MAX. SLUMP

1-1/2"

1-1/2"

- 8. PROVIDE CONTINUOUS REINFORCEMENT WHEREVER POSSIBLE. REINFORCEMENT SPLICES SHALL BE MADE ONLY AS REQUIRED OR PERMITTED ON THE CONTRACT DRAWINGS.
- 9. ALL WELDED WIRE FABRIC SHALL CONFORM TO ASTM A 185 AND SHALL BE PROVIDED IN FLAT SHEETS. IT SHALL BE SUPPORTED ON CONTINUOUS SLAB BOLSTERS AND LAPPED ONE AND ONE-HALF MESH.
- 10. REINFORCEMENT SHALL NOT BE FIELD CUT, UNLESS OTHERWISE INDICATED. WHEN PERMITTED, REINFORCEMENT SHALL BE COLD BENT. HEATING REINFORCEMENT IS
- 11. REINFORCING STEEL SHALL HAVE THE FOLLOWING CONCRETE COVER UNLESS NOTED
 - CONCRETE CAST AGAINST EARTH
 - FORMED CONCRETE EXPOSED TO EARTH OR WEATHER #5 AND SMALLER

 - SLABS AND WALLS NOT EXPOSED TO EARTH OR WEATHER
 - BEAM STIRRUPS, COLUMN AND PIER TIES

CHAMFER ALL EXPOSED CONCRETE EDGES 1/2", UNLESS OTHERWISE INDICATED.

PROVIDE BAR SUPPORTS AND SPACERS IN ACCORDANCE WITH ACI 315 AND CRSI "MANUAL OF STANDARD PRACTICE", CHAPTER 3. ALL BAR SUPPORTS IN AREAS WHERE CONCRETE WILL BE EXPOSED SHALL HAVE PLASTIC TIPPED FEET. THE CONTRACTOR IS CAUTIONED THAT CARE MUST BE EXERCISED TO PREVENT EXPOSURE OF TIE WIRE OR OTHER MATERIALS WHICH MAY CAUSE STAINING OF EXPOSED CONCRETE. PROPER COVER SHALL BE MAINTAINED ON ALL REINFORCEMENT.

CURE CONCRETE IMMEDIATELY AFTER FINISHING IN ACCORDANCE WITH ACI 301, ACI 305R, ACI 306R, AND ACI 308.

FIELD TESTING:

- A. UNLESS OTHERWISE REQUIRED BY THE CONTRACT DOCUMENTS, CAST ONE SET FOUR (4) CONCRETE TEST CYLINDERS (6" DIA. x 12" HIGH) FOR EACH 50 CUBIC YARDS OF CONCRETE PLACED. FOR 16 TO 24 HOURS AFTER CASTING, PROTECT TEST SPECIMENS IN ACCORDANCE WITH ASTM C31. PROVIDE AN ON SITE CURE BOX FOR CYLINDER STORAGE DURING INCLEMENT WEATHER. DO NOT TRANSPORT SPECIMENS TO THE LABORATORY UNTIL AFTER THE INITIAL PROTECTION PERIOD.
- B. AT THE TIME OF CASTING EACH SET OF TEST CYLINDERS, SAMPLE CONCRETE IN ACCORDANCE WITH ASTM C172 AND PERFORM THE FOLLOWING MEASUREMENTS AT THE POINT OF CONCRETE PLACEMENT:
- 1. AMBIENT TEMPERATURE
- 2. CONCRETE TEMPERATURE
- 3. UNIT WEIGHT IN ACCORDANCE WITH ASTM C-138 4. SLUMP IN ACCORDANCE WITH ASTM C-143
- 5. AIR CONTENT IN ACCORDANCE WITH ASTM C-173 OR ATM C-231


FOUNDATION AND SLAB-ON-GRADE NOTES


FOUNDATIONS SHALL BEAR ON STRATA WITH A BEARING PRESSURE OF 2000 PSF.


NO BACKFILLING AGAINST UNDERGROUND OR RETAINING WALLS SHALL OCCUR UNTIL THE WALLS HAVE ATTAINED THEIR SPECIFIED 28-DAY STRENGTHS UNLESS ADEQUATE BRACING IS PROVIDED TO RESIST HORIZONTAL LOADS IMPOSED BY BACKFILLING, EXCEPT WHERE THE DIFFERENTIAL HEIGHT OF BACKFILL ON EITHER SIDE OF THE WALL IS LESS THAN TWO FEET.

WOOD FRAMING NOTES

- ALL ROUGH FRAMING SHALL BE NO. 2 OR BETTER SPRUCE-PINE-FIR, UNLESS OTHERWISE NOTED OR SHOWN ON THE DRAWINGS.
- ALL TWO (2) INCH NOMINAL LUMBER TO BE SEASONED TO 19% MAXIMUM MOISTURE
- ALL LUMBER AND PLYWOOD SHALL BE GRADE-STAMPED BY THE APPROPRIATE MANUFACTURER'S ASSOCIATION FOR THE APPROPRIATE USE.
- ALL WOOD IN CONTACT WITH CONCRETE, MASONRY, OR EARTH SHALL BE PRESSURE TREATED WITH A CCA-C 0.40 PROCESS.
- ALL WOOD FRAMING SHALL BE BUILT PLUMB, LEVEL, SQUARE, AND TRUE WITH ADEQUATE BRACING AND CONNECTION HARDWARE TO ENSURE A RIGID STRUCTURE.
- ROUGH CONNECTIONS SHALL BE ACCURATELY CUT AND TIGHTLY FITTED AS NECESSITATED BY THE CONDITIONS ENCOUNTERED TO PROVIDE FULL BEARING WITHOUT
- ALL FLOORS AND THE ROOF SHALL BE SHEATHED WITH 3/4" TONGUE AND GROOVE STRUCTURAL 1 PLYWOOD, GLUED AND NAILED, UNLESS OTHERWISE SHOWN OR NOTED.
- ALL PLYWOOD SHALL BE LAID WITH LONG DIMENSIONS PERPENDICULAR TO SUPPORTS. STAGGER ALL JOINTS. PROVIDE BLOCKING AT ALL JOINTS ONLY WHERE SHOWN ON PLAN.
- ALL PLYWOOD SHALL BE FASTENED WITH 10d NAILS 6" ON CENTER AT SUPPORTED PANEL EDGES AND AT 10" ON CENTER AT INTERMEDIATE SUPPORTS, UNLESS OTHERWISE SHOWN OR NOTED (SPECIFIC SHEAR WALLS & DIAPHRAGMS).
- 10. ALL INTERIOR DOOR HEADERS SHALL CONSIST OF TWO 2X8'S WITH ONE LAYER OF 1/2" PLYWOOD SPACER, UNLESS OTHERWISE NOTED OR SHOWN ON THE DRAWINGS. FOR 2x6 EXTERIOR STUD WALLS, ALL EXTERIOR WINDOW AND DOOR HEADERS OVER THREE (3) FEET WIDE SHALL BE THREE 2X8'S WITH TWO LAYERS OF 1/2" PLYWOOD, U.N.O. AT EXTERIOR HEADERS, 1" THICK RIGID INSULATION MAY BE USED IN PLACE OF [2] 1/2" PLYWOOD SPACERS; LOCATE BETWEEN DOUBLE HEADER AT OUTSIDE FACE AND SINGLE HEADER AT INSIDE FACE.
- ALL HEADERS OVER SIX (6) FEET IN LENGTH SHALL REST ON DOUBLE STUD POSTS AS A MINIMUM, UNLESS OTHERWISE NOTED ON THE DRAWINGS.
- SIMPSON CONSTRUCTION HARDWARE (OR APPROVED EQUAL) SHALL BE FASTENED ACCORDING TO THE MANUFACTURER'S SPECIFICATIONS AND NAILING SCHEDULE. THE GENERAL CONTRACTOR MUST BE FAMILIAR WITH, AND HAVE THE APPROPRIATE PRODUCT CATALOGS ON SITE.
 - A. ALL SPECIFIED FASTENERS MUST BE INSTALLED ACCORDING TO THE INSTRUCTIONS IN THE SIMPSON CATALOG. INCORRECT FASTENER QUANTITY, SIZE, TYPE, MATERIAL, OR FINISH MAY CAUSE THE CONNECTION TO FAIL. 16D FASTENERS ARE COMMON NAILS (8 GAGE X 3-1/2") AND CANNOT BE REPLACED WITH 16D SINKERS (9GAGE X 3-1/4") UNLESS OTHERWISE SPECIFIED.
 - B. BOLT HOLES SHALL BE A MINIMUM OF 1/32" AND A MAXIMUM OF 1/16" LARGER THAN THE BOLT DIAMETER (PER THE 1997 NDS, SECTION 8.1.2.1.). C. INSTALL ALL SPECIFIED FASTENERS BEFORE LOADING THE CONNECTION.
 - D. PNEUMATIC NAILERS MAY BE USED TO INSTALL CONNECTORS, PROVIDED THE CORRECT QUANTITY AND TYPE OF NAILS ARE PROPERLY INSTALLED IN THE NAIL HOLES. TOOLS WITH NAIL HOLE-LOCATING MECHANISMS SHOULD BE USED. FOLLOW THE MANUFACTURER'S INSTRUCTIONS AND USE THE APPROPRIATE SAFETY EQUIPMENT.
 - E. JOISTS SHALL BEAR COMPLETELY ON THE CONNECTOR SEAT AND THE GAP BETWEEN THE JOIST AND THE HEADER SHALL NOT EXCEED 1/8".
- UNLESS NOTED OTHERWISE, MINIMUM FASTENING OF WOOD MEMBERS SHALL CONFORM TO TABLE 2305.2 OF THE MASSACHUSETTS BUILDING CODE.
- ALL PLYWOOD OR OSB SHALL BE APA RATED AND SHALL BE ADEQUATELY SPACED AT JOINTS (1/8" TYP) AS REQUIRED BY APA FOR EXPANSION.
- ALL SOLID WOOD POSTS SHALL BE DOUGLASS FIR NO. 1 OR BETTER.
- BEAMS NOTED AS "PSL" SHALL BE "PARALLAM" AS MANUFACTURED BY TRUS JOIST MACMILIAN (F=1.800.000 PSL FB=2900 PSL). PARALLAM PRODUCTS SHALL BE ADEQUATELY STORED AND COVERED AT THE JOB SITE TO BE PROTECTED FROM WATER DAMAGE PRIOR TO INSTALLATION.
- 17. BEAMS NOTED AS "LVL" SHALL BE "MICROLLAM" AS MANUFACTURED BY TRUS JOIST MACMILLAN (E=1,900,000 PSI, FB=2600 PSI). MICROLLAM PRODUCTS SHALL BE ADEQUATELY STORED AND COVERED AT THE JOB SITE TO BE PROTECTED FROM WATER DAMAGE PRIOR TO INSTALLATION.
- 18. TJI JOISTS SHALL BE BY TRUS-JOIST PRO 150 SERIES OR EQUAL WITH LVL FLANGES AND OSB WEBS. PROVIDE BRIDGING PER MANUFACTURERS RECOMMENDATIONS.
- SHEAR WALL SHEATHING SHALL BE IN ACCORDANCE WITH SHEARWALL SCHEDULE. ALL SHEETS SHALL BE STAMPED WITH THE MANUFACTURER'S INFORMATION AND SHEATHING CERTIFICATION.
- ALL STUDS SHALL ALIGN WITH TRUSSES. AT TYPICAL AREAS SUCH AS OPENING JAMBS. PROVIDE STUDS OR BLOCKING TO MAINTAIN A SOLID CONTINUOUS LOAD PATH TO

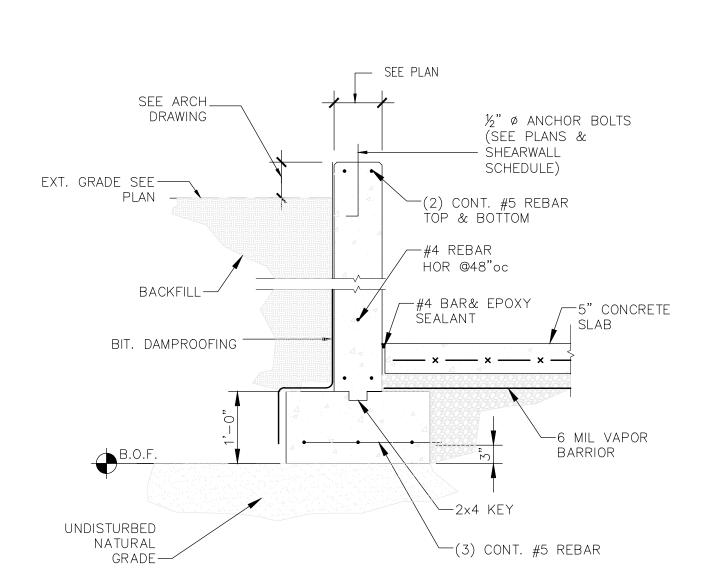

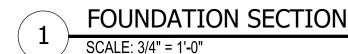

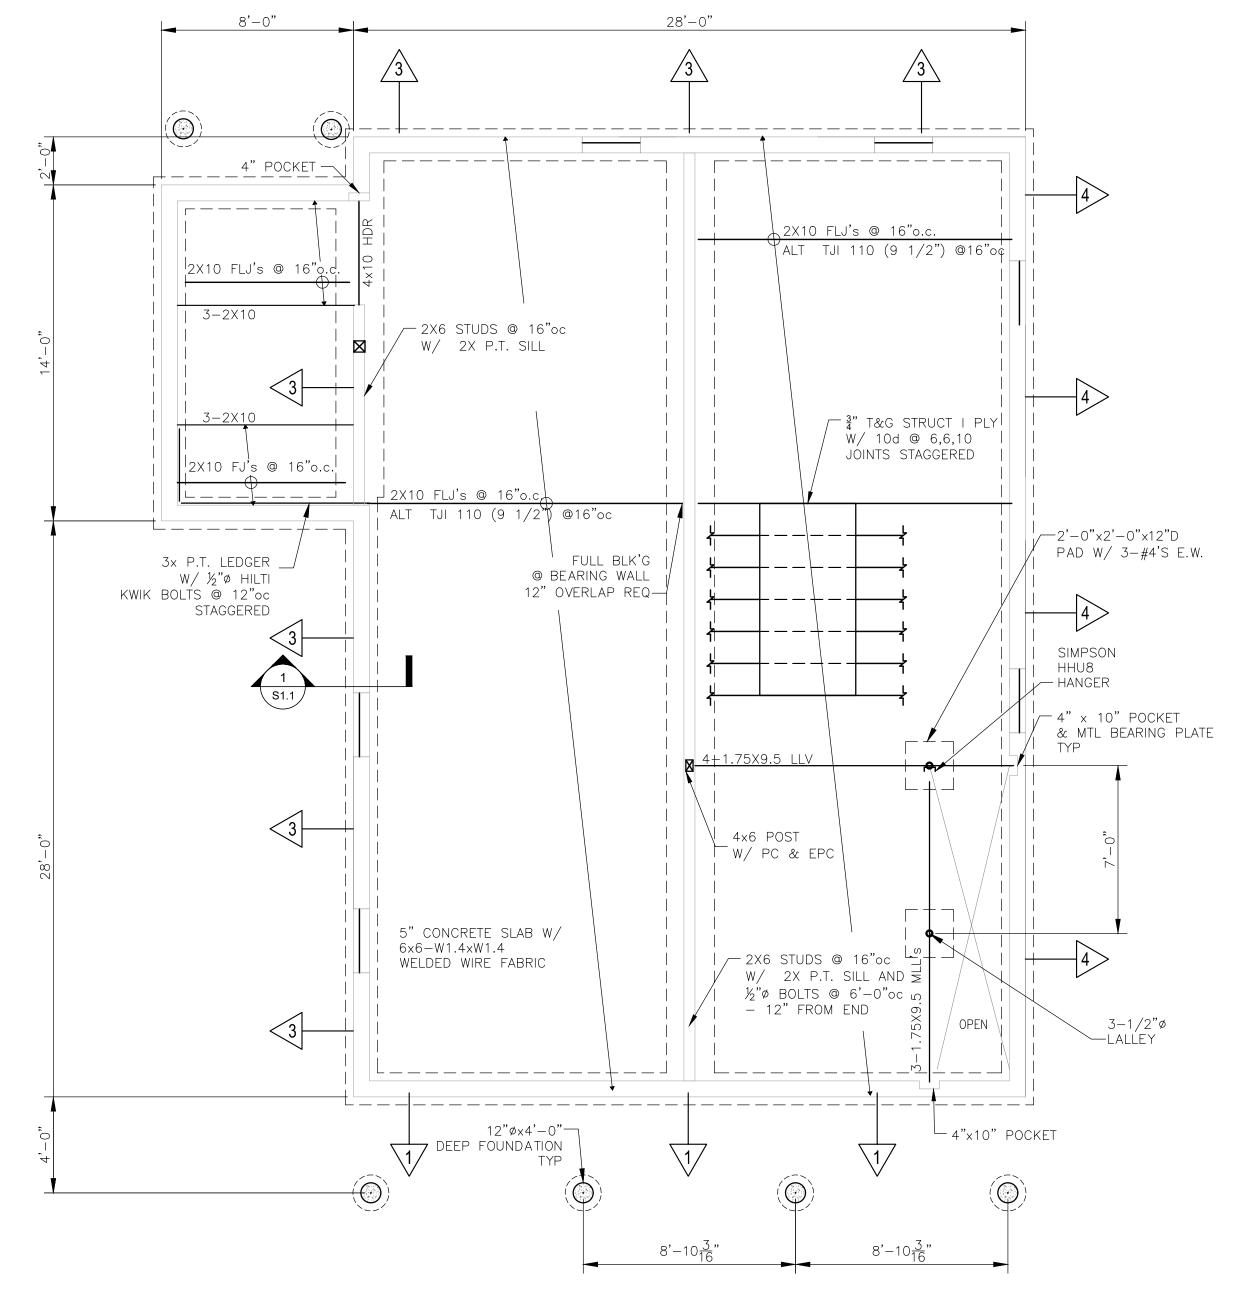

FOUNDATION / FIRST FLOOR FRAMING PLAN SCALE: 1/4" = 1'-0"



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TITLE:

PROPOSED FOUNDATION PLAN & NOTES

File No. 20013 STRUCTURAL Date 04/28/22

Sheet No

		SHEAR	PANEL SCH	HEDULE			
PANEL	PLYWOOD (3)	NAILING	q (all)	(3) NAILS	ANCHOR BOLTS	TOP PLATE ATTACHMENT	HOLD-DOWN ATTACHMENT
\triangle	7/16" CDX	8d@ 6, 6, 12	475	16d @ 6"O.C.	NA	A35 @ 20" O.C.	ST2115
2	7/16" CDX	8d@ 6, 6, 12	475	16d @ 4"O.C.	NA	A35 @ 14" O.C.	MST27
3	7/16 CDX	8d@ 6, 6, 12	475	16d @ 4"O.C.	1/2" @ 36" O.C.	A35 @ 14" O.C.	HD-5B&4X POST
4	7/16" CDX	8d@ 6, 6, 12	475	16d @ 4"O.C.	1/2" @ 48" O.C.	A35 @ 14" O.C.	HD-3B&2-2X POST
	(1)15/32" CDX	10d@ 2, 2, 12	770	16d @ 8"O.C.	1/2" @ 12" O.C.	A35 @ 6" O.C.	A35 @ 6" O.C.
6		SEE NOTE	264	16d @ 16"O.C.	1/2" @ 4' O.C.	A35 @ 30" O.C.	A35 @ 30" O.C.

NOTES:

- 1. 3X FRAMING REQUIRED AT ADJOINING PANEL EDGES
- 2. 4X OR 2-2X NAILED WITH 16d NAILS @ 6"O.C.
- 3. A35'S OT REQUIRED IF PANEL NAILS TO FRAMING MEMBER ABOVE TOP PLATE 4. ZIP BOARD MAY BE USED IN LIEU OF PLYWOOD SHEATHING.


HEADER SCHEDULE					
	2x6 STUD WALLS				
OPENING	ROOF	ONE FLR	ONE FLR + ROOF		
LESS THAN 3'-0"	2-2X6	2-2X6	2-2X6		
LESS ITIAN 5 0	2 2/(0	2 2/(0	2 2/10		
3'-1" to 5'-0"	2-2X6	2-2X8	2-2X8		
5'-1" to 7'-0"	2-2X8	2-2X10	2-2X10		
7'-1" to 8'-0"	2-2X8	2-2X10	2-2X12		

NOTES:

- 1. PROVIDE AND INSTALL HEADERS ACCORDANCE WITH THE ABOVE SCHEDULE FOR INDICATED ROUGH OPENINGS ON ARCHITECTURAL PLANS AND UNLESS NOTED OTHERWISE. HEADER SPANS EXCEEDING TABULATED VALUES SHALL BE NOTED ON FRAMING PLANS.
- 2. PROVIDE 3" MINIMUM BEARING AT EACH END.

SHEARWALL SCHEDULE


SCALE: NA

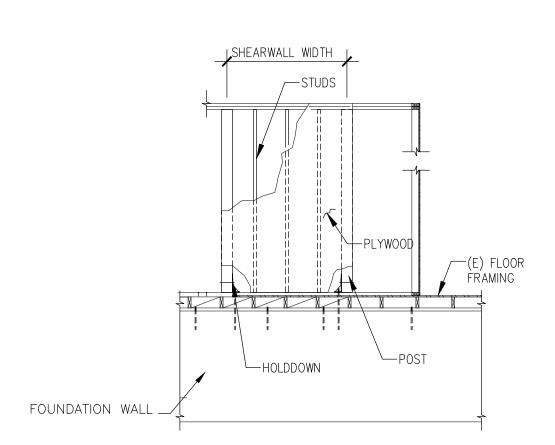

SHEARWALL DETAIL

2X RIDGE / BOARD SIMPSON LSTA 36 -一½" CDX PLYWOOD SIMPSON U26 _/ HANGERS


RIDGE STRAP

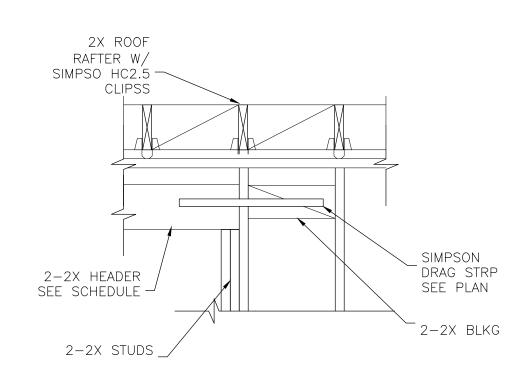


ROOF FRAMING PLAN

SCALE: 1/4" = 1'-0"

HEADER SCHEDULE

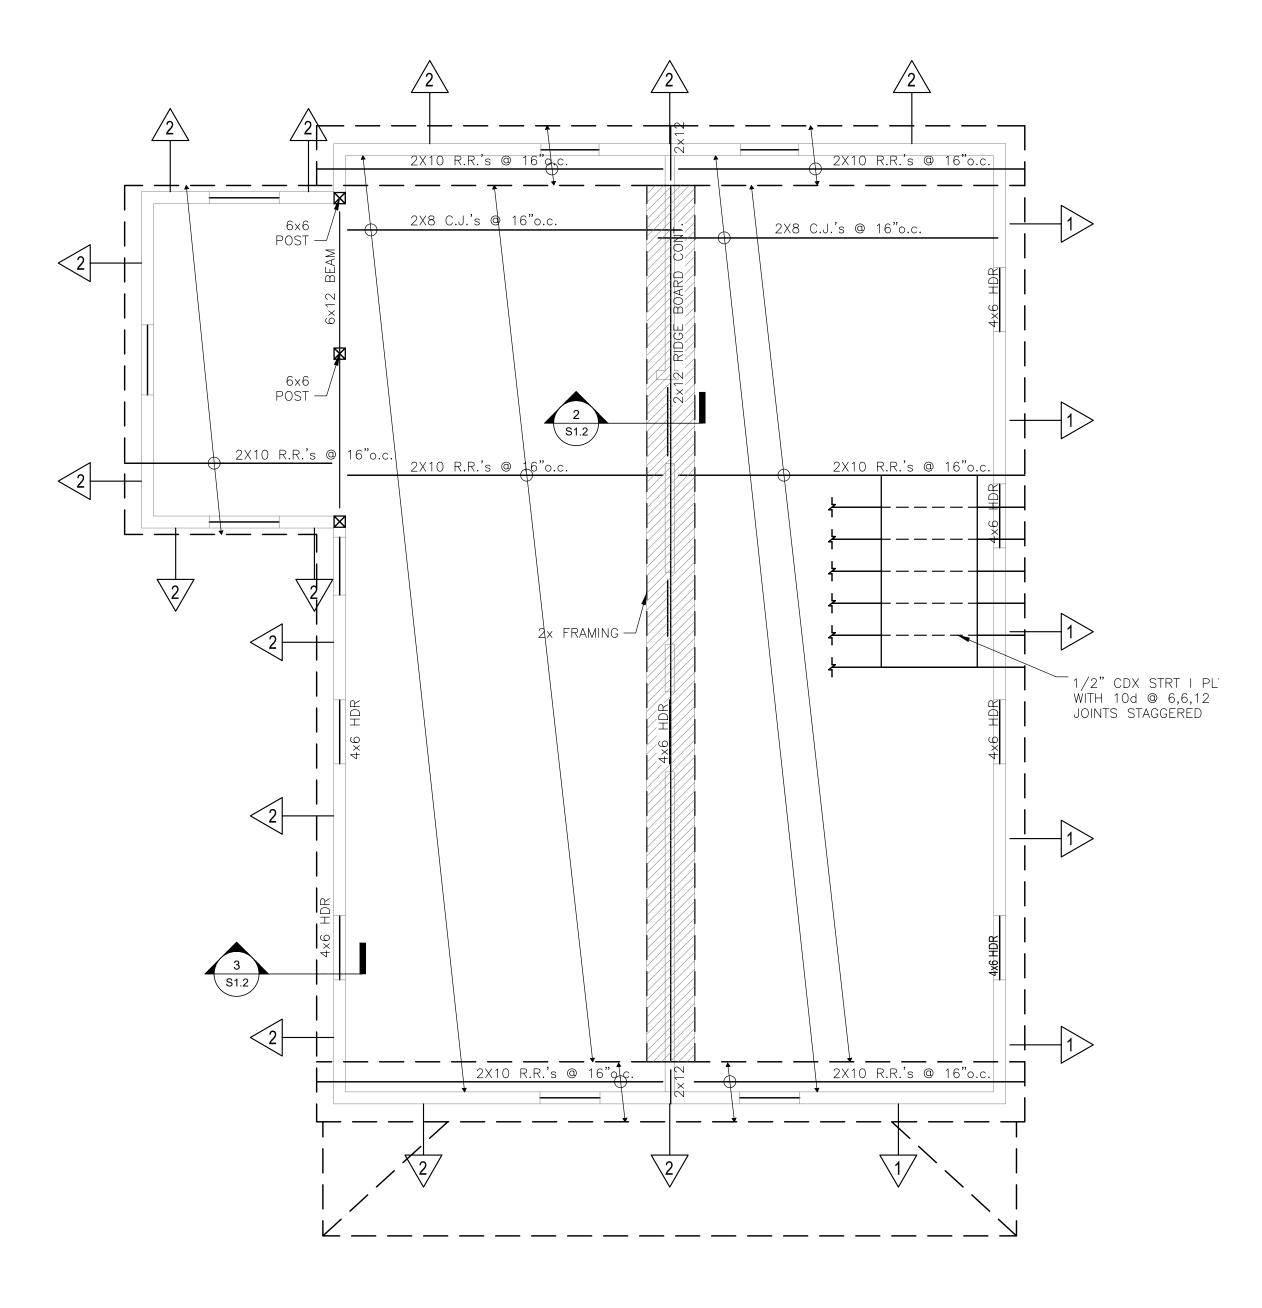

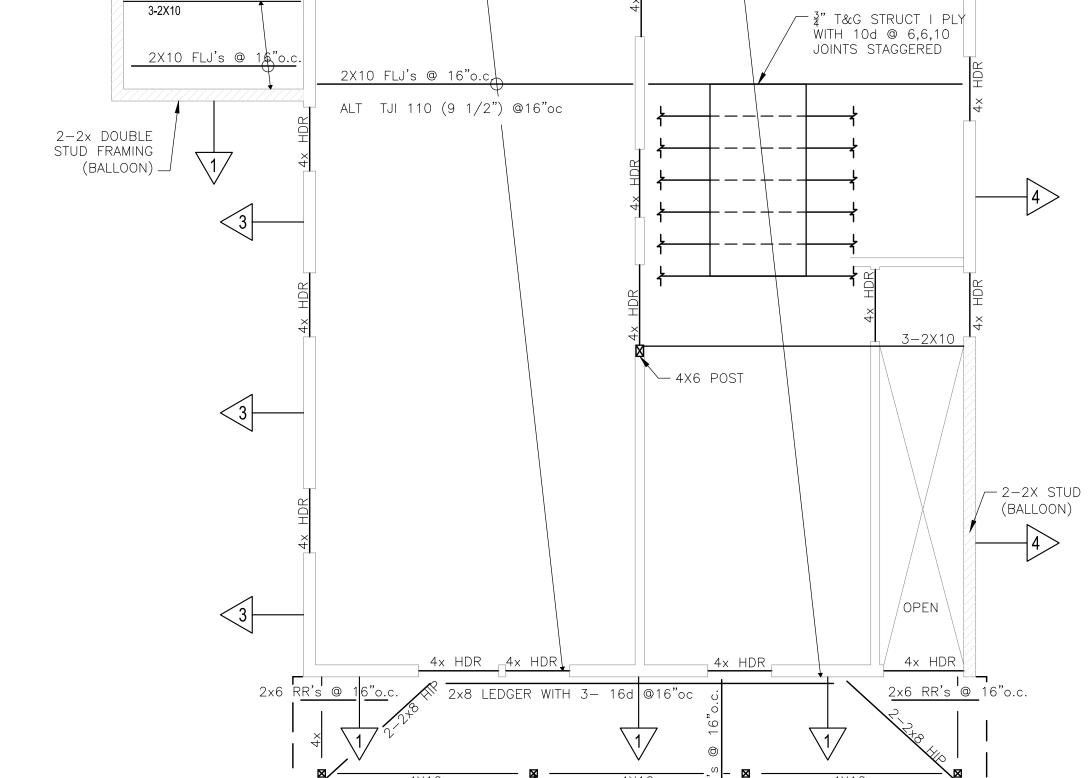

- 4x4 POST W/ CC TYP

ROOF LINE

4x HDR

<u>2X10 FLJ's</u> @ 1\$"o.c

 $3 - 2 \times 10$

4x HDR

2X10 FLJ's @ 16"o.c.

ALT TJI 110 (9 1/2") @16"oc

SECOND FLOOR FRAMING PLAN

SCALE: 1/4" = 1'-0"

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PROPOSED FRAMING PLANS & DETAILS

20013 STRUCTURAL File No. 04/28/22 Date

Sheet No

5-1.2

DRAG STRUT DETAIL

SCALE: 3/4" = 1'-0"