
# "SETTLER'S GLEN"

## COMPREHENSIVE PERMIT PLAN **RED BROOK ROAD** WAREHAM, MASSACHUSETTS

OWNER: SETTLER'S GLEN, LLC

20 NORTH PARK AVE., SUITE 4

PLYMOUTH, MA 02360

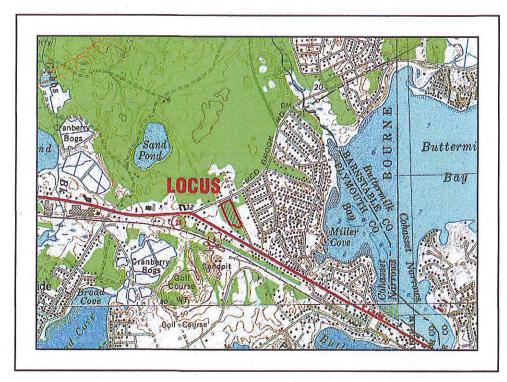

- U.S.G.S. LOCUS PLAN -

SCALE: 1"=1000'

#### SITE DATA:

ASSESSORS MAP: 8 / LOT 1007C ADDRESS: RED BROOK ROAD ZONING DISTRICT: MULTIPLE RESIDENCE 30

OVERLAY DISTRICT: GROUND WATER PROTECTION OVERLAY DISTRICT

FLOOD ZONE DATE: THE PROJECT IS LOCATED WITHIN FLOOD ZONE X. REFER TO THE F.E.M.A. FLOOD INSURANCE RATE MAP PANEL NUMBER 25023C0494J, DATED JULY 17, 2012.

#### ZONING DATA:

ZONING DISTRICT	MR-30	MR-30	PROVIDED
	(1 FAMILY DWELLING)	(2 FAMILY DWELLING	)
MIN. LOT AREA:	30,000 S.F.*	45,000 S.F.*	156,708 S.F.
MIN. FRONTAGE:	150'	200"	247.66
MIN. FRONT SETBACK:	20'	20'	21'
MIN. SIDE SETBACK:	10'	10'	16'
MIN. REAR SETBACK:	10'	10'	110'
MAX. BLDG. HEIGHT:	35'	35' R	EFER TO PLANS BY OTHERS
MAX. BLDG. COVERAGE:	25%	25%	19.9%
MAX. IMPERV. COVERAGE:	NR	NR	43.2%

\* (80% OF THE MINIMUM REQUIRED LOT AREA MUST BE CONTIGUOUS UPLAND)

G. A. F. ENGINEERING, INC. PROFESSIONAL ENGINEERS & LAND SURVEYORS 266 MAIN STREET, WAREHAM, MA 02571 TEL: (508) 295-6600 FAX: (508) 295-6634 E-MAIL: info@gafenginc.com

JANUARY 12, 2021

APPLICANT: SETTLER'S GLEN, LLC

20 NORTH PARK AVE., SUITE 4

PLYMOUTH, MA 02360



- AERIAL OVÉRVIEW -SCALE: 1"=500"

#### PLAN INDEX:

SHEET NO .:

#### PARKING DATA:

REQUIRED: 2 PARKING SPACES FOR EACH DWELLING UNIT 20 DWELLING UNITS=40 PARKING SPACES TOTAL REQUIRED=40 PARKING SPACES

PROVIDED: 40 PARKING SPACES 20 (2) CAR GARAGES=40 PARKING SPACES TOTAL PROVIDED=80 PARKING SPACES

אטאבט פרי		9	5/10/22 JMP WFM	dW5	WFM	NO CHANGE
	DATE: JAN. 12, 2021	ம	2/22/22 JMP	JMP	WFM	NO CHANGES THIS SHEET
	DRAWN BY: JMP	4	12/1/21 JMP	JWP	WFM	ONSET WATER DEPARTMENT COMMENTS
	CHECKED BY: WFM	12	8/31/21 JMP WFM	JMP	WFM	OWNER & STREET NAME CHANGE
	JOB NO.: 18-9247	64	5/11/21	dWb	WFM	NO CHANGES THIS SHEET
	SCALE. AS NOTED	-	4/26/21	dMp	WFM	PER TOWN & PEER REVIEW COMMENTS
	1	PEV	DATE	Ä	AY APP'n	DESCRIPTION



#### **GENERAL NOTES:**

- ALL UNDERGROUND UTILITIES SHOWN OR NOT SHOWN WERE COMPILED ACCORDING TO AVAILABLE RECORD PLANS AND IN PART FROM FIELD SURVEY AND ARE APPROXIMATE ONLY. ACTUAL LOCATIONS MUST BE DETERMINED IN THE FIELD. BEFORE EXCAVATING, BLASTING, BASCHILLING, BACKFILLING, GRADING, PAVEMENT RESTORATION, OR REPAIRING, ALL UTILITY COMPANIES, PUBLIC AND PRIVATE, MUST BE CONTACTED INCLUDING THOSE IN CONTINCL OF UTILITIES NOT SHOWN ON THIS PLAN. SEE MGL CHAPTER 370, ACTS OF 1963. CONTRACTORS MUST CALL DIG-SAFE AT (1-888-DIG-SAFE OR 811) G.A.F. ENGINEERING, INC. ASSUMES NO RESPONSIBILITY FOR DAMAGES INCURRED AS A RESULT OF UTILITIES OMITTED OR INACCURATELY SHOWN.
- EXISTING CONDITIONS INFORMATION IS BASED ON ACTUAL FIELD SURVEY, PRIVATE UTILITY PLANS, AND OTHER AVAILABLE SOURCES, FIELD SURVEY WAS PERFORMED BY G.A.F. ENGINEERING, INC., ON VARIOUS DATES AND MOST RECENTLY IN SEPTEMBER OF 2019.
- THE CONTRACTOR SHALL COORDINATE AND OBTAIN ALL REQUIRED PERMITS, GIVE ALL NOTICES, COMPLY WITH ALL LAWS AND REGULATIONS, AND PAY ALL FEES ASSOCIATED WITH THE INSTALLATION OF THIS WORK.
- THE CONTRACTOR SHALL FIELD VERIFY, PRIOR TO CONSTRUCTION ALL EXISTING UNDERGROUND UTILITY LOCATIONS
- THE CONTRACTOR SHALL PROVIDE ALL MATERIALS, LABOR, SUPERVISION, TOOLS, EQUIPMENT, FUEL, POWER, SANITARY FACILITIES AND INCIDENTALS NECESSARY FOR THE FURNISHING, PERFORMANCE, TESTING, START-UP AND COMPLETION OF THIS WORK.
- 6. THE CONTRACTOR SHALL NOTIFY THE ENGINEER AND OWNER OF ANY CONFLICTS DISCOVERED IN THE FIELD,
- ANY CHANGES TO THESE SITE PLANS THAT ARE MADE IN THE FIELD DURING CONSTRUCTION SHALL BE RECORDED BY THE CONTRACTOR ON RECORD DOCUMENTS AND REPORTED TO THE OWNER AND ENGINEER.
- 8. THE CONTRACTOR IS RESPONSIBLE FOR OBTAINING AN EXCAVATION AND TRENCH PERMIT PURSUANT TO 520 CMR 14.00 AS APPLICABLE PRIOR TO THE START OF CONSTRUCTION.

#### CONSTRUCTION NOTES:

- IN GENERAL, THE PLANS ARE DIAGRAMMATIC AND ARE NOT INTENDED TO SHOW EVERY FITTING, CHANGE IN DIRECTION OR DETAIL OF CONSTRUCTION.
- THE LOCATION OF UTILITIES WERE OBTAINED FROM VARIOUS SOURCES OF INFORMATION. THE EXACT LOCATION AND COMPLETENESS IS NOT GUARANTEED. THE CONTRACTOR MUST NOTIFY DIG SAFE PRIOR TO THE START OF CONSTRUCTION (1-888-DIG-SAFE OR 811). G.A.F. ENGINEERING, INC. ASSUMES NO RESPONSIBILITY FOR DAMAGES INCURRED AS A RESULT OF UTILITIES OMITTED OR INACCURATELY SHOWN.
- THE CONTRACTOR SHALL TAKE ALL NECESSARY PRECAUTIONS FOR THE SAFETY OF PERSONNEL AND PROTECTION OF PROPERTY AT THE SITE OR ADJACENT THERETO INCLUDING TREES, SHRUBS, LAWNS, PAVEMENTS, ROADWAYS, STRUCTURES AND UNDERGROUND UTILITIES NOT DESIGNED FOR REMOVAL, RELOCATION, OR REPLACEMENT.
- THE CONTRACTOR SHALL BE SOLELY RESPONSIBLE FOR THE MEANS, METHODS, TECHNIQUES, SEQUENCES, AND PROCEDURES OF CONSTRUCTION REQUIRED FOR THE INSTALLATION OF THIS WOR
- ALL MATERIALS SHALL BE NEW AND FREE FROM DEFECTS AND OF GOOD QUALITY.
- THE CONTRACTOR SHALL KEEP THE PREMISES FREE FROM THE ACCUMULATION OF WASTE MATERIAL AND OTHER DEBRIS RESULTING FROM THIS WORK.
- ALL PAVEMENT MARKINGS DISTURBED BY CONSTRUCTION SHALL BE RESTORED AS PART OF THIS WORK,
- THE CONTRACTOR SHALL INSTITUTE ALL SAFETY MEASURES NECESSARY TO PROTECT THE PUBLIC SAFETY. THIS SHALL INCLUDE, BUT NOT LIMITED TO, BARRICADES, SIGNS, LIGHTING, FENCES, POLICE DETAILS, AND ANY OTHER MEANS AS DIRECTED. NO TRENCHES ARE TO REMAIN OPEN OVERNIGHT.
- 9. ELEVATIONS ARE IN FEET AND TENTHS AND ARE BASED ON THE DATUM OF NAVD-88.
- 10. SIDE SLOPE GRADING SHALL BE AS NOTED ON THE SITE PLANS.
- 11. ALL SIDE SLOPES SHALL BE DRESSED WITH 4 INCHES OF TOPSOIL. WHERE SIDE SLOPES EXCEED 3:1, PROVIDE AN EROSION CONTROL BLANKET. OVER THE PLANTED SEED BED. SEE PLAN FOR LOCATIONS.
- 12. PERMANENT SEEDING (BEFORE SEPTEMBER 15) LIME TO PH OF 6.5 ACCORDING TO SOIL TEST OR APPLY AT THE RATE OF 100 TO 150 LBS. PER 1,000 SQUARE FEET. APPLY 10-20-20 FERTILIZER AT 1,000 LBS. PER ACRE. INCORPORATE LIME AND FERTILIZER IN TOP 4 INCHES OF SOIL. SEED 100 LBS. PER ACRE OF THE FOLLOWING SEED MIX.

PURE PERCENT

PURE PERCENT
30-35%
CREEPING RED FESCUE
30-35%
PERENNIAL RYEGRASS
20-25%
KENTUCKY BLUEGRASS
10-15%
ANNUAL RYEGRAST
HYDRO SEEDING IS AN ALTERNATIVE FOR THIS APPLICATION. A MIXTURE OF SEED WATER AND MULCH IS SPRAYED ON THE SEED BED COMBINING THREE (3) SEPARATE ACTIONS INTO ONE (1) OPERATION

- 13. ALL SEWER AND PLUMBING WORK SHALL CONFORM WITH 248 CMR 10.00 UNIFORM STATE PLUMBING CODE AND THE TOWN OF WAREHAM SEWER DEPARTMENTS SPECIFICATIONS
- 14. ALL METHODS AND MATERIALS SHALL CONFORM WITH MOSSDOT STANDARDS AND SPECIFICATIONS, AND THE REQUIREMENTS OF THE TOWN OF WAREHAM MUNICIPAL MAINTENANCE DEPARTMENT.
- 15. ALL UTILITY INSTALLATIONS SHALL BE IN CONFORMANCE WITH ALL APPLICABLE TOWN, STATE AND FEDERAL REQUIREMENTS & REGULATIONS.
- 16. DEWATERING IF REQUIRED SHALL BE DIRECTED TO A 5' MIN. DIAMETER RING OF HAYBALES OR A DIRTRAG CONTRACTOR SHALL PROVIDE AND MAINTAIN DEWATERING EQUIPMENT FOR THE CONTROL, COLLECTION AND DISPOSAL OF GROUND AND SURFACE WATER WHERE NECESSARY TO COMPLETE THE WORK.

#### **EROSION CONTROL NOTES:**

- THE SITE CONTRACTOR IS RESPONSIBLE FOR ESTABLISHING AND MAINTAINING SUITABLE EROSION AND SEDIMENTATION CONTROL DEVICES ON SITE DURING CONSTRUCTION AS REQUIRED TO PREVENT SILT FROM LEAVING THE SITE. SILT WILL NOT BE ALLOWED BEYOND CONSTRUCTION LIMITS. ADDITIONAL PROTECTION: ON—SITE PROTECTION MUST BE PROVIDED THAT WILL NOT PERMIT SILT. TO LEAVE THE PROJECT CONFINES DUE TO UNFORESEEN CONDITIONS OR ACCIDENTS.
- EROSION CONTROL MEASURES SHALL BE MAINTAINED AT ALL TIMES. IF FULL IMPLEMENTATION OF THE APPROVED PLANS DOES NOT PROVIDE SUFFICIENT EROSION AND SEDIMENT CONTROL, ADDITIONAL CONTROL MEASURES SHALL BE IMPLEMENTED. CONTRACTOR IS RESPONSIBLE FOR REPAIRING OR REPLACING EROSION CONTROL DEVICES WHICH BECOME INFFFECTIVE.
- CONTRACTOR SHALL OBTAIN ALL NECESSARY PERMITS FOR ALL GRADING AND OTHER LAND DISTURBING ACTIVITIES PRIOR TO CONSTRUCTION.
- THE CONTRACTOR IS RESPONSIBLE FOR THE CLEANUP AND REMOVAL OF ANY BUILDUP OF SEDIMENT WHICH ESCAPES FROM THE SITE.
- CONTRACTOR IS RESPONSIBLE FOR CLEANING SILT AND DEBRIS OUT OF ALL STORM DRAINAGE STRUCTURES UPON THE COMPLETION OF CONSTRUCTION.
- THE CONTRACTOR IS RESPONSIBLE FOR ALL COSTS ASSOCIATED WITH ANY FINES LEVIED AGAINST THE SITE FOR VIOLATIONS OF EROSION CONTROL REGULATIONS.
- CONTRACTOR SHALL PROVIDE TEMPORARY GROUND COVER FOR ALL AREAS WITH EXPOSED SOIL WHICH WILL NOT BE DISTURBED BY GRADING OPERATIONS FOR A PERIOD OF THIRTY DAYS OR MORE.
- IF WORK ON THIS PROJECT IS SUSPENDED FOR ANY REASON, THE CONTRACTOR SHALL MAINTAIN THE SOIL EROSION AND SEDIMENTATION CONTROL FACILITIES IN GOOD CONDITION DURING THE SUSPENSION OF WORK.
- SPRINKLE OR APPLY DUST SUPPRESSERS TO MINIMIZE DUST AT THE CONSTRUCTION SITE, MAINTAIN DUST CONTROL MEASURES UNTIL ALL DISTURBED AREAS HAVE BEEN PERMANENTLY STABILIZED.
- THE CONTRACTOR WILL ALSO NEED TO COMPLY TO ANY ORDER OF CONDITIONS THAT MAY BE ISSUED BY THE TOWN OF WAREHAM CONSERVATION COMMISSION.

#### DRAINAGE OPERATION AND MAINTENANCE SCHEDULE:

THE OPERATION AND MAINTENANCE (O&M) SCHEDULE DURING THE CONSTRUCTION PERIOD IS THE RESPONSIBILITY OF THE CONTRACTOR. THE OUTLINE BELOW SHALL BE FOLLOWED TO ENSURE THE PROPER CONSTRUCTION AND FUNCTION OF THE DRAINAGE FACILITIES.

- IN CONJUNCTION WITH THE SITE CONSTRUCTION, ALL DRAINAGE STRUCTURES SHALL BE INSTALLED AND THE AFFECTED AREAS STABILIZED (LOAM AND SEED, HYDROSEED, PLANTED, RIP-RAP, ETC.). PERMANENT STABILIZATION OF THESE AREAS SHALL BE STARTED AS SOON AS POSSIBLE.
- EROSION CONTROL SHALL BE PLACED ALONG THE LIMITS OF WORK WHERE SHOWN ON THE PLAN.
- ALL CATCH BASINS SHALL HAVE TEMPORARY SILT SACKS OR AN APPROVED EQUAL INSTALLED IN THEM AS SOON AS THE STRUCTURE IS SET, CONTRACTOR SHALL REMOVE AND DISPOSE OF THEM AT THE COMPLETION OF CONSTRUCTION. THE CATCH BASINS SHALL BE INSPECTED WEEKLY DURING CONSTRUCTION. IF THERE IS ANY SEDIMENT BUILDUP, THE AFFECTED STRUCTURES SHALL BE CLEANED IMMEDIATELY, AND ALL MATERIAL REMOVED SHALL BE DISPOSED OF IN ACCORDANCE WITH ALL APPLICABLE FEDERAL, STATE, AND LOCAL BEQUIEDLEST.
- THE LEACHING GALLEYS AND WATER QUALITY DRAIN MANHOLES BE INSPECTED WEEKLY DURING CONSTRUCTION. IF THERE IS ANY SEDIMENT BUILDUP, THE AFFECTED STRUCTURES SHALL BE CLEANED IMMEDIATELY, AND ALL MATERIA. REMOVED SHALL BE DISPOSED OF IN ACCORDANCE WITH ALL APPLICABLE FEDERAL, STATE, AND LOCAL REQUIREMENTS.
- ALL AREAS SHALL BE INSPECTED WEEKLY, AND AFTER LARGE STORMS. IF THERE IS EVIDENCE OF EROSION, THE ERODED AREA SHALL BE RE-STABILIZED, AND MEASURES SHALL BE TAKEN TO PREVENT REOCCURRENCE. THIS SCHEDULE MUST BE ADHERED TO BY THE CONTRACTOR UNTIL THE PROJECT IS ACCEPTED BY THE OWNER.

#### POST-CONSTRUCTION OPERATION AND MAINTENANCE PLAN:

UPON THE COMPLETION OF CONSTRUCTION, MAINTENANCE SHALL BE CONDUCTED BY THE OWNER OR

- STREET SWEEPING IS AN EFFECTIVE NONSTRUCTURAL SOURCE CONTROL THAT WILL REMOVE SEDIMENT FROM PAVED SURFACES. STREET SWEEPING SHOULD BE DONE BY THE USE OF A HIGH EFFICIENCY VACUUM SWEEPER OR REGENERATIVE AIR SWEEPERS TREET SWEEPING SHALL BE DONE TWICE PEAR. ONCE REMOVED FROM PAVED SURFACES, THE SWEEPINGS MUST BE HANDLED AND DISPOSED OF PROPERLY IN ONE OF THE WAYS APPROVED BY MASSDEP (SEE POLICY # BAW-18-001: REUSE & DISPOSAL OF STREET
- DEEP SUMP CATCH BASINS ARE UNDERGROUND RETENTION SYSTEMS DESIGNED TO REMOVE TRASH. DEBRIS DELP SUMP CALCH BASINS ARE UNDERGROUND RETENTION SYSTEMS DESIGNED TO REMOVE TRASH, DEBRIS AND COARSE SEDIMENT FROM STORMWATER RUNDFF AND SERVE AS TEMPORARY SPILL CONTAINMENT DEVICES FOR FLOATABLES SUCH AS OILS AND GREASE. INSPECT CATCH BASINS MONTHLY AND CLEAN AT LEAST TWO TIMES PER YEAR AND AT THE END OF THE FOLIAGE AND SMOW-REMOVAL SEASONS, SEDIMENTS MUST ALSO BE REMOVED WHENEVER THE DEPTH OF DEPOSITS IS GREATER THAN OR EQUAL TO ONE HALF THE DEPTH FROM THE BOTTOM OF THE INVERT. SEDIMENT SHALL BE REMOVED THROUGH THE USE OF A VACUUM TRUCK. SEDIMENT MUST BE HANDLED AND DISPOSED OF PROPERLY IN ONE OF THE WAYS ALREADY APPROVED BY MASSDEP (SEE MASSDEP POLICY ON MANAGEMENT OF CATCH BASIN CLEANINGS). IF THERE IS EVIDENCE THAT THEY HAVE BEEN CONTAMINATED BY A SPILL OR OTHER MEANS, THE CLEANINGS MUST BE EVALUATED IN ACCORDANCE WITH THE MASSDEP HAZARDOUS WASTE REGULATIONS, 310 CMR 30.00 AND HANDLED AS HAZARDOUS WASTE.
- PROPRIETARY MANHOLES (WATER QUALITY DRAIN MANHOLES) ARE UNDERGROUND RETENTION SYSTEMS DESIGNED TO REMOVE TRASH, DEBRIS AND COARSE SEDIMENT FROM STORMWATER RUNOFF AND SERVE AS TEMPORARY SPILL CONTAINMENT DEVICES FOR FLOATABLES SUCH AS OLLS AND GREASE. INSPECT THE UNITS MONTHLY AND CLEAN AT LEAST TWO TIMES PER YEAR AND AT THE END OF THE FOLLAGE AND SNOW-REMOVAL SEASONS. SEDIMENTS MUST ALSO BE REMOVED WHENEVER THE DEPTH OF DEPOSITS IS GREATER THAN OR FOLULA TO NOR HALF THE DEPTH FROM THE BOTTOM OF THE INVERT. SEDIMENT SHALL BE REMOVED THROUGH THE USE OF A VACUUM TRUCK, SEDIMENT MUST BE HANDLED AND DISPOSED OF PROPERLY IN ONE OF THE WAYS ALREADY APPROVED BY MASSDEP (SEE MASSDEP POLICY ON MANAGEMENT OF CATCH BASIN CLEANINGS). IF THERE IS EVIDENCE THAT THEY HAVE BEEN CONTAMINATED BY A SPILL OR OTHER MEANS, THE CLEANINGS MUST BE EVALUATED IN ACCORDANCE WITH THE MASSDEP HAZARDOUS WASTE REGULATIONS, 310 CMR 30.00 AND HANDLED AS HAZARDOUS WASTE
- LEACHING GALLEYS SHALL BE INSPECTED AFTER EVERY MAJOR STORM EVENT IN THE FIRST FEW MONTHS AFTER CONSTRUCTION TO ENSURE PROPER STABILIZATION AND FUNCTION. THEREAFTER, THE LEACHING GALLEYS SHALL BE INSPECTED AT LEAST ONCE PER YEAR. WATER DEPTH IN THE LEACHING GALLEYS SHOULD BE OBSERVED AND MEASURED AT 0, 24, AND 48-HOUR INTERVAL'S AFTER AMAJOR STORM EVENT AT LEAST ONCE PER YEAR. EXFLITATION RATES ARE CALCULATED BY DIVIDING THE DROP IN THE WATER LEVEL (INCHES) BY THE ELAPSED TIME (HOUR). A COMPARISON OF EXFLITATION RATE MEASUREMENTS TAKEN OVER THE YEARS PROVIDE A USEFUL TOOL TRACKING ANY CLOGGING PROBLEMS WITH THE UNDERGROUND INFILTRATION SYSTEM.

#### DRAINAGE INSTALLATION NOTES:

- ALL DRAINAGE PIPES, UNLESS OTHERWISE NOTED, ARE TO BE ADS N-12 PIPE WITH SOIL TIGHT JOINTS AND FITTINGS. REFER TO PLAN FOR LOCATION, SIZES AND SLOPES.
- ALL ROOF DRAIN PIPES, UNLESS OTHERWISE NOTED, ARE TO BE 4" ADS N-12 PIPE WITH SOIL TIGHT JOINTS AND FITTINGS. MINIMUM SLOPE TO BE 1.00% REFER TO PLAN FOR LOCATION.
- 3. MIN. COVER ON PIPES SHALL NOT BE LESS THAN 1.5 FEET.
- 4. WHERE REQUIRED ALL PIPE PERFORATIONS SHALL BE AASHTO CLASS II.
- ALL WORK AND MATERIAL SHALL BE DONE IN ACCORDANCE WITH THE REQUIREMENTS OF THE TOWN OF WAREHAM MUNICIPAL MAINTENANCE DEPARTMENT.
- WHERE REQUIRED CONTRACTOR TO REMOVE ALL UNSUITABLE SOILS AND REPLACE WITH CLEAN SAND AND GRAVEL APPROVED BY DESIGN ENGINEER.
- IF THE TOP COURSE OF PAVEMENT IS NOT INSTALLED IMMEDIATELY AFTER THE BASE COURSE, CATCH BASIN RIMS SHALL BE SET TO THE BASE COURSE OF PAVEMENT AND THEN RAISED WHEN THE TOP COURSE OF PAVEMENT IS INSTALLED.

#### WATER INSTALLATION NOTES:

- ALL WATER MAINS, SERVICES, GATE VALVES/GATE BOX, CURB STOPS, HYDRANTS, FITTINGS, ETC. & METHOD OF INSTALLATION SHALL CONFORM TO THE ONSET FIRE DISTRICT AND ONSET WATER DEPARTMENTS RULES & REGULATIONS.
- WATER MAIN SHALL BE PRESSURE TESTED, FLUSHED & DISINFECTED IN ACCORDANCE WITH THE ONSET FIRE DISTRICT AND ONSET WATER DEPARTMENTS REQUIREMENTS.
- CONTRACTOR TO COORDINATE WITH THE ONSET FIRE DISTRICT AND THE ONSET WATER DEPARTMENT FOR THE INSPECTIONS OF THE WATER MAIN INSTALLATION.
- THE CONTRACTOR SHALL OBTAIN ALL NECESSARY PERMITS TO COMPLETE THE INSTALLATION OF THE WATER SYSTEM.
- THE CONTRACTOR SHALL OBTAIN A COPY OF THE "ONSET FIRE DISTRICT, WATER DEPARTMENT GENERAL PROCEDURES, CONSTRUCTION SPECIFICATIONS & MATERIAL SPECIFICATIONS" FROM THE ONSET WATER DEPARTMENT BEFORE PROCEEDING WITH THE INSTALLATION OF THE WATER SYSTEM.
- ALL WATER MAINS SHALL BE RESTRAINED JOINT 8" CLASS 52 DOUBLE CEMENT LINED DUCTILE IRON PIPE WITH PUSH-ON JOINTS AND MECHANICAL JOINT FITTINGS OR
- ALL WATER SERVICE LINES SHALL BE INSTALLED A MINIMUM OF 10' FROM SEWER

CATCH BASIN GRATE

REBAR FOR FROM INLET (TYPICAL)

-BUMP STRAP

ينسس

INSTALLATION DETAIL

BAG DETAIL

2 EACH


DUMP STRAPS

EVENUSION PESTRAINT

(1/4" NYLON ROPE, 2" FLAT WASHERS)

## CATCH BASIN CONCRETE BOUND/DRILL HOLE CAPE COD BERM CAST IRON CONCRETE CLEANOUT CEMENT LINED DUCTILE IRON CORRUGATED METAL PIPE CORRUGATED PLASTIC PIPE CONCRETE THRUST BLOCK DIAMETER DIA DMH D.I. DCS DRAIN MANHOLE DUCTILE IRON DRAINAGE CONTROL STRUCTURE ELECTRIC ELEVATION EDGE OF PAVEMENT EOP EX. F.D.C. F.E.S. F.F.E. FND. FP FIRE DEPARTMENT CONNECTION FLARED END SECTION FINISHED FLOOR ELEVATION FOUND FIRE PROTECTION HANDICAP PARKING: HIGH DENSITY POLYETHYLENE HYDRANT INVERT MAXIMUM MEDIUM NOT TO SCALE NOW OR FORMERLY OVERHEAD WIRE PRECAST CONCRETE CURBING POLYVINYL CHLORIDE PIPE REMOVE AND DISPOSE REMOVE AND STOCK STONE BOUND/DRILL HOLE. SLOPED GRANITE CURBING SEWER MANHOLE STA STATION TC TW TYP. T/O/F UP UE VGC TOP OF CURB TOP OF WALL TYPICAL TOP OF FOUNDATION VERTICAL GRANITE CURB WATER GATE, WATER VALVE WG.WA WATER QUALITY STRUCTURE LEGEND

**ABBREVIATIONS** 

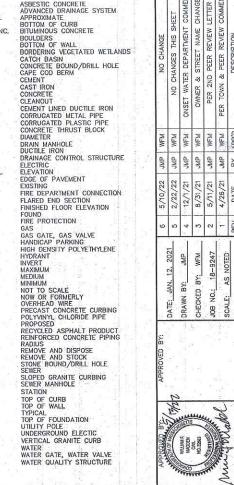




### TEST PIT DATA

SILT SACK DETAIL N.T.S.

DATE OF TESTING: AUGUST 25, 2020

PERFORMED BY: BRIAN GRADY, G.A.F. ENGINEERING INC.
REFER TO THE EXISTING CONDITIONS PLAN FOR TEST PIT LOCATIONS

CATCH BASIN

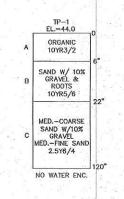

DUMP |

SILTSACK BY ACE

APPROVED EQUAL

	LLGLIND	
EXISTING	DESC.	PROPOSED
55	CONTOURS	55
53x5	SPOT GRADES	52x5 52x5
	WETLANDS	
	- 50' NO ACTIVITY ZONE	
	- 100' BUFFER ZONE	0.31 1142
	- 200' RIVERFRONT AREA	
	F.E.M.A. FLOOD ZONE	
D	DRAIN LINE	D
RD	ROOF DRAIN LINE	RD
H H	CATCH BASIN (CB)	<b>B</b>
(D)	DRAIN MANHOLE (DMH)	©
(E)	ELECTRIC MANHOLE (EMH)	©
UE	- UNDERGROUND UTILITIES	——UE
——ОНW-—	<ul> <li>OVERHEAD WIRES</li> </ul>	ОНМ
D-0-	UTILITY POLE	ு -@-
-⊕ €	- GUY POLE	-O
	WATER GATE VALVE	
Ď,	WATER SHUTOFF/CURB STOP	A. 9
H H	HYDRANT	黨黨
8	POST INDICATOR VALVE	8
w	- WATER LINE -	<del>- W</del> -
FP	- FIRE PROTECTION LINE	FP
(S)	SEWER MANHOLE (SMH)	<b>S</b>
S	- SEWER LINE	S
	TREE/BRUSH LINE	
<b>\$</b>	LIGHT POST	\$
G	- GAS LINE	——G——
	GAS GATE/VALVE	
್ಲ್ಲೈ ರ್	GAS SHUTOFF	
<b>2</b>	GAS METER	
	SIGN	

FENCE

BOUND

TEST PIT/PERC TEST SILT FENCE

GUARD RAIL FLARED END SECTION

STONE WALL

WELL

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**®** 

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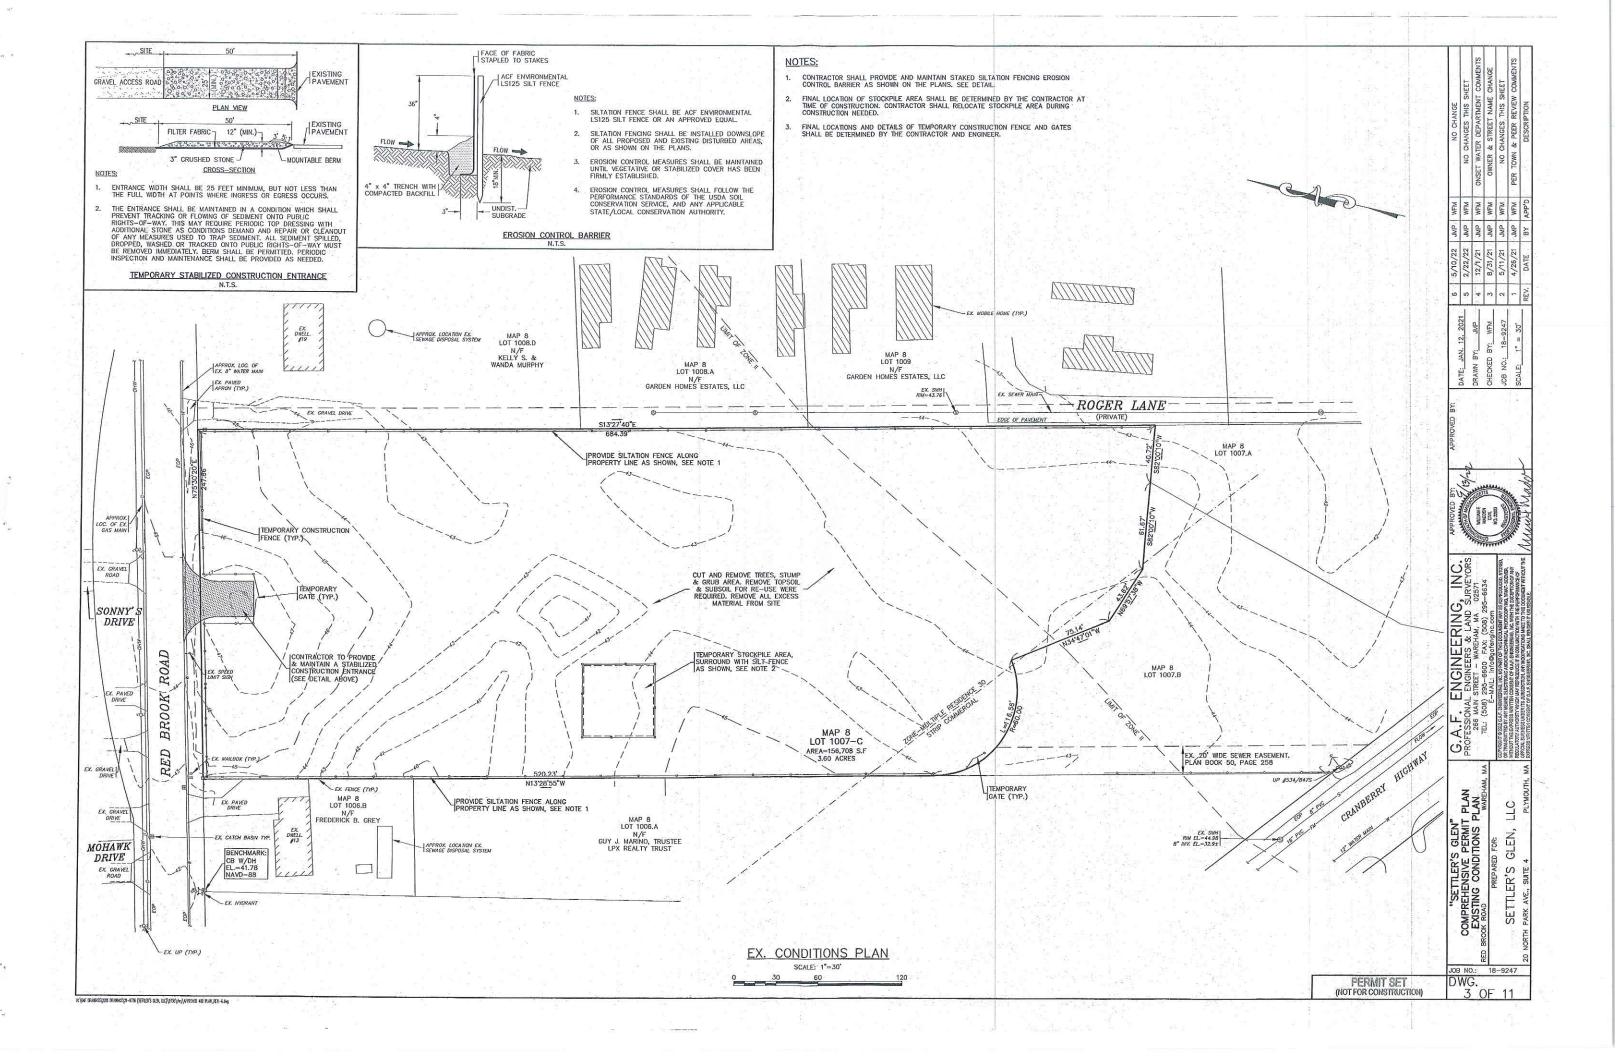
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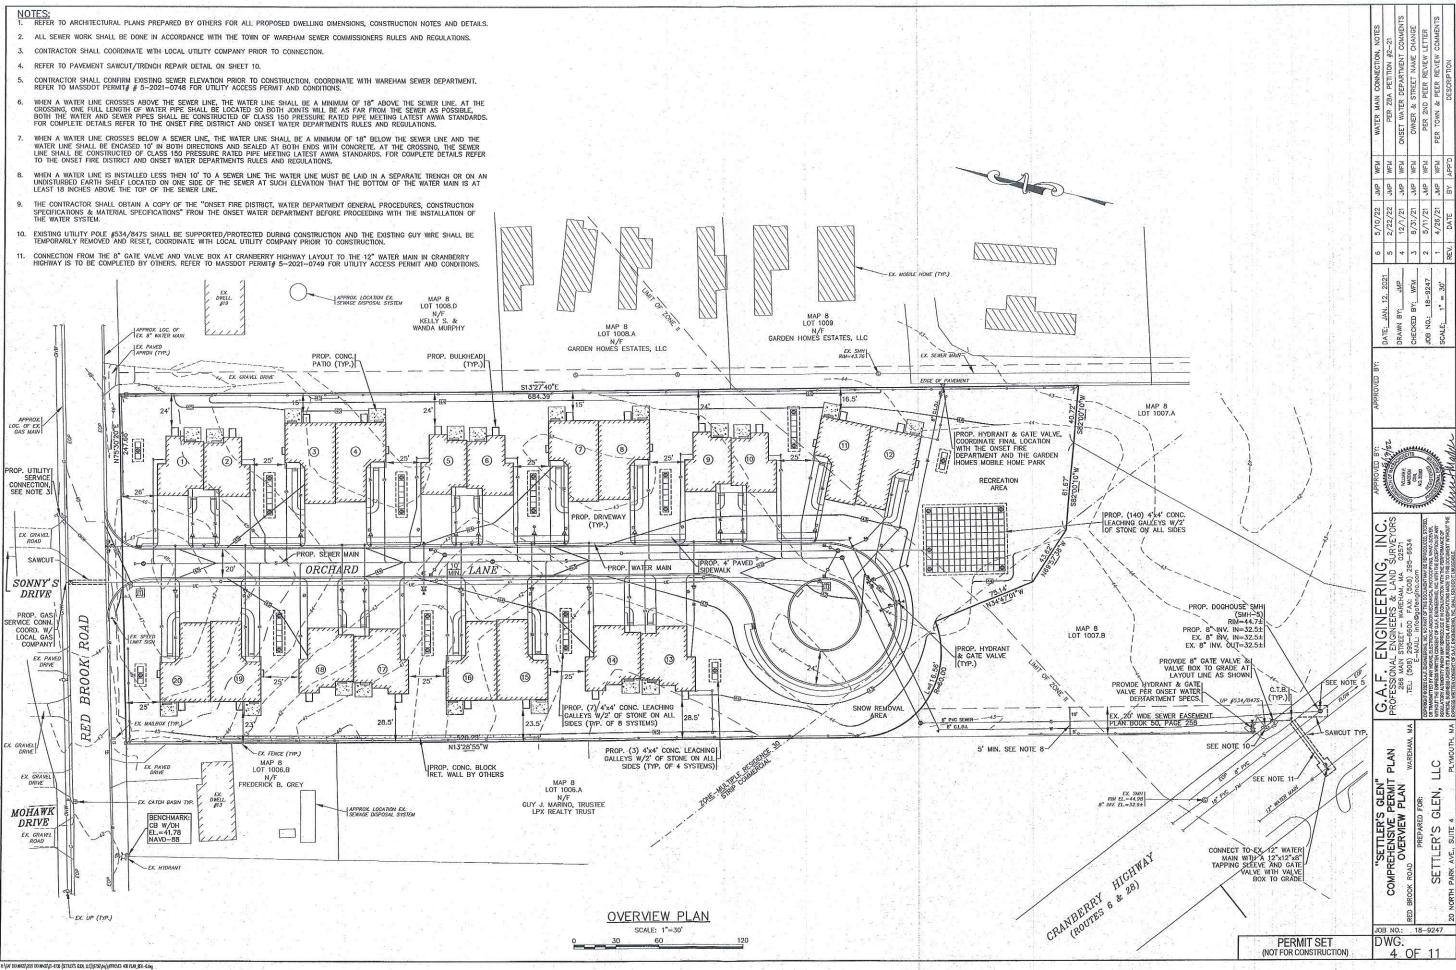
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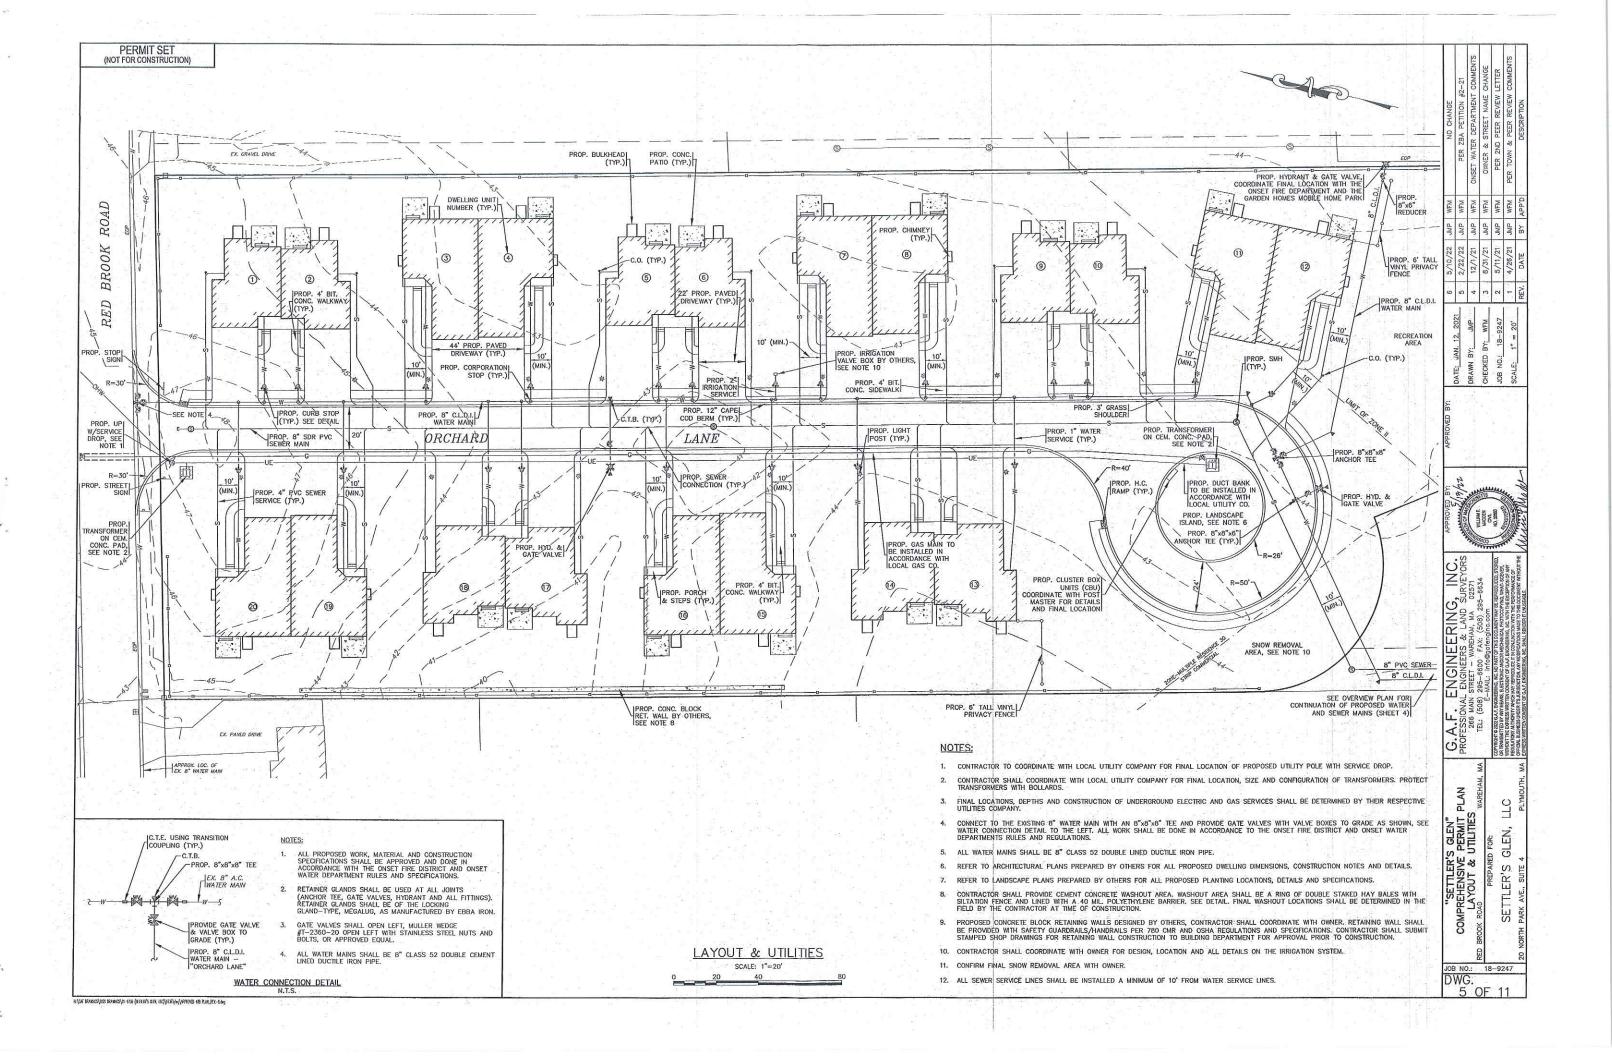
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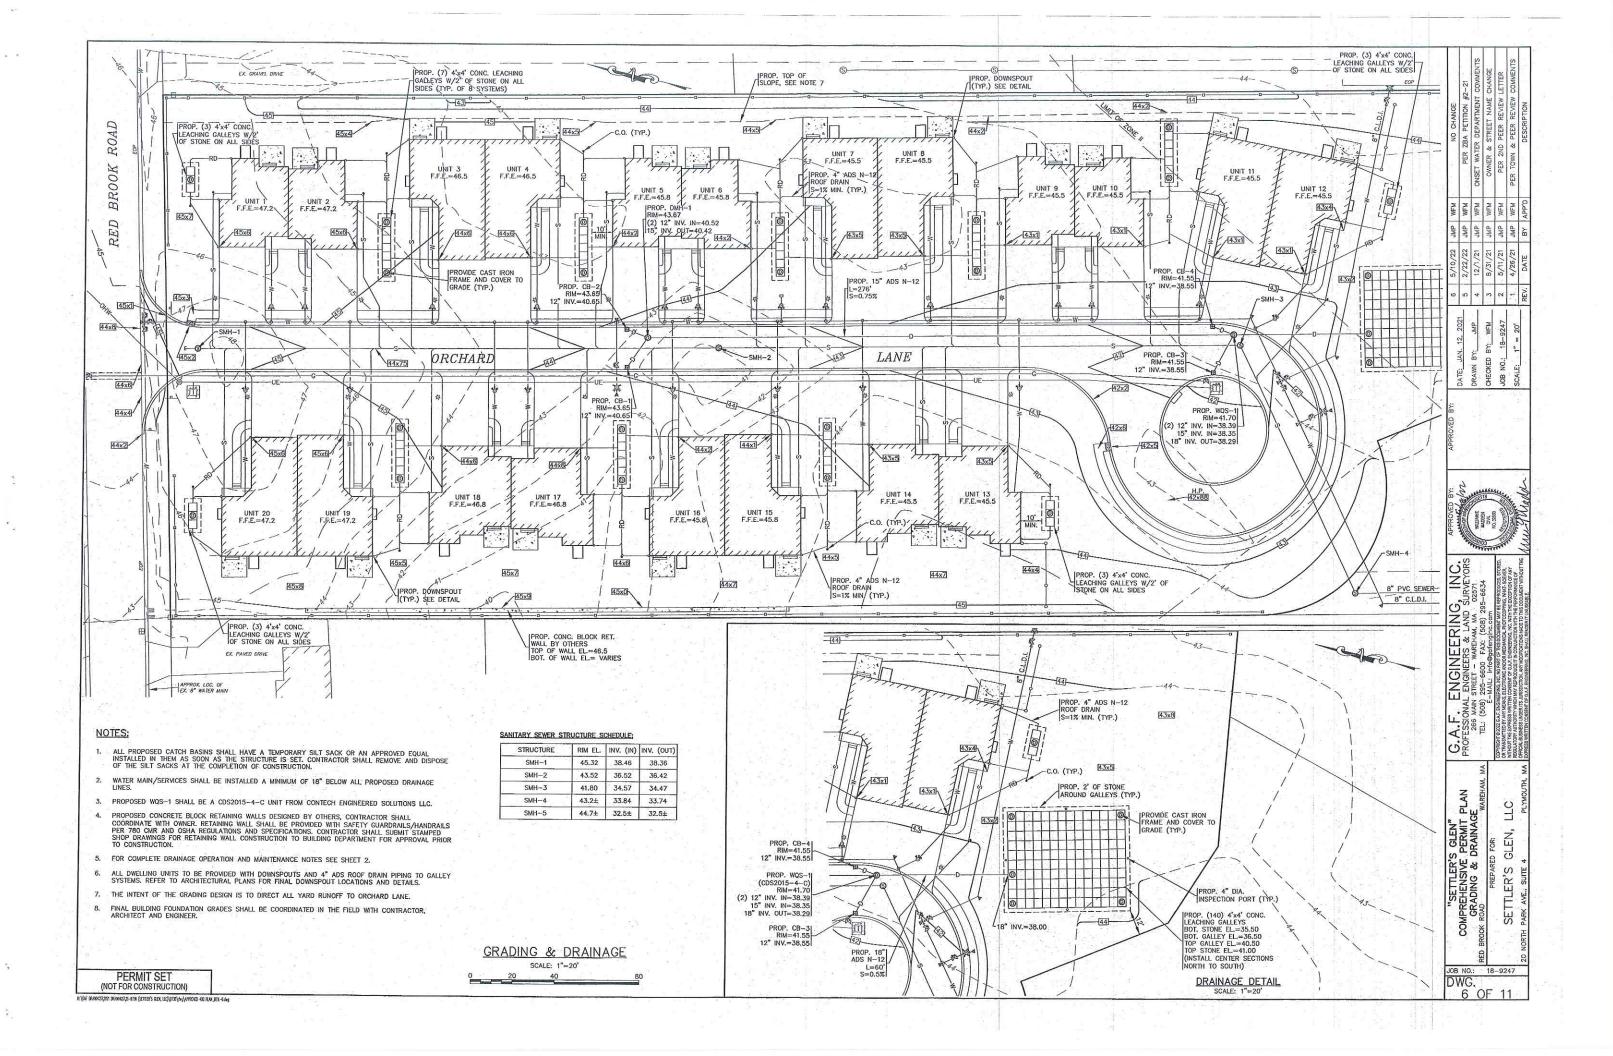
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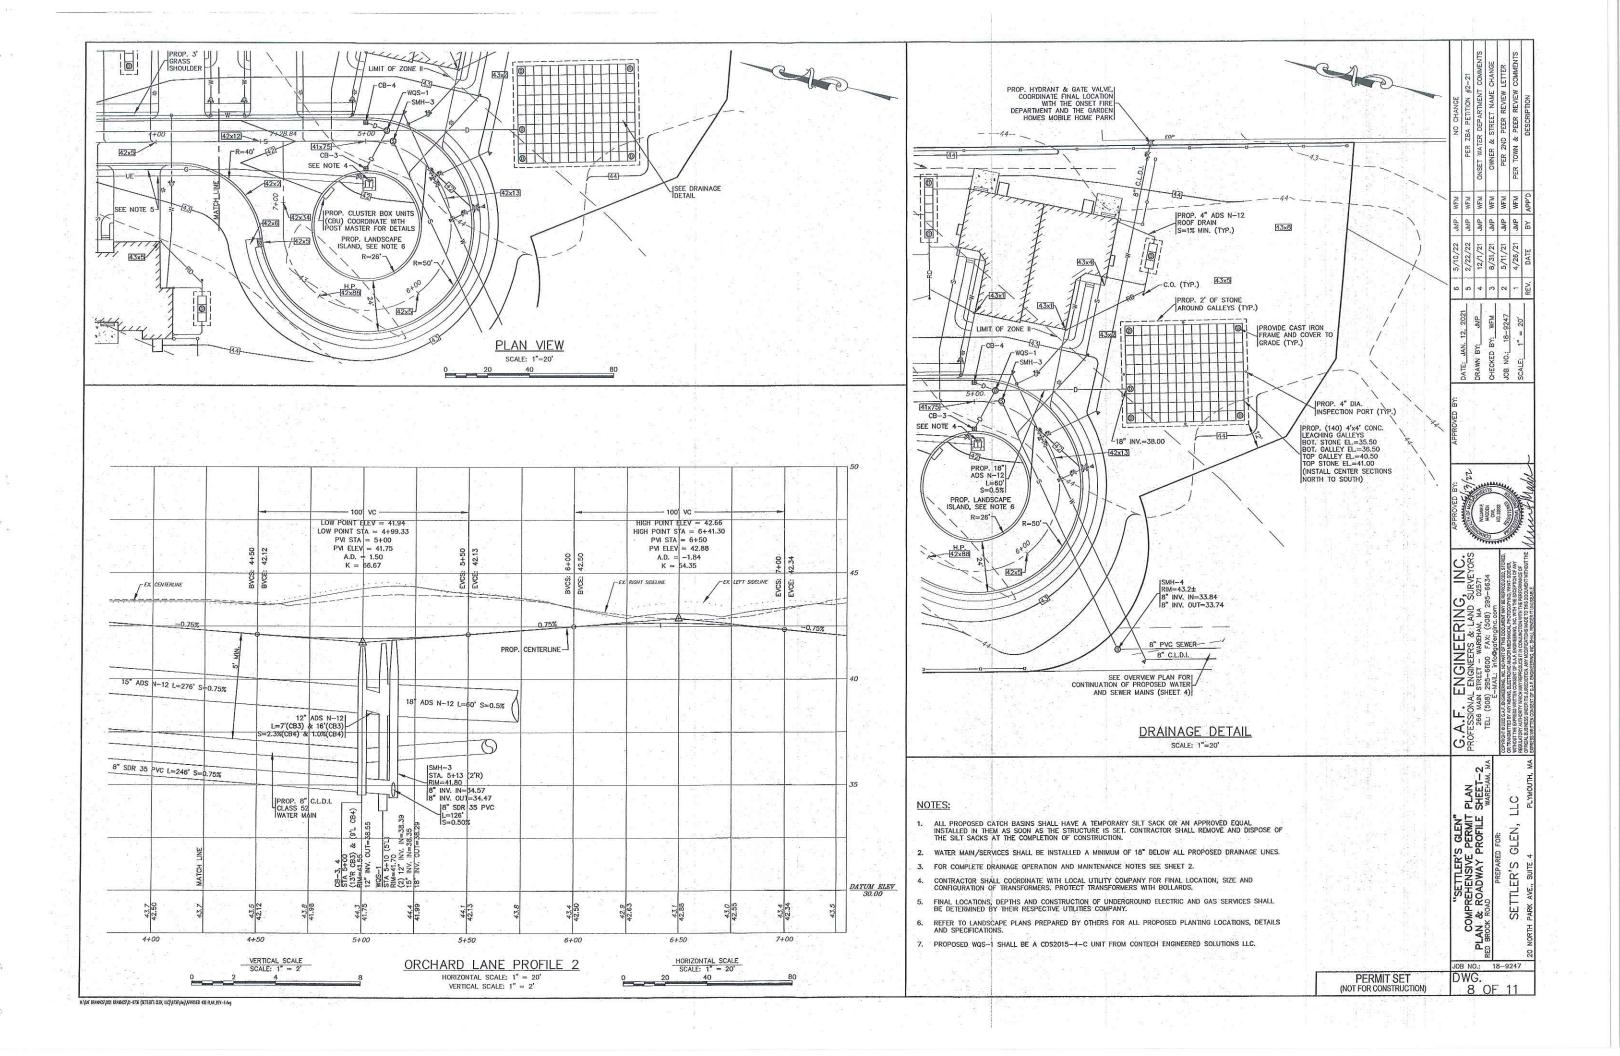
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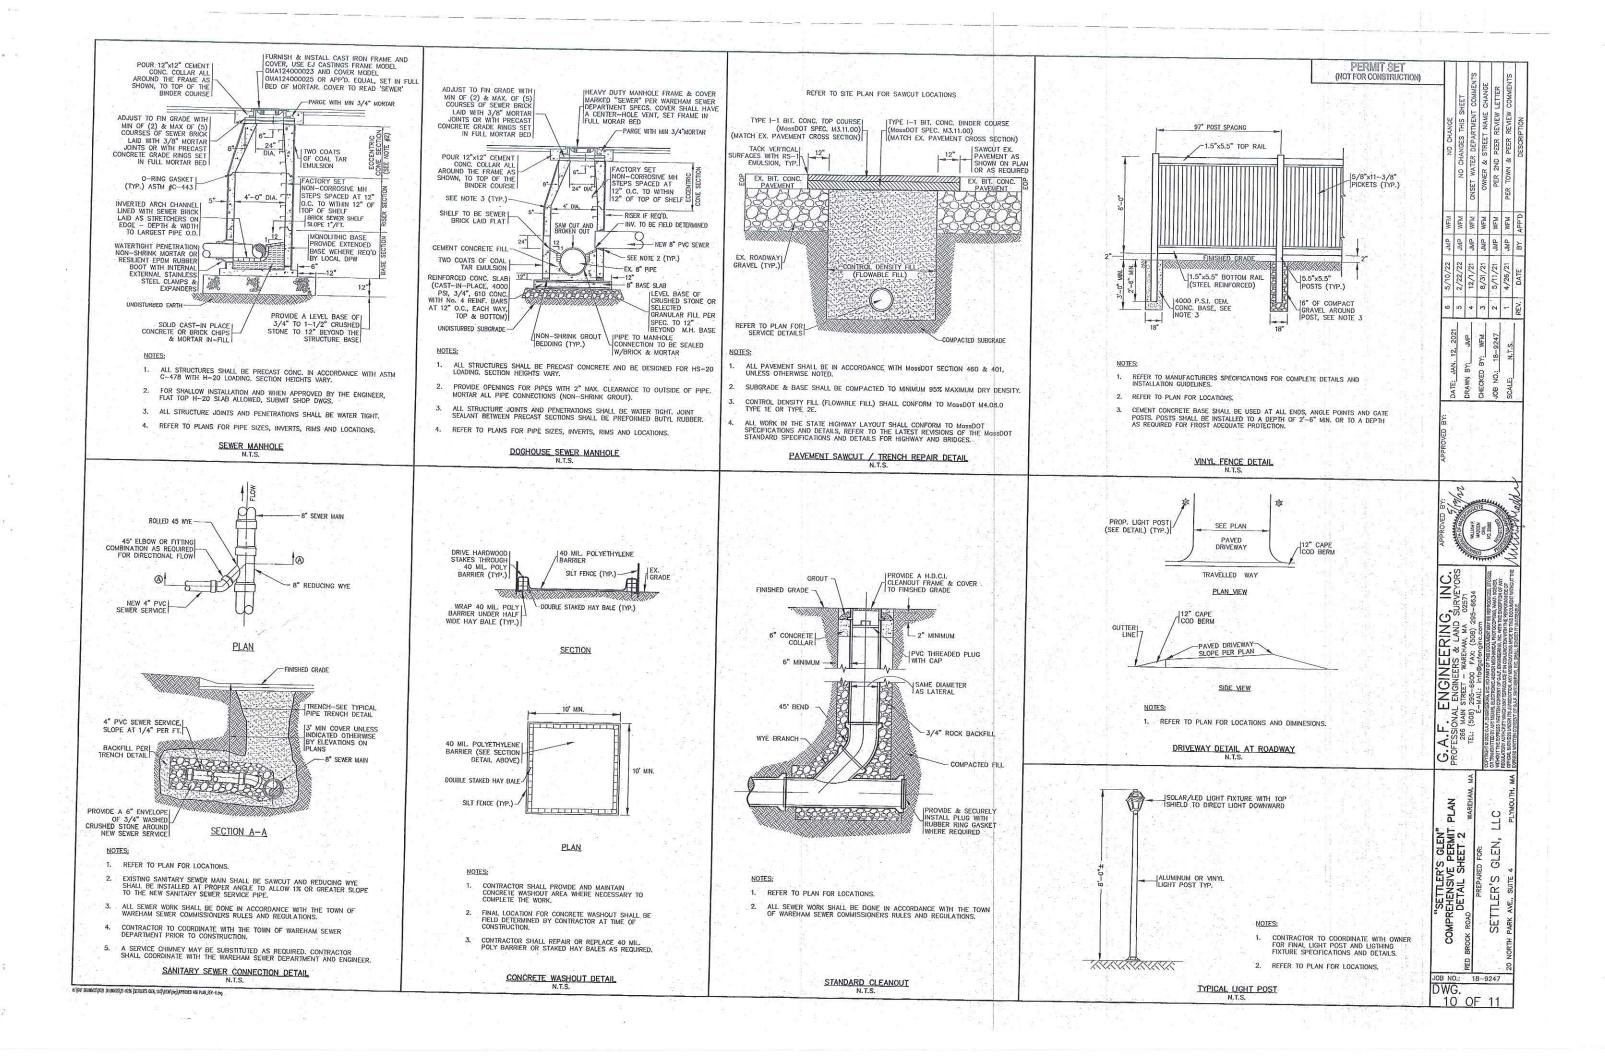













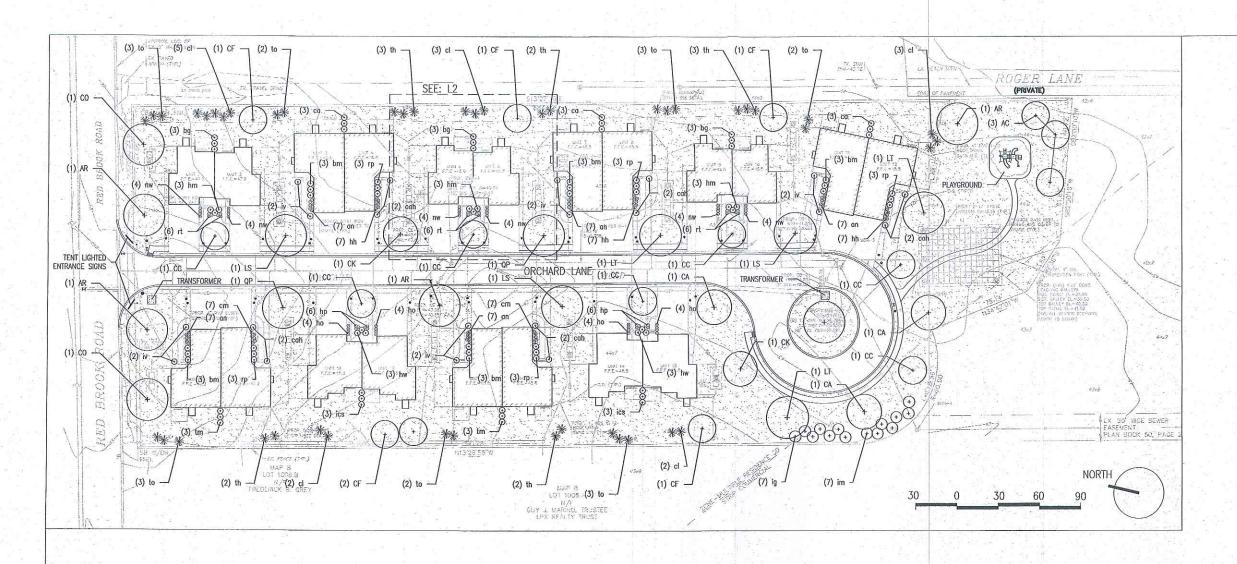


MAIN A	REA					
TREES	QTY.					
KEY		BOTANICAL NAME	COMMON NAME	SIZE	SPACING	NOTES
AR	. 3	ACER RUBRUM 'RED SUNSET'	RED SUNSET MAPLE	3" CAL.	DC 183	SPRING DIG ONLY
AC	3 .	AMELANCHIER CAN. 'AUTUMN BRILLIANCE'	SHADBLOW SERVICEBERRY	12' B&B		
CA	3	CARPINUS CAROLINIANA	AMERICAN HORNBEAM	3" CAL.		SPRING DIG ONLY
CO	2	CELTIS OCCIDENTALIS	HACKBERRY	3" CAL.	4	SPRING DIG ONLY
CC	7	CERCIS CANADENSIS 'MINN, STRAIN'	MINN. STRAIN EASTERN REDBUD	3" CAL		
CK	2	CLADRASTIS KENTUKEA	YELLOWWOOD	3" CAL	n je	SPRING DIG ONLY
CF	6	CORNUS FLORIDA 'CHEROKEE CHIEF'	CHEROKEE CHIEF DOGWOOD	3" CAL.		SPRING DIG ONLY
LS	4	LIDQUIDAMBAR STYRACIFLUA 'ROTUNDILOBA'	FRUITLESS SWEETGUM	3" CAL.		SPRING DIG ONLY
LT ·	3	LIRIODENDRON TULIPIFERA	TULIPTREE	3" CAL.	8.1	SPRING DIG ONLY
QB	1	QUERCUS BICOLOR	SWAMP WHITE OAK	3" CAL.	n en	SPRING DIG ONLY
QP ·	2	QUERCUS PALUSTRIS	PIN OAK	3" CAL.		
		157 S		¥		
SHRUBS			e <sup>2</sup> a a a a a	749		
KEY		BOTANICAL NAME	COMMON NAME	SIZE	SPACING	NOTES
bg	9	BUXUS X 'GREEN MOUNTAIN'	GREEN MOUNTAIN BOXWOOD	10 gal.	36" ht.	
ca	9	CLETHRA ALNIFOLIA	SWEET PEPPERBUSH	5 gal.	30" ht.	
cl	15	X CUPRESSOCYPARIS LEYLANDII 'MONCAL'	EMERALD ISLE LEYLAND CYPRESS	10 gal.	6-7' ht.	
ics .	6	ILEX CRENATA 'SKY PENCIL'	SKY PENCIL HOLLY	10 gal.	42" ht.	
ig	.7	ILEX GLABRA 'DENSA'	DENSA INKBERRY	5 gal.	30" ht.	
im	7	ILEX X MESERVAE 'BLUE PRINCESS'	BLUE PRINCESS HOLLY	5 gal.	36" ht.	
th .	12	THUJA OCCIDENTALIS 'HETZ WINTERGREEN'	HETZ WINTERGREEN ARBORVITAE	10 gal.	6-7' ht.	
tm	6	TAXUS X MEDIA 'HICKSII'	TAXUS X MEDIA 'HICKSII'	20 gal.	42" ht.	UPRIGHT
to	18	THUJA OCCIDENTALIS 'SMARAGD'	EMERALD GREEN ARBORVITAE	10 gal.	6-7' ht.	

NTRIES HRUBS						
KEY		BOTANICAL NAME	COMMON NAME	SIZE	SPACING NOTES	3
bm	15	BUXUS MICROPHYLLA VAR. JAP. 'WINTERGREEN'	WINTERGREEN BOXWOOD	5 gal.	30" w.	
cah	10	CLETHRA ALNIFOLIA 'HUMMINGBIRD'	SWEET PEPPERBUSH	5 gal.	30" ht. DWARF	
hw	. 6	HYDRANGEA ARBORESCENS 'WEE WHITE'	DWARF SMOOTH HYDRANGEA	5 gal.	24" ht.	
-hm	9	HYDRANGEA MACROPHYLLA 'ENDLESS SUMMER'	ENDLESS SUMMER HYDRANGEA	5 gal.	24" ht.	
iv	10	ITEA VIRGINIA 'LITTLE HENRY'	LITTLE HENRY ITEA	5 gal.	30" ht.	
rp	15	RHODODENDRON X 'PURPLE GEM'	PURPLE GEM RHODODENDRON	5 gal.	30" ht. DWARF	
PERNNIA	ALS	BOTANICAL NAME	COMMON NAME	SIZE	SPACING NOTES	
KEY an	35	ATHYRIUM NIPONICUM 'PICTUM'	JAPANESE PAINTED FERN	1 gal.	18" o.c.	
cm	14	COREPSIS 'MOONBEAM'	MOONBEAM TICKSEED	1 gal.	18" o.c.	
hh	21	HEMEROCALLIS 'HAPPY RETURNS'	HAPPY RETURNS DAYLILY	1 gal.	18" o.c.	
hp	12	HEUCHERA HYBRID 'PURPLE PALACE'	PURPLE PALACE CORAL BELLS	1 gal.	16" o.c.	
ho	16		DAYBREAK HOSTA	1 gal.	24" o.c.	
nw	24	NEPETA 'WALKERS LOW'	WALKERS LOW CATMINT	1 gal.	18" o.c.	300
rt.	18	RUDBECKIA TRILOBA	BROWN EYED SUSAN	1 gal.	18" o.c.	

WAREHAM, MASSACHUSETTS SETTLERS GLEN, LLC REVISION kz a Kyle Zick Landscape Architecture, Inc.
36 Bronfield Street Suite 202 617 451-1018 Tel
Boston, MA 02108 www.kylezick.com Job Number: Checked By: KZ Drawn By: MD Date: MAY 5, 2022 Scale: 1" = 30'-0" Drawing Title: PLANTING PLAN PERMIT SET L-1

WAREHAM

HOUSING PROJECT

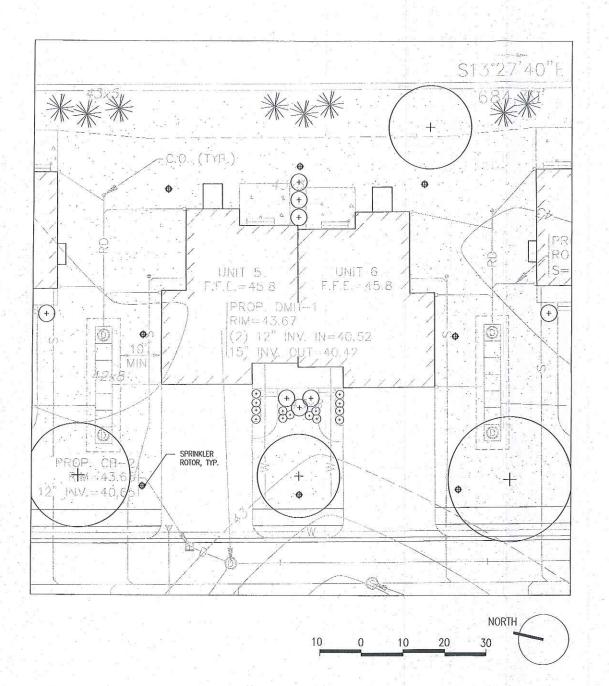

WAREHAM HOUSING PROJECT

WAREHAM, MASSACHUSETTS

SETTLERS GLEN, LLC

1. TYPICAL IRRIGATION HEAD LAYOUT TO BE FINALIZED BY OWNER
2. COMMON AREAS TO HAVE DROUGHT RESISTANT PLANTINGS PER OWNER
3. THE IRRIGATION SYSTEM WILL REQUIRE A MINIMUM OF 50 GPM @ 65 PSI WITH AN APPROXIMATE 6 HOUR WATERING WINDOW
4. THE USE IS 16-20 GPM WHEN THE SYSTEM IS RUNNING

REVISION kz a

Kyle Zick Landscape Archite 36 Bromfield Street Suite 202 Boston, MA 02108

Job Number: Drawn By: MD

Date: MAY 5, 2022 Scole: 1" = 10'-0"

Drawing Title:

IRRIGATION DIAGRAM

L-2