# SPECIAL PERMIT APPLICATION

# TOWN OF WAREHAM ZONING BOARD OF APPEALS

278 Lake Avenue E. Wareham, MA 02538

July 22, 2021

PREPARED FOR:

Karen Duke 752 School Street Stoughton, MA 02072

PREPARED BY:



# JC ENGINEERING, Inc. Civil & Environmental Engineering

2854 Cranberry Highway East Wareham, Massachusetts 02538 Ph. 508-273-0377 – Fax 508-273-0377

### TOWN OF WAREHAM

### ZONING BOARD OF APPEALS

### APPLICATION FOR A PUBLIC HEARING FOR A VARIANCE/SPECIAL PERMIT

Certain uses are allowed in several zoning districts only by means of a Variance and/or Special Permit from the Zoning Board of Appeals. Those uses are indicated in the Wareham Zoning By-Laws. To apply for a Variance/Special Permit from the Zoning Board of Appeals, please do the following:

- Complete this form.
- Complete information packets. (Directions attached)
- Submit application form and packet to Town Clerk for signature.
- o Submit application form and packet to Town Collector for signature.
- Submit completed form, packets, and appropriate fees<sup>ee</sup> to the Zoning Board of Appeals secretary.

\*\*Permits may be issued only after a public hearing. There is a filing fee of <u>\$300.00</u> per lot, per application for all non-conforming residential lots, whether built upon or not. There is a filing fee of <u>\$750.00</u> per lot, per application for all commercial applications. In the case of a multi-family development, the fee is <u>\$300.00</u> plus an additional <u>\$50.00</u> for every unit over two (2). Please make check payable to the Town of Wareham.

\*\*A check to cover two (2) legal advertisements for the public hearing should be made payable to <u>Wareham Week</u> in the amount of <u>\$100.00</u>.

"The applicant will also be responsible for the costs of sending out abutter notifications by Certified Mail. The cost is \$6.90 per certified letter to each abutter. Please see Zoning Board secretary for cost of mailings. Please make check payable to the Town of Wareham.

I hereby apply for a Variance/Special Permit for a use to be made of the following described place:

		607,0	508,609
STREET & NUMBER: 278	Lake Avenue	LOT:	MAP: 124
ZONING DISTRICT: R-13	0		
USE REQUESTED: Single	Family Residential		
OWNER OF LAND & BUI	LDING: Donald B. Coe	and Nancy G. Coe	TEL.#
ADDRESS OF OWNER:	lo Karen Duke, 752 School	Street, Stoughton	, MA 02072
PERSON(S) WHO WILL U	JTILIZE PERMIT: Sa	ime	
ADDRESS: Same		, /	
DATE: 1/15/1921	SIGNATURE:	TXA, all	VIIO
This application was received on	n the date stamped here:	Jan	fuc
Town Clerk:		Date:	
Tax Collector:		Date:	
Planning/Zoning Dept.: _		Date:	
Application fee paid:	Check #:	Rece	eipt:
Advertising fee paid:	Check #	Rece	eipt:
Abutters fee paid:	Check #	Rec	eipt:

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## JC ENGINEERING, Inc. Civil & Environmental Engineering

2854 Cranberry Highway East Wareham, Massachusetts 02538 Ph. 508-273-0377 – Fax 508-273-0367

July 22, 2021

Town of Wareham Zoning Board of Appeals Memorial Town Hall 54 Marion Road Wareham, MA 02571

RE: Special Permit Application for 278 Lake Avenue, East Wareham, MA

Dear Board Members,

On behalf of the applicant, Karen Duke, please find enclosed a Special Permit Application accompanied by supporting design drawing entitled "Proposed Site Plan located at 278 Lake Avenue, E. Wareham, MA" revised through July 16, 2021 (Plan) for your review and approval. This property is shown as Lots 607, 608, and 609 on Assessor's Map 124. The existing property contains a 1.5 story, single-family dwelling built around 1930 according to the Town Assessor's records. The applicant would like to raze and rebuild the single family dwelling on approximately the same non-conforming footprint, while adding an addition that conforms to setback requirements. Besides adding additional habitable space to the first and second floors, and reconfiguring the location of the bedrooms, the intention of the proposed expansion is to allow for habitable space to be constructed for Ms. Duke's handicapped child. This additional habitable space is proposed in the basement level walkout area of the proposed addition. In accordance with the determination issued by the Building Commissioner, a Special Permit under Article 13, Section 1355 would be required for this proposed project.

### Zoning Requirements

The property is located in the R-130 Zoning District and has street frontage on three separate roadways. The frontage on Lake Avenue is the primary access, therefore, front setback requirements are measured from Lake Avenue. Below is a list of the various zoning requirements that classifies the lot and structure as being pre-existing non-conforming.

- In accordance with Article 6, Table 621, a minimum lot area of <u>130,000</u> square feet is required in this district. The current lot contains <u>10,063</u> square feet.
- In accordance with Article 6, Table 628, minimum setback requirements for structures on lots 15,000 square feet and under are 20 feet from the front property line and 10 feet from the side and rear lot lines. The existing and proposed side setback of the structure is as close as <u>6.2 feet</u> on the west side of the structure.

Wareham Board of Appeals Page 2 April 6, 2017

As outlined in Section 1355 of the Wareham Zoning Bylaws, the Board of Appeals shall find that the replacement structure will not be substantially more detrimental to the neighborhood than the existing structure, will not cause undue nuisance or congestion to the neighborhood, nor create any new non-conformities. For the following reasons, we feel that the reconstruction of this single family dwelling will neither substantially increase the nonconforming nature of the structure, nor be substantially more detrimental to the neighborhood.

- The proposed dwelling will be constructed on approximately the same non-conforming footprint, therefore not increasing any non-conformity.
- This project also includes the construction of an addition, but the added floor area to the dwelling will not exceed the maximum allowable Gross Floor Area of <u>2,500</u> square feet. A total of <u>2,435</u> square feet of Gross Floor Area is proposed.
- The height of the structure will be no greater than the <u>35 foot</u> maximum height as stated in the Zoning Bylaws, therefore, it will not create a non-conformity. The proposed total height from average ground elevation to the peak of the roof is <u>25 feet</u>. This represent an increase of 2.5 feet above the height of the existing dwelling.
- There will be no increase in traffic or noise to the neighborhood, as this dwelling is currently a single family dwelling and will remain a single family dwelling. The typical traffic from a single family dwelling will remain the same.

For the reasons stated above, we would appreciate your favorable vote on a Special Permit for the razing and reconstruction of a single family dwelling, which is under the purview of this board.

Respectfully yours,

Beadley Bertolo

Bradley M. Bertolo, EIT, CSE Project Engineer

Cc: Karen Duke



# TOWN of WAREHAM

Massachusetts

### **BUILDING DEPARTMENT**

David L Riquinha Building Commissioner

Karen Duke C/o Bradley Bertolo, J.C Engineering 2854 Cranberry Highway Wareham, MA 02538

**RE:** 278 Lake Ave.

July 13, 2021

Map # 124, Lot # 607

We have reviewed your application to raze your existing dwelling, and reconstruct a new dwelling on the same site. The proposal, as presented, is not in compliance with current zoning regulations and must be denied at this time.

After reviewing the details of your submittal, it appears that you are looking to completely demolish the existing dwelling in order to reconstruct a new dwelling in the same location, with an increase building area, and footprint. The height, and floor area ratio are both compliant; however, the structure does not meet the side yard setback requirement of 10', and cannot be approved for construction. You will need to apply for, and secure a special permit from the Zoning Board of Appeals in order to continue with this request.

Your permit application is being denied under the following sections of the Wareham Zoning Bylaw:

- Article 6, Table 621, Residential Districts, The proposed residential dwelling does not conform to the setback requirements for the R-130 zoning district.
- Article 13 Section 1355 Non-conforming Structures: A lawfully preexisting nonconforming single family structure, may be demolished and reconstructed by <u>special permit</u>, provided that construction complies with the criteria listed in items 1-4, in section 1355, of the Wareham zoning by-law. A <u>variance</u> will be required if Board of Appeals finds the expansion to be substantially more detrimental to the neighborhood. (*ZBL §1356*)

The subject dwelling is located in Zoning district R-130.

Respectfully,

David Riquinha Building Commissioner Zoning Enforcement Officer

It is the owners' responsibility to check with other departments, i.e. Health, and conservation, etc. to ensure full compliance.

In accordance with the provisions of MGL chapter 40A §§ 15, you may apply to the Zoning Board of Appeals for the above noted relief within thirty (30) days of receipt of this letter.

### **TOWN OF WAREHAM**

APPLICANT/CONTR	<b>ACTOR/REPRESENATIVE</b>	<b>INFORMATION SHEET</b>
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# Transfer Certificate of Title

Cert. No. 101077 Book 505 Page 77 Doc. No. 503888

From Certificate No. 29376 Originally Registered 06 JUN 1960 in Registration Book 146 Page 176 for the Registry District of Plymouth County.

### This is to Certify that DONALD B COE and NANCY G COE

of Easton in the County of Bristol and Commonwealth of Massachusetts, married to each other, are the owners in fee simple, as tenants by the entirety, of that certain parcel of land situate in Wareham in the County of Plymouth and said Commonwealth, described as follows:

Being Lots 607, 608 and 609, as determined by the Court to be located upon the ground as shown on sheet 1 of plan #8702B, filed with Certificate of Title No. 2383, the same being a copy of a part of a plan drawn by Frederic O. Smith, Surveyor, dated June 15, 1926, as approved by the Court, filed in the Land Registration Office at Boston.

So much of said lots as is included within the limits of the Roads as shown on said plan is subject to the rights of all persons lawfully entitled thereto in and over the same, and said lots are also subject to the rights of flowage of the Agawam Reservoir Power & Irrigation Co., as established at date of original decrea, the flowage area being governed by the right of said Company to hold the water by its Glen Charlie Dam, so called, in the Town of Wareham to a grade of forty-two and six-tenths (42.6) feet above mean sea level.

Said lots are also subject to the reservations set forth in a certain deed from Kate D. Bourne to Joseph M. Read, dated August 22, 1917, filed and registered as document #1073.

And it is further certified that said land is under the operation and provisions of Chapter 185 of the General Laws, and that the title of said DONALD B COE and NANCY G COE

to said land is registered under said Chapter, subject, however, to any of the encumbrances mentioned in Section forty-six of said Chapter, which may be subsisting, and subject also as aforesaid.

Witness PETER W. KILBORN, Chief Justice of the Land Court at Plymouth, in said County of Plymouth, the 12th day of APRIL in the year 2002 at 09:25AM


Attest, with the Seal of said Court,


Assistant Recorder.

Land Court Case No. 8702


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MAP 124 LOT 607					
OWNER DONALD B & NANCY G COE				V 000 also a	
MAP & LOT OWNER	CO-OWNER	STREET ADDRESS	TOWN	STATE	ZIP CODE
124-281 TOWN OF WAREHAM		54 MARION RD	WAREHAM	MA	02571
124-275 RICE C JOYCE		233 PLYMOUTH AVE	E WAREHAM	MA	02538
	BURROUGHS JACQUELYN L TRUSTEES	2 PRISCILLA AVE	E WAREHAM	MA	02538
124-603 SHANKS DAVID A		646 PLYMOUTH ST	MIDDLEBORO	MA	02346
124-607 COE DONALD B & NANCY G	C/O KAREN DUKE	752 SCHOOL ST	STOUGHTON	MA	02072
124-94 FERLISI MADELINE LIFE ESTATE		<b>38 SHERMAN PLACE</b>	WOBURN	MA	01801
124-613 CATAUMET REAL ESTATE GROUP LLC		29 WASHINGTON ST	FOXBORO	MA	02035
124-610 TOBIN ANNE M		6 PARK CIR	E WAREHAM	MA	02538
124-612 FOLSOM ROY L & CHERYL A	FOLSOM SEAN M	4 PARK CIRCLE	E WAREHAM	MA	02538
124-1000 WHITE ISLAND SHORES COMMUNITY	ASSOCIATION BY TRUSTEES C/O STEPHANIE KOZAR	243 PARK AVE	E WAREHAM	MA	02538
124-601 SARAFIAN MICHAEL J ET ALS	C/O ROBERT SARAFIAN	4 BALMY LN	MIDDLEBORO	MA	02346
124-614 FIELDS MICHAEL G		36 CORNERSTONE DR	NO EASTON	MA	02536-2740
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REQUESTED BY				-	
BRADLEY BERTOLO					
JC ENGINEERING					
BBERTOLO@JCENG.ORG					



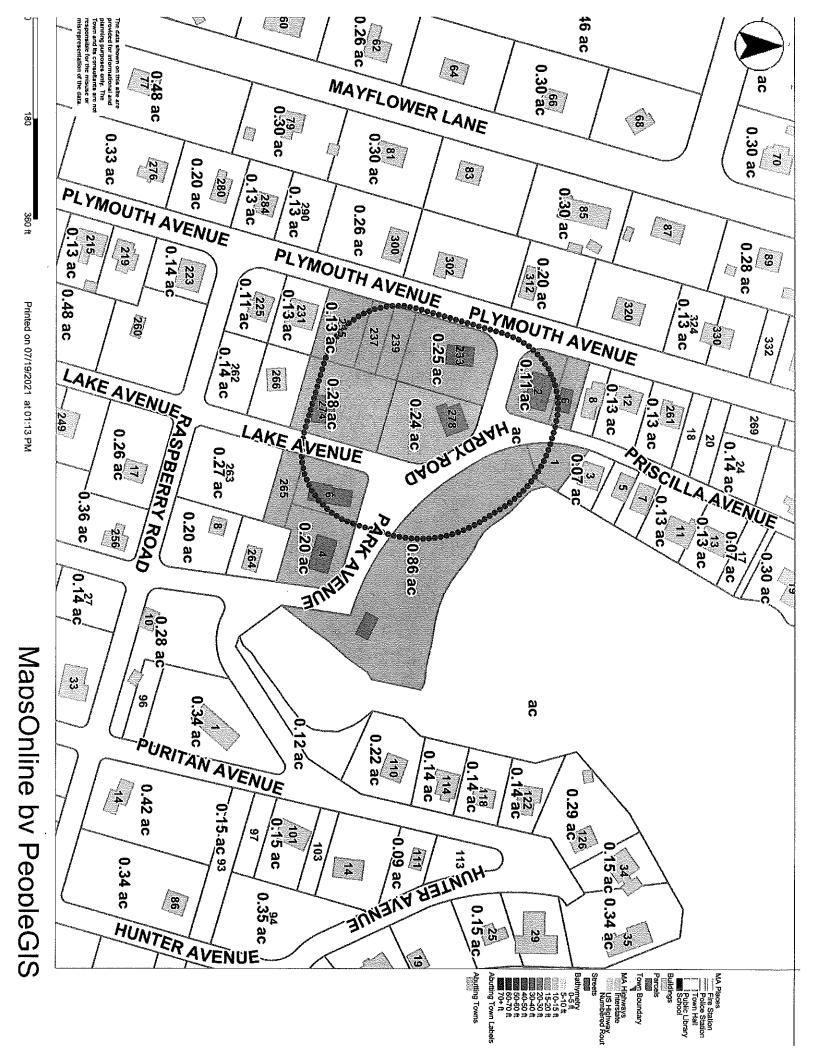
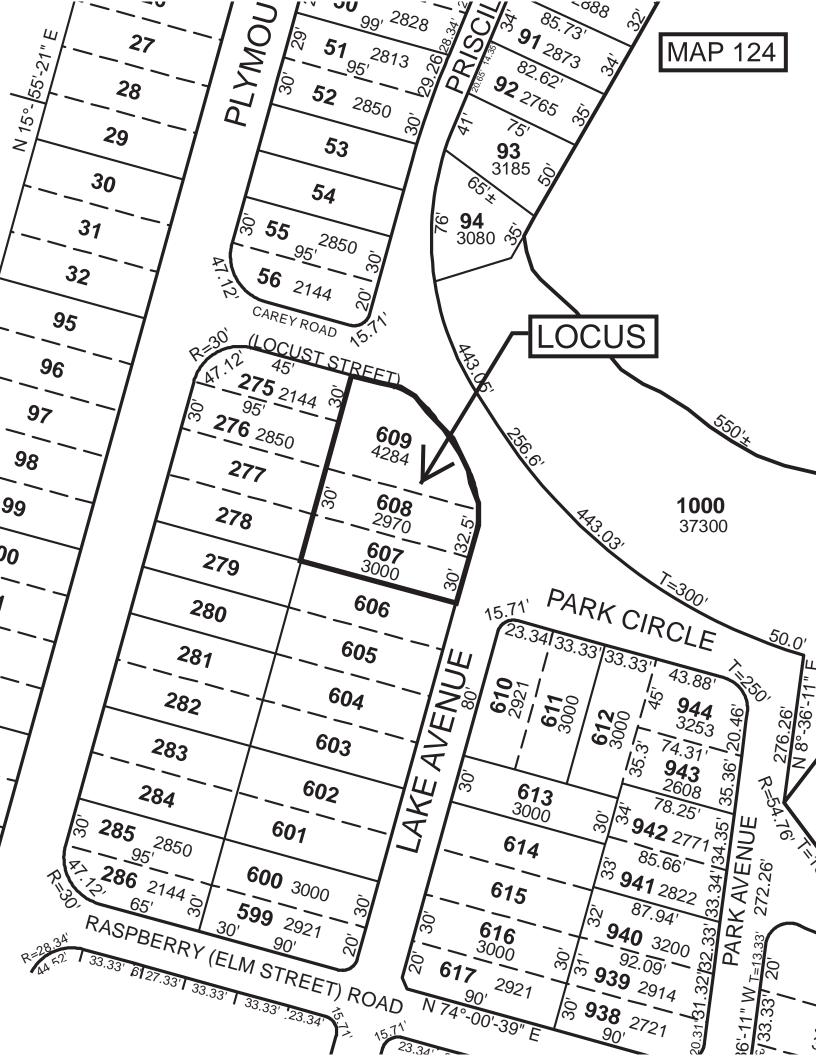
### 278 LAKE AVENUE, E. WAREHAM, MA



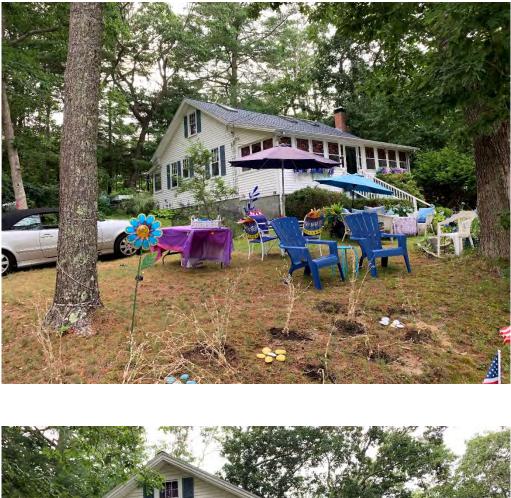







**New Construction** 

# **BEACH HOUSE RENOVATION**

# 278 Lake Avenue, Wareham, MA 02538

### **PROJECT DESCRIPTION**

These plans describe an addition and alteration to a single-family conventional-style residence built in 1930. The scope of work includes renovation to the entire existing footprint of approximately 984 SF with addition of two-story 24' x 24' space to with additional bedroom and basement garage.

The drawing set and specifications were developed by 8TFive Studio with support from team members listed in the Project Directory. 3D images for visualization purposes only.




Drawing Disclaimer: This Document contains confidential and proprietary information that cannot be reproduced or divulged, in whole or in part, without written authorization from the Architect. Do not scale from a drawing. Work to figured dimensions only. All dimensions to be checked on site prior to the execution of any work. The Copyright of these drawings belong to 8TFive Studio, LLC

	PROJECT ZO	NING DATA [Required] / (Provided)		PROJECT CODE	SUMMARY
Ľ	Assessor's Data Zoning Info Property Info	Map (124)     Parcel (607)       Zoning District (R130)     Proposed Use (Same)       Lot [130,000 SF]/(10,063 SF)     Frontage [200']/(184')	The second	Building Codes	International Residential Code (IRC) 2015 Massachusetts Building Code
Stud	Blding Setbacks	Front [20']/(27') Side [30']/(15')Rear [30']/(6.2')			Provisions of '780 CMR 51.00' 9th Edition - (Jan. 2018)
) 8TFive	Blding Restrictions Site Information Flood Zone	Coverage [NR]/(~20%)Height [35']/(~26.5')Water Supply (Public)Sewage (Septic)Within Area (No)Zone X	united and a second sec	Local Jurisdiction City, State	Zoning & General By-Laws Wareham, MA
◎ 2020	Floor Area	Exist. 1,358 SF Mod. +1,077 SF New 2,435 SF *	WHITE ISLAND	Occupancy Group Type of Construction	Residential (One/Two Family), R-3 Type V-B (Wood Construction)

DRA	WING INDEX	Revision	Date
G0.01	Cover Sheet		
G0.02	General Notes I		
	General Notes II		
	Specifications I		
	Specifications II		
G0.06	Typical Mounting		
L1.01	Site Survey & Septic		
AD1.0	Existing Basement		
AD1.1	Existing 1st Floor		
AD1.2	Existing 2nd Floor		
AD2.1	Ex. Exterior Elevations		
AD2.2	Ex. Exterior Elevations		
A1.00	Basement Plan		
	1st Floor Plan		
A1.02			
	Roof Plan & Details		
	Basement MEP Plan		
	1st FI MEP Plan		
A1.22	2nd Fl MEP Plan		
	Exterior Elevations		
A2.02	Exterior Elevations		
A3.01	Building Sections		
	High Wind Details		
	Deck Framing Details		
A5.03	Foundation Details		
A5.04	Building Details		
A6.01	Door & Window Schee	dules	
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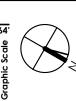
<b>ARCHITECT STAMP</b>				
	architectural design	16 Jordan Lane	East Freetown, MA 02717	(1/4) 243-2432 IIIO@0111VE.COII
REVISIONS				
ADDRESS	278 Lake Avenue, Wareham, MA 02538		CLIENT	Karen Duke
DRAWN BY	Neil Silva 06/30/2021		Project #	2020080
			SCALE	12" = 1'-0"
Cover Sheet				Permit Set
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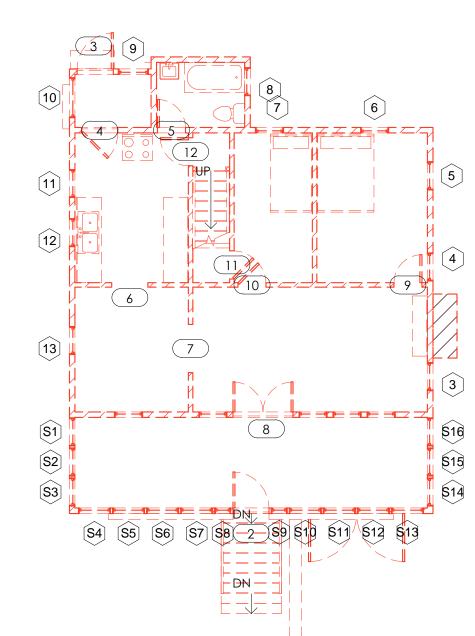


**ARCHITECT STAMP** design STUDIO 16 Jordan Lane East Freetown, MA 02717 (774) 243-2432 info@8TFive. ctural **BTFIVE** architeo REVISIONS Avenue, <sup>1</sup>. MA 02! **CLIENT** Karen Duke 278 Lake Av Wareham, ADDRESS DRAWN BY Neil Silva 06/30/2021 Project # 2020080 **SCALE** As indicated **Existing Basement** PROJECT STATUS Permit Set

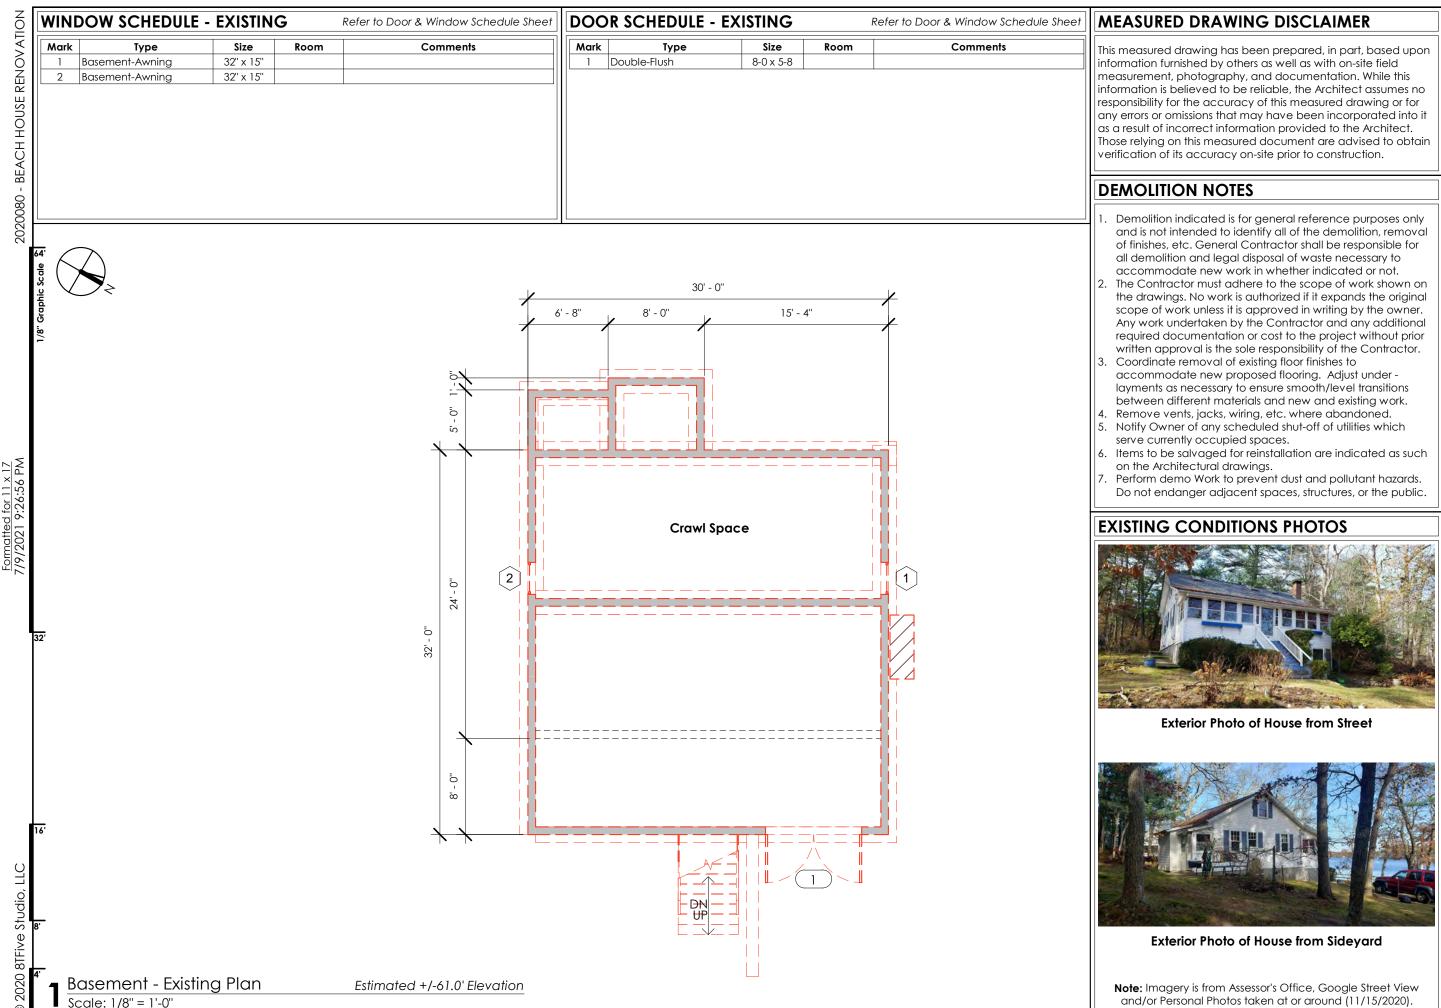

VIND	DOW SCHEDUL	E - EXISTIN	G	Refer to Door & Window Schedule Sheet		OR SCHEDULE -	EXISTING		Refer to Door & Window Schedule Sheet	MEASU
Mark	Туре	Size	Room	Comments	Mark	Туре	Size	Room	Comments	This meas
3	Double Hung 1x	2-4 x 4-6			2	Single-Flush	3-0 x 6-8			informatio
4	Double Hung 1x	2-4 x 4-6		Shutters,	3	Single-Flush	3-0 x 6-8			measurer
5	Double Hung 1x	2-4 x 4-6		Shutters,	4	Single-Entry	3-0 x 6-8			informatio
6	Double Hung 1x	2-4 x 4-6		Shutters,	5	Single-Flush	2-4 x 6-8			responsib
7	Double Hung 1x	2-4 x 4-6			6	Opening-Cased	3-0 x 6-8			any errors
8	Double Hung 1x	2-4 x 3-6		Reuse and Relocate in Bath,	7	Opening-Cased	4-0 x 6-8			Those rely
9	Double Hung 1x	2-6 x 3-6			8	Double-Flush	5-0 x 6-8		Ex. French Door to be Reused	verificatio
10	Double Hung 1x	3-4 x 3-6			9	Single-Flush	2-4 x 6-8			
11	Double Hung 1x	2-4 x 4-6		Shutters,	10	Single-Flush	2-4 x 6-8			DEMO
12	Double Hung 1x	2-4 x 3-6		Shutters,	11	Single-Flush	2-4 x 6-8			DEMO
13	Double Hung 1x	2-4 x 4-6		Shutters,	12	Single-Flush	2-4 x 6-8			
	•	· · ·			_ <u>_</u>	÷				1. Demo and is





ndicated is for general reference purposes only and is not intended to identify all of the demolition, removal of finishes, etc. General Contractor shall be responsible for all demolition and legal disposal of waste necessary to accommodate new work in whether indicated or not. The Contractor must adhere to the scope of work shown on the drawings. No work is authorized if it expands the original scope of work unless it is approved in writing by the owner. Any work undertaken by the Contractor and any additional required documentation or cost to the project without prior written approval is the sole responsibility of the Contractor. Coordinate removal of existing floor finishes to





**Note:** Imagery is from Assessor's Office, Google Street View and/or Personal Photos taken at or around (11/15/2020).



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8TFive Studio,

Existing First Floor Plan

Scale: 1/8" = 1'-0"

Refer to Civil Engineer: 68.0' Elevation

1,042 SF

### D DRAWING DISCLAIMER

Irawing has been prepared, in part, based upon hished by others as well as with on-site field photography, and documentation. While this elieved to be reliable, the Architect assumes no the accuracy of this measured drawing or for issions that may have been incorporated into it correct information provided to the Architect. this measured document are advised to obtain s accuracy on-site prior to construction.

## ON NOTES

accommodate new proposed flooring. Adjust under layments as necessary to ensure smooth/level transitions between different materials and new and existing work. Remove vents, jacks, wiring, etc. where abandoned. Notify Owner of any scheduled shut-off of utilities which serve currently occupied spaces.

Items to be salvaged for reinstallation are indicated as such on the Architectural drawings.

Perform demo Work to prevent dust and pollutant hazards. Do not endanger adjacent spaces, structures, or the public.

# **EXISTING CONDITIONS PHOTOS**

**Exterior Photo of House from Street** 

**Exterior Photo of House from Sideyard** 

**ARCHITECT STAMP** ctural design **BTFIVE STUDIO** 16 Jordan Lane East Freetown, MA 02717 (774) 243-2432 info@8TFive.com architec REVISIONS Avenue, n. MA 02! **CLIENT** Karen Duke 278 Lake Av Wareham, i ADDRESS DRAWN BY Neil Silva 06/30/2021 Project # 2020080 **SCALE** As indicated Existing 1st Floor PROJECT STATUS Permit Set

**AD1.1** 

WINDOW SCHEDULE	- EXISTING	Refer to Door & Window Schedule Sheet	DOOR SCHEDULE - E	XISTING Rei	fer to Door & Window Schedule Sheet	MEASURED
MarkType14Double Hung 1x15Double Hung 1x16Skylight17Skylight18Skylight	Size     Room       2-4 x 4-0     2-4 x 4-0       2-0 x 3-0     2-0 x 3-0       2-0 x 3-0     2-0 x 3-0	Comments Shutters, Shutters,	MarkType13Opening-Cased14Opening-Cased15Bifold-4 Panel	Size     Room       2-6 x 6-8     2       2-6 x 6-8     4-0 x 6-8	Comments	This measured dro information furnish measurement, ph information is beliv responsibility for th any errors or omiss as a result of incol Those relying on th verification of its o
1/8" Graphic Scale &						<b>DEMOLITION</b> 1. Demolition indiand is not inter of finishes, etc. all demolition a accommodat     2. The Contracto the drawings.     scope of work     Any work under required docuwritten approv     3. Coordinate relaccommodat     4. Remove vents     5. Notify Owner of serve currently     6. Items to be salid on the Architer     7. Perform demoder <b>Dot EXISTING CO</b>
32'					14	Exter
<del>16'</del> 8						Exterior
$\frac{4}{1} \frac{\text{Existing Second I}}{\text{Scale: 1/8"} = 1'-0"}$	Floor Plan	~ 76.0' Elevation 316 SF				Note: Imagery and/or Persor

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### DRAWING DISCLAIMER

rawing has been prepared, in part, based upon ished by others as well as with on-site field photography, and documentation. While this elieved to be reliable, the Architect assumes no the accuracy of this measured drawing or for issions that may have been incorporated into it orrect information provided to the Architect. this measured document are advised to obtain accuracy on-site prior to construction.

## N NOTES

ndicated is for general reference purposes only ended to identify all of the demolition, removal c. General Contractor shall be responsible for n and legal disposal of waste necessary to ate new work in whether indicated or not. tor must adhere to the scope of work shown on s. No work is authorized if it expands the original rk unless it is approved in writing by the owner. dertaken by the Contractor and any additional cumentation or cost to the project without prior oval is the sole responsibility of the Contractor. removal of existing floor finishes to

ate new proposed flooring. Adjust under necessary to ensure smooth/level transitions ferent materials and new and existing work. nts, jacks, wiring, etc. where abandoned. r of any scheduled shut-off of utilities which tly occupied spaces.

alvaged for reinstallation are indicated as such ectural drawings.

no Work to prevent dust and pollutant hazards. nger adjacent spaces, structures, or the public.

# CONDITIONS PHOTOS



erior Photo of House from Street




ior Photo of House from Sideyard

ry is from Assessor's Office, Google Street View onal Photos taken at or around (11/15/2020).

**ARCHITECT STAMP STFIVE STUDIO** architectural design 16 Jordan Lane East Freetown, MA 02717 (774) 243-2432 info@8TFive.com REVISIONS Avenue, n, MA 02538 **CLIENT** Karen Duke 278 Lake Av Wareham, N ADDRESS **DRAWN BY** Neil Silva 06/30/2021 **Project #** 2020080 **SCALE** As indicated **Existing 2nd Floor** PROJECT STATUS Permit Set

AD1.2

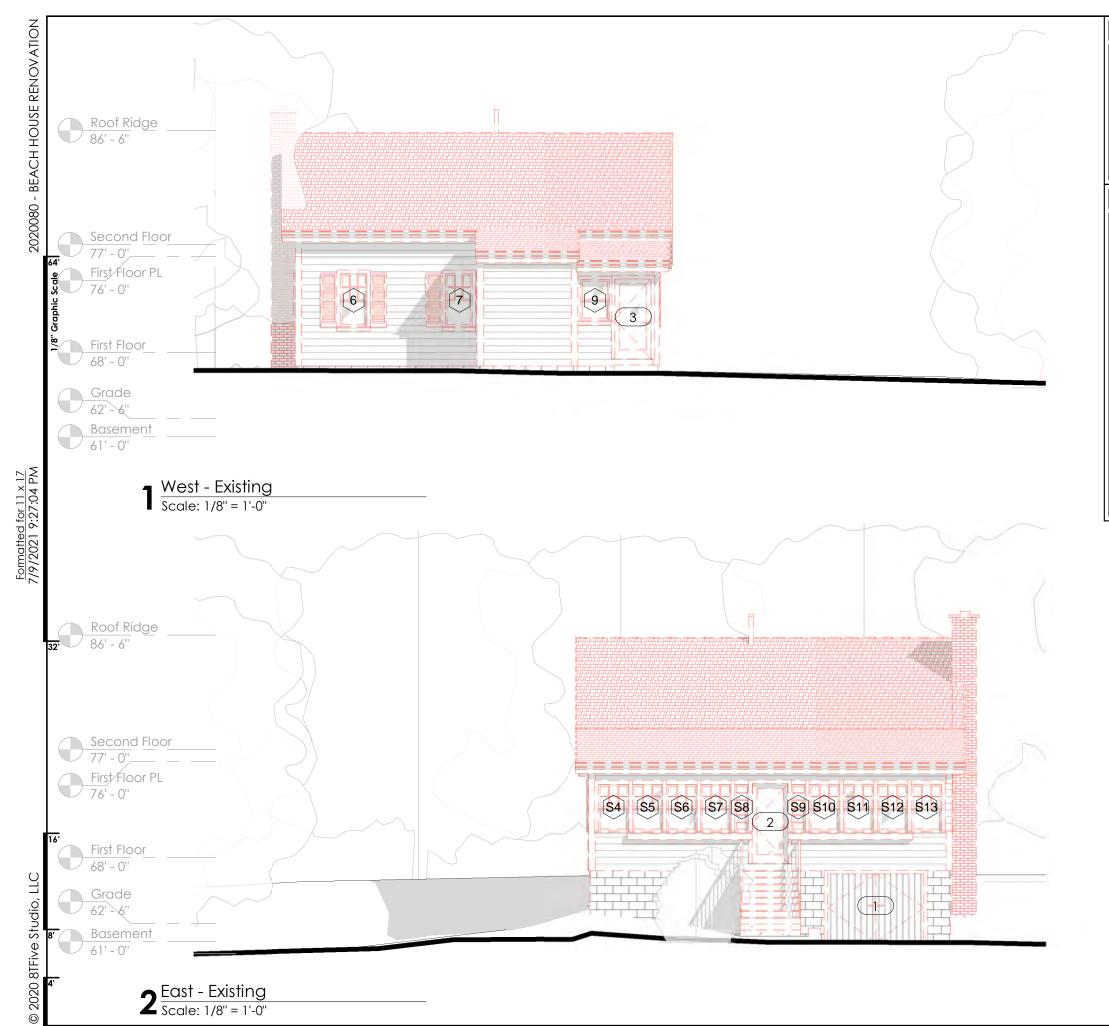

This measured drawing has been prepared, in part, based upon information furnished by others as well as with on-site field measurement, photography, and documentation. While this information is believed to be reliable, the Architect assumes no responsibility for the accuracy of this measured drawing or for any errors or omissions that may have been incorporated into it as a result of incorrect information provided to the Architect. Those relying on this measured document are advised to obtain verification of its accuracy on-site prior to construction.

# DEMOLITION NOTES

- 6.

### MEASURED DRAWING DISCLAIMER

Demolition indicated is for general reference purposes only and is not intended to identify all of the demolition, removal of finishes, etc. General Contractor shall be responsible for all demolition and legal disposal of waste necessary to accommodate new work in whether indicated or not. The Contractor must adhere to the scope of work shown on the drawings. No work is authorized if it expands the original scope of work unless it is approved in writing by the owner. Any work undertaken by the Contractor and any additional required documentation or cost to the project without prior written approval is the sole responsibility of the Contractor. Coordinate removal of existing floor finishes to


accommodate new proposed flooring. Adjust under layments as necessary to ensure smooth/level transitions between different materials and new and existing work. 4. Remove vents, jacks, wiring, etc. where abandoned. 5. Notify Owner of any scheduled shut-off of utilities which serve currently occupied spaces.

Items to be salvaged for reinstallation are indicated as such on the Architectural drawings.

Perform demo Work to prevent dust and pollutant hazards. Do not endanger adjacent spaces, structures, or the public.

Ex. Exterior Elevations	ations	DRAWN BY	ADDRESS	REVISIONS		<b>ARCHITECT STAMP</b>
		Neil Silva 06/30/2021	278 Lake Avenue, Wareham, MA 02538		architectural design	
					16 Jordan Lane	
<b>PROJECT STATUS</b>	SCALE	Project #	CLIENT		East Freetown, MA 02717	
Permit Set	As indicated 2020080	2020080	Karen Duke		(774) 243-2432 INIO@81FIVE.COM	



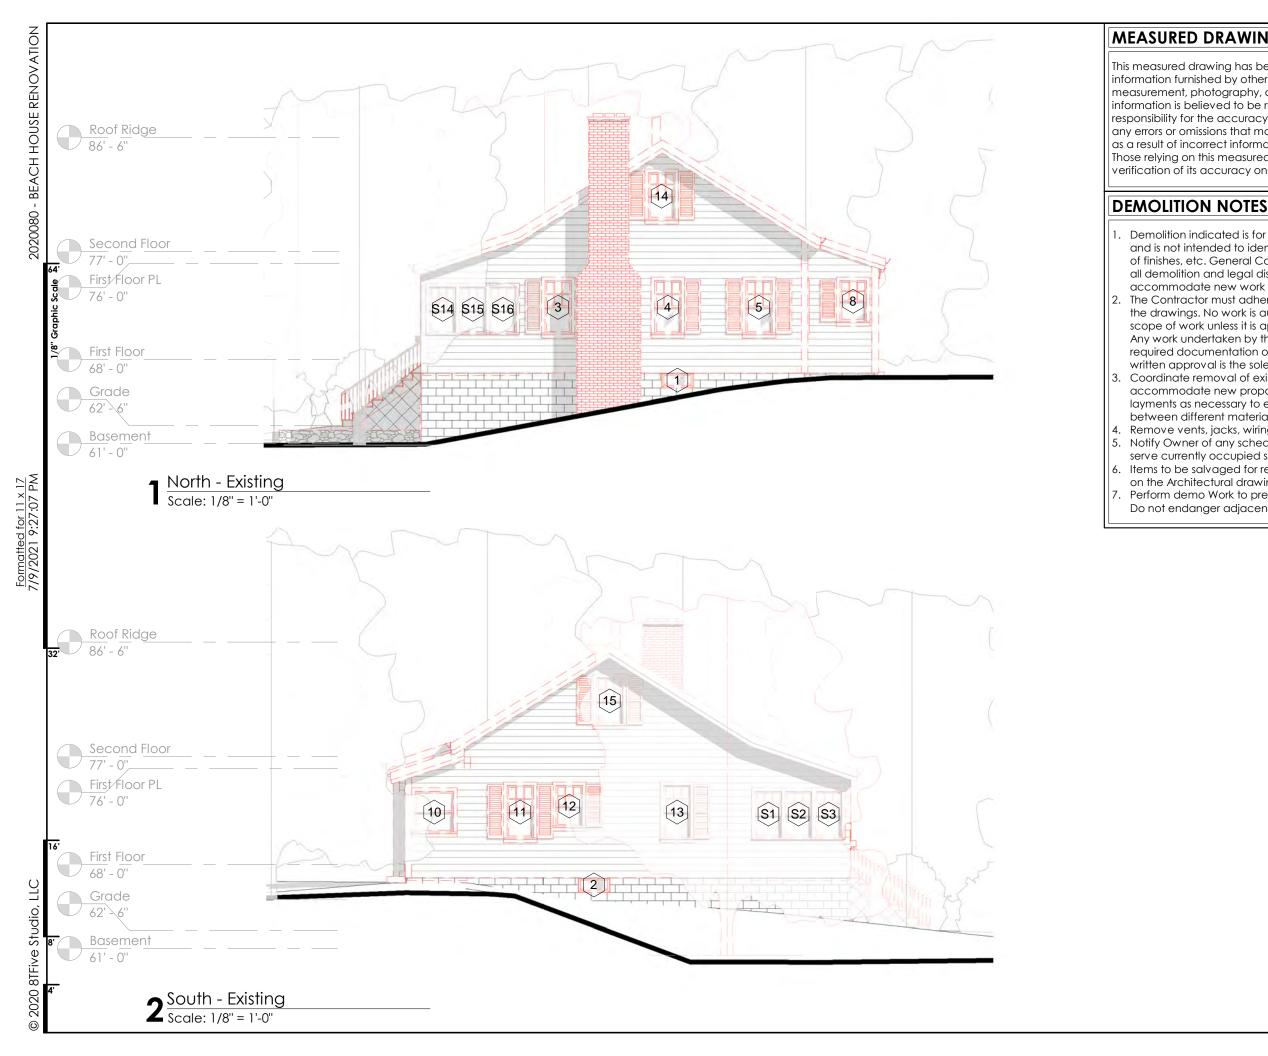

### MEASURED DRAWING DISCLAIMER

This measured drawing has been prepared, in part, based upon information furnished by others as well as with on-site field measurement, photography, and documentation. While this information is believed to be reliable, the Architect assumes no responsibility for the accuracy of this measured drawing or for any errors or omissions that may have been incorporated into it as a result of incorrect information provided to the Architect. Those relying on this measured document are advised to obtain verification of its accuracy on-site prior to construction.

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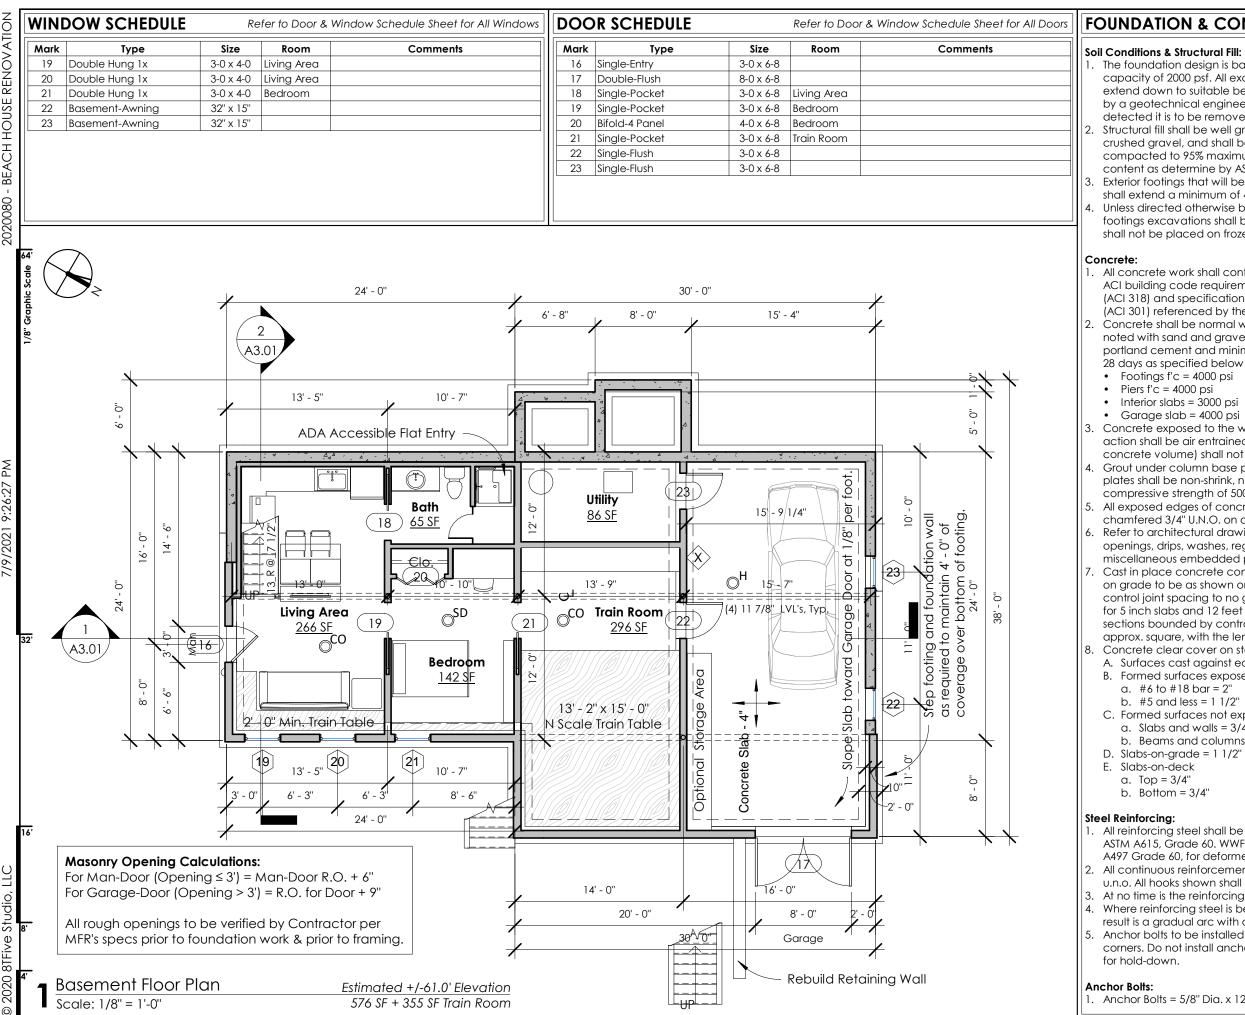
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Ex. Exterior Elevations	ations	DRAWN BY	ADDRESS	REVISIONS		<b>ARCHITECT STAMP</b>
		Neil Silva 06/30/2021	278 Lake Avenue, Wareham, MA 02538		architectural design	
					16 Jordan Lane	
<b>PROJECT STATUS</b>	SCALE	Project #	CLIENT		East Freetown, MA 02717	
Permit Set	As indicated 2020080	2020080	Karen Duke		(1/4) 249-2432 IIIIO@01FIVE.COIII	





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Stud 8TFive

### FOUNDATION & CONCRETE NOTES

1. The foundation design is based on an allowable bearing capacity of 2000 psf. All excavations for footings shall extend down to suitable bearing subgrade as determined by a geotechnical engineer. If questionable bearing is detected it is to be removed & replaced with structural fill. Structural fill shall be well graded bank run, screened or crushed gravel, and shall be placed in 8" maximum lifts and compacted to 95% maximum density at optimum moisture content as determine by ASTM D1557, modified proctor. Exterior footings that will be exposed to freeze thaw cycles shall extend a minimum of 4'-0" below finished grade. Unless directed otherwise by the geotechnical engineer, all footings excavations shall be finished by hand. Foundations shall not be placed on frozen ground or in puddled water.

All concrete work shall conform to the 2008 edition of the ACI building code requirements for reinforced concrete (ACI 318) and specifications for building structural concrete (ACI 301) referenced by the governing State Building Code. Concrete shall be normal weight concrete unless otherwise noted with sand and gravel aggregate, type I or type II portland cement and minimum compressive strength (f'c) in 28 days as specified below - maximum slump  $4 \frac{1}{2}$ ".

Walls f'c = 4000 psi Fill concrete = 3000 psi Mud mats = 2000 psi

Concrete exposed to the weather or possible freeze/thaw action shall be air entrained. Total air content (percent by concrete volume) shall not be less than 5% or more than 7%. Grout under column base plates and under other bearing plates shall be non-shrink, nonmetallic grout with a minimum compressive strength of 5000 psi at 3 days.

All exposed edges of concrete members shall be chamfered 3/4" U.N.O. on architectural drawings. Refer to architectural drawings for door and window openings, drips, washes, reglets, concrete finishes, and miscellaneous embedded plates, bolts, anchors, angles, etc Cast in place concrete construction or control joints in slab on grade to be as shown on plans. Where not shown, limit control joint spacing to no greater than 15 feet on any side for 5 inch slabs and 12 feet for 4 inch slabs on grade. The sections bounded by control or construction joints shall be approx. square, with the length to width ratio less than 1.5. Concrete clear cover on steel reinforcing shall be per ACI: A. Surfaces cast against earth = 3"

B. Formed surfaces exposed to earth or weather a. #6 to #18 bar = 2"

b. #5 and less = 1 1/2''

C. Formed surfaces not exposed to earth or weather a. Slabs and walls = 3/4"

- b. Beams and columns =  $1 \frac{1}{2}$ "
- D. Slabs-on-grade =  $1 \frac{1}{2}$ " (from top of slab)


All reinforcing steel shall be deformed bars conforming to ASTM A615, Grade 60. WWF shall conform to astm A496 and A497 Grade 60, for deformed and plain wire respectively. 2. All continuous reinforcement shall have Class B lap splices, u.n.o. All hooks shown shall be standard hooks, u.n.o. At no time is the reinforcing steel to be welded. 4. Where reinforcing steel is bent it is to be done so the end

result is a gradual arc with a minimum of a three inch radius. Anchor bolts to be installed within 12" of all joints and corners. Do not install anchor bolt within 12" of anchor rod

Anchor Bolts = 5/8" Dia. x 12" Long J-Bolts @ 36" o.c. (Typical)

ARCHITECT STAMP	
A BTFIVE STUDIO architectural design	lo Jordan Lane East Freetown, MA 02717 (774) 243-2432 info@8TFive.com
REVISIONS	
<b>ADDRESS</b> 278 Lake Avenue, Wareham, MA 02538	<b>CLIENT</b> Karen Duke
<b>DRAWN BY</b> Neil Silva 06/30/2021	<b>Project #</b> 2020080
	SCALE Project # As indicated 2020080
Basement Plan	PROJECT STATUS

A1.00

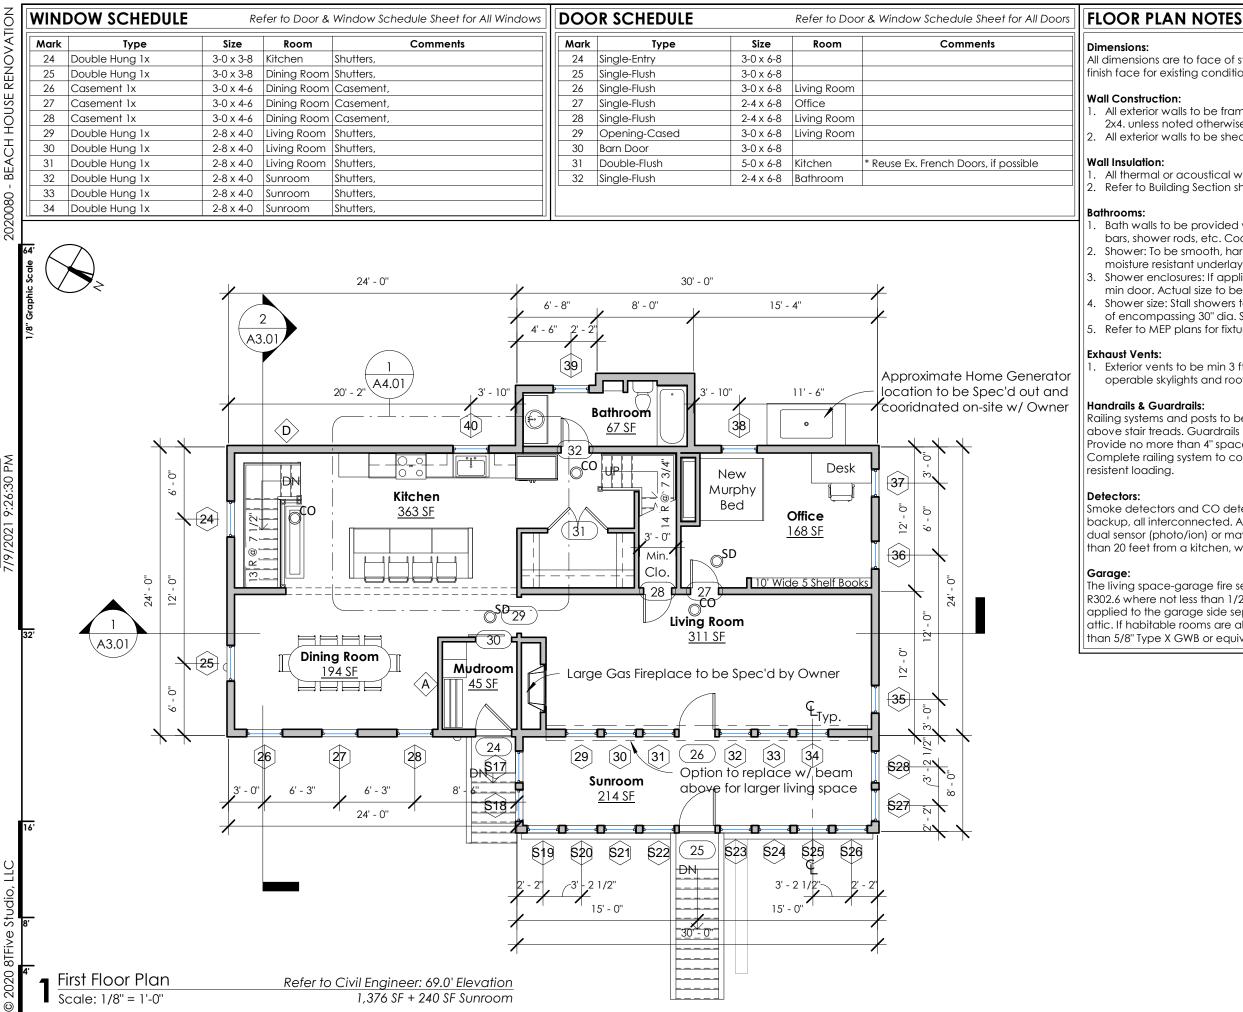

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Studio, 8TFive

All dimensions are to face of stud for new construction and finish face for existing conditions, unless otherwise noted.

1. All exterior walls to be framed with 2x6. Interior walls to be 2x4. unless noted otherwise. Refer to Floor Plan. 2. All exterior walls to be sheathed whether shear or not.

1. All thermal or acoustical walls to be insulated full depth. 2. Refer to Building Section sheet for Energy Requirements.

Bath walls to be provided with 2x6 wall blocking for towel bars, shower rods, etc. Coordinate accessories with Owner. Shower: To be smooth, hard, non-absorbent surface over a moisture resistant underlayment 70" min. above drain inlet. Shower enclosures: If applicable to be tempered glass, 24" min door. Actual size to be reviewed with Owner. 4. Shower size: Stall showers to be min 1024 sq in and capable of encompassing 30" dia. See Plan for sizing & placement. 5. Refer to MEP plans for fixture flow rates, notes, etc.


Exterior vents to be min 3 ft away from doors, windows, operable skylights and roof vents.

Railing systems and posts to be wood with handrail 34" - 38" above stair treads. Guardrails to be 42" min above finish floor. Provide no more than 4" space between balustrades. Complete railing system to conform to Building Code per

Smoke detectors and CO detectors to be 110V with battery backup, all interconnected. All smoke alarms shall either be dual sensor (photo/ion) or may be photoelectric when more than 20 feet from a kitchen, wood burning stove or fireplace.

The living space-garage fire separation shall be as required per R302.6 where not less than 1/2" GWB or equivalent shall be applied to the garage side separating the residence and/or attic. If habitable rooms are above the garage then not less than 5/8" Type X GWB or equivalent shall be used.

**ARCHITECT STAMP** ctural design **8TFIVE STUDIO** 16 Jordan Lane East Freetown, MA 02717 (774) 243-2432 info@8TFive.com archited REVISIONS Avenue, n, MA 02538 **CLIENT** Karen Duke 278 Lake Av Wareham, *N* ADDRESS **DRAWN BY** Neil Silva 06/30/2021 **Project #** 2020080 **SCALE** As indicated lst Floor Plan PROJECT STATUS Permit Set A1.01

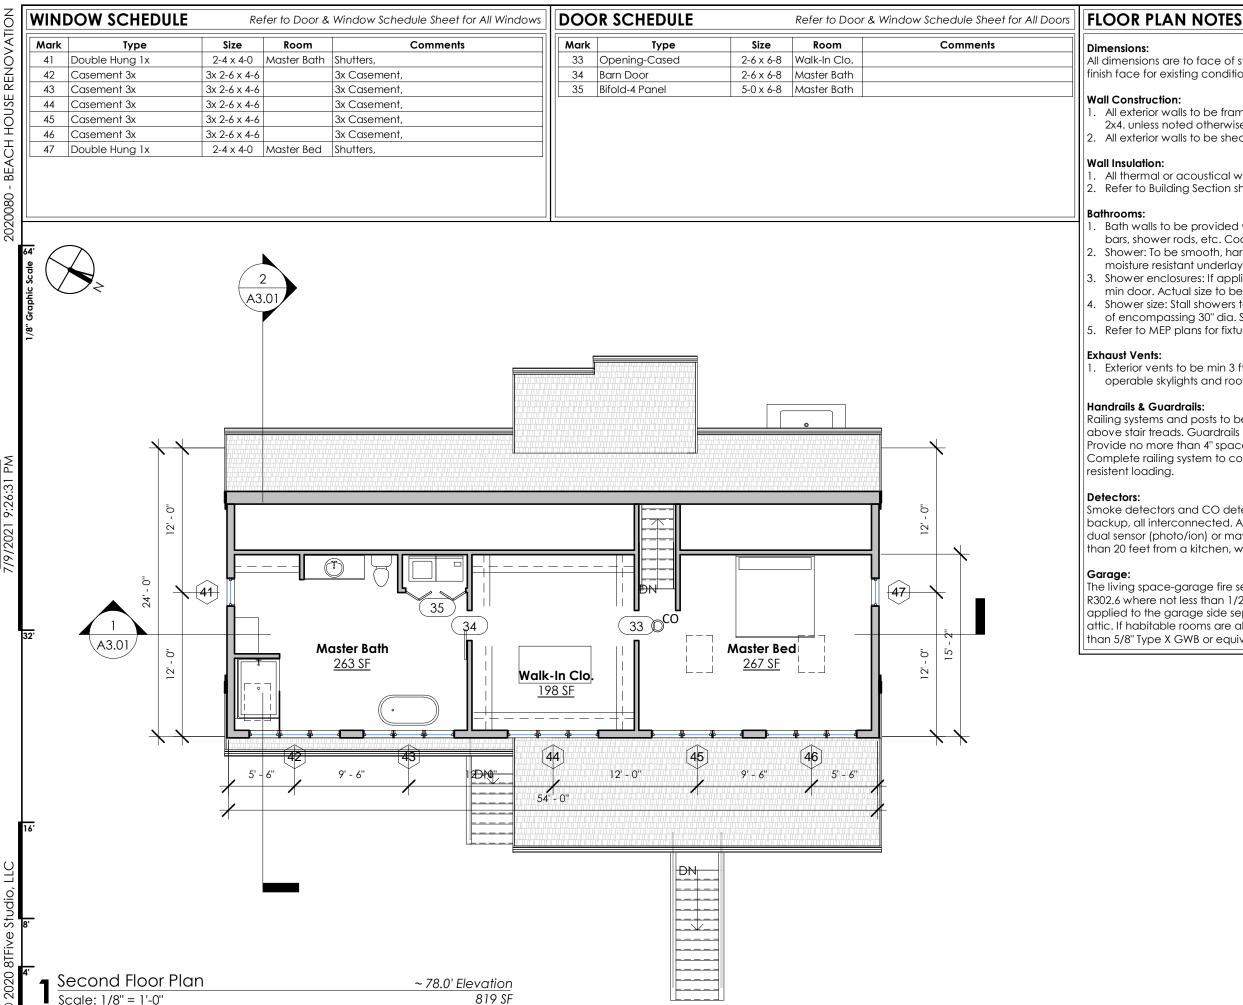

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All dimensions are to face of stud for new construction and finish face for existing conditions, unless otherwise noted.

1. All exterior walls to be framed with 2x6. Interior walls to be 2x4. unless noted otherwise. Refer to Floor Plan. 2. All exterior walls to be sheathed whether shear or not.

1. All thermal or acoustical walls to be insulated full depth. 2. Refer to Building Section sheet for Energy Requirements.

Bath walls to be provided with 2x6 wall blocking for towel bars, shower rods, etc. Coordinate accessories with Owner. 2. Shower: To be smooth, hard, non-absorbent surface over a moisture resistant underlayment 70" min. above drain inlet. Shower enclosures: If applicable to be tempered glass, 24" min door. Actual size to be reviewed with Owner. 4. Shower size: Stall showers to be min 1024 sq in and capable of encompassing 30" dia. See Plan for sizing & placement. 5. Refer to MEP plans for fixture flow rates, notes, etc.

1. Exterior vents to be min 3 ft away from doors, windows, operable skylights and roof vents.

Railing systems and posts to be wood with handrail 34" - 38" above stair treads. Guardrails to be 42" min above finish floor. Provide no more than 4" space between balustrades. Complete railing system to conform to Building Code per

Smoke detectors and CO detectors to be 110V with battery backup, all interconnected. All smoke alarms shall either be dual sensor (photo/ion) or may be photoelectric when more than 20 feet from a kitchen, wood burning stove or fireplace.

The living space-garage fire separation shall be as required per R302.6 where not less than 1/2" GWB or equivalent shall be applied to the garage side separating the residence and/or attic. If habitable rooms are above the garage then not less than 5/8" Type X GWB or equivalent shall be used.

**ARCHITECT STAMP BTFIVE STUDIO** architectural design 16 Jordan Lane East Freetown, MA 02717 (774) 243-2432 info@8TFive.com REVISIONS Avenue, n, MA 02538 **CLIENT** Karen Duke 278 Lake Av Wareham, N ADDRESS DRAWN BY Neil Silva 06/30/2021 **Project #** 2020080 **SCALE** As indicated **2nd Floor Plan** PROJECT STATUS Permit Set A1.02



### **EXTERIOR ELEVATION NOTES**


- 1. Composition shingle roofing to match existing, UL Class A mininum fire resistance.
- 2. Installation shall be per Manufactuter's and State's Building Code requirements for shingle roofing.
- 3. Flash at all transitions per mfr's reg'ts and industry standards.

Galv sheet metal gutters and downspouts to match existing.
Downspouts to be daylighted & surface drained to grade.

1. All roof flashing (tile pans, roof to wall, valleys, pipe collars, vents, cricket chimney flashing, attic vents) to be sheet metal. Flashing shall be provided at all the following transitions per IBC: All doors and windows to have sheet metal head flashing; Above projecting wood trim; At porches, closed decks, or stairs to wall or floors; At all wall and roof intersections.

1. New exterior siding to match existing, UNO. 2. New exterior wood to be painted to match existing.

**ARCHITECT STAMP** ATFIVE STUDIO architectural design 16 Jordan Lane East Freetown, MA 02717 (774) 243-2432 info@8TFive.com REVISIONS 278 Lake Avenue, Wareham, MA 02538 **CLIENT** Karen Duke ADDRESS **DRAWN BY** Neil Silva 06/30/2021 **Project #** 2020080 **SCALE** As indicated **Exterior Elevations** PROJECT STATUS Permit Set A2.01

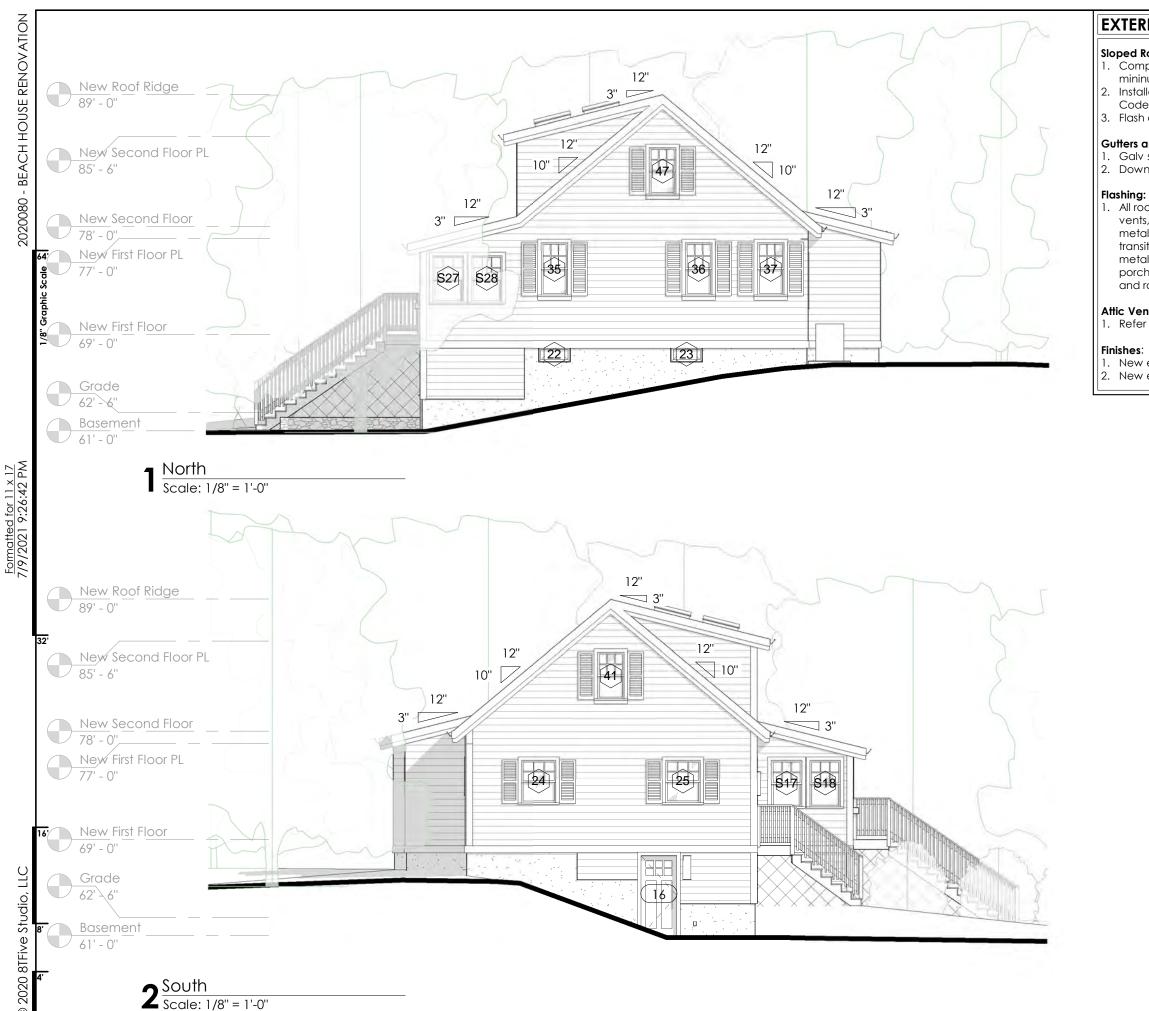

### Sloped Roofing:

- mininum fire resistance.

### Gutters and Downspouts:

and roof intersections.

### Attic Venting:

1. Refer to Roof Plan

### **EXTERIOR ELEVATION NOTES**

1. Composition shingle roofing to match existing, UL Class A

2. Installation shall be per Manufactuter's and State's Building Code requirements for shingle roofing.

3. Flash at all transitions per mfr's reg'ts and industry standards.

Galv sheet metal gutters and downspouts to match existing.
Downspouts to be daylighted & surface drained to grade.

1. All roof flashing (tile pans, roof to wall, valleys, pipe collars, vents, cricket chimney flashing, attic vents) to be sheet metal. Flashing shall be provided at all the following transitions per IBC: All doors and windows to have sheet metal head flashing; Above projecting wood trim; At porches, closed decks, or stairs to wall or floors; At all wall

1. New exterior siding to match existing, UNO. 2. New exterior wood to be painted to match existing.

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