LIST OF DRAWINGS

SHEET NO.	TITLE

- 1 OF 10 COVER SHEET
- **EXISTING CONDITIONS /** 2 OF 10 SITE PREPARATION PLAN
- 3 OF 10 LAYOUT PLAN
- 4 OF 10 UTILITIES PLAN
- 5 OF 10 GRADING & DRAINAGE PLAN
- 6 OF 10 LANDSCAPING PLAN
- 7 OF 10 LIGHTING PLAN
- 8 OF 10 EMERGENCY ACCESS PLAN
- 9 OF 10 DETAIL SHEET
- 10 OF 10 DETAIL SHEET


CURRENT OWNER / APPLICANT: ANGELA MCKEOWN, TRUSTEE 388 MAIN STREET REALTY TRUST 484 LIBERTY STREET ROCKLAND, MA 02370

CIVIL ENGINEER / SURVEYOR: JC ENGINEERING, INC. 2854 CRANBERRY HIGHWAY EAST WAREHAM, MA 02538 PH: 508-273-0377



PROPOSED SITE PLAN 386 MAIN STREET WAREHAM, MASSACHUSETTS


DATE: MARCH 21, 2023 REV 6: NOVEMBER 2, 2023

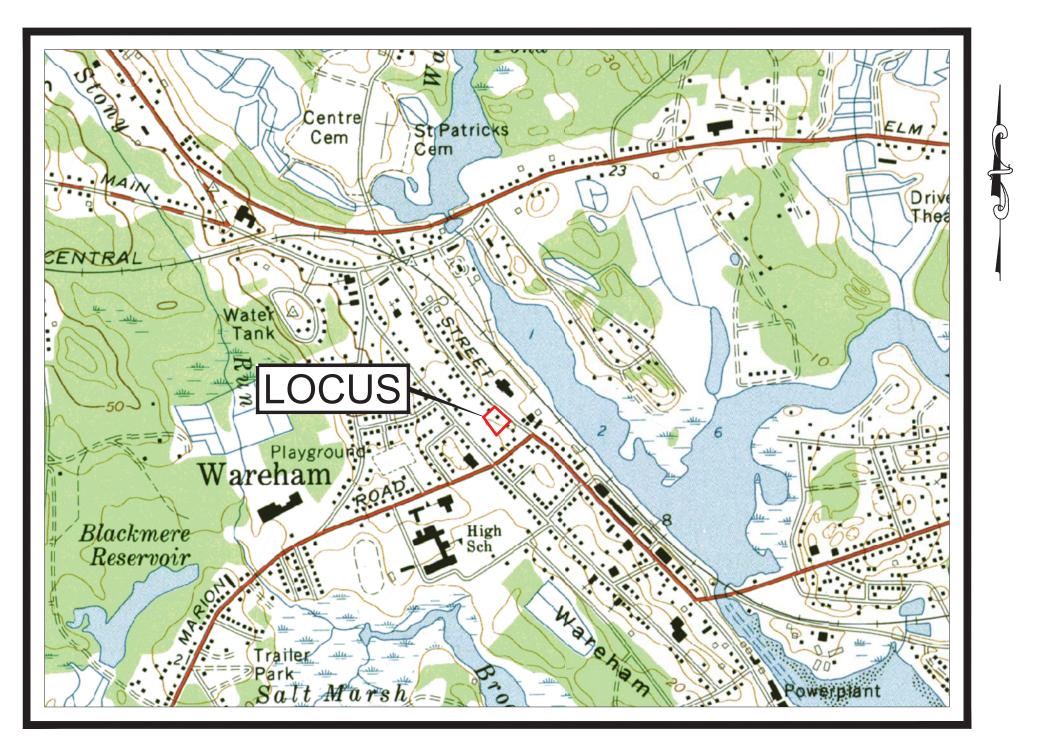


U.S.G.S. MAP SCALE 1" = 1000'

AERIAL MAP SCALE 1" = 500'

1071 1077 LOCUS **1078 1130 1131** 10615 1595 1156

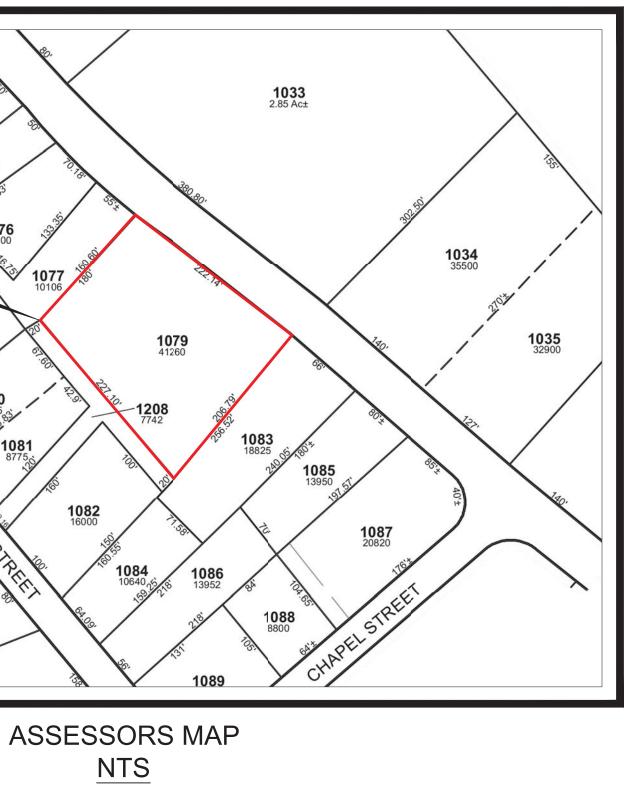

LEGEND

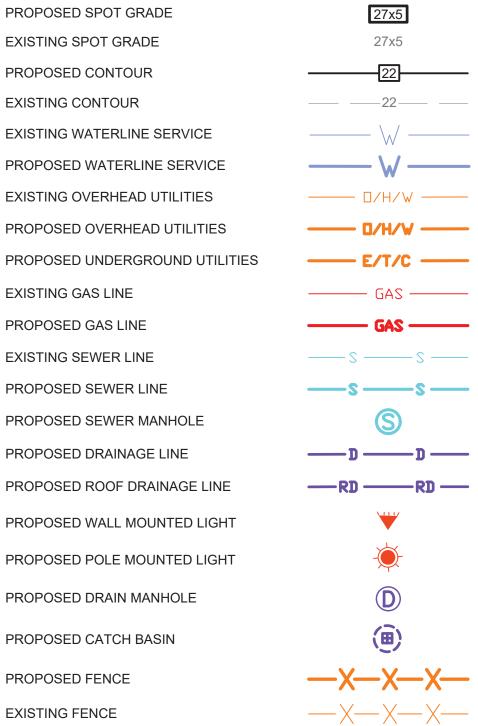

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386 MAIN STREET IN WAREHAM MASSACHUSETTS (PLYMOUTH COUNTY) DEVER SHEETS DEVESSIONS: No. DATE DESC. DATE DESC. DESC. DATE DESC. DATE DESC. DESC. DATE DESC. DATE DESC. DESC. DATE DESC. DESC. DATE DESC. DATE DESC	
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ANGELA MCKEOWN 484 LIBERTY STREET ROCKLAND, MA 02370 <u>PREPARED BY:</u> JC ENGINEERING, INC 2854 CRANBERRY HIGHWAY EAST WAREHAM, MA 02538 508-273-0377	No.DATEDESC.16-28-23MEETING COMMENTS27-25-23MEETING COMMENTS38-7-23SITE PLAN REVIEW49-13-23PEER REVIEW COMMENTS59-25-23MEETING COMMENTS
JC ENGINEERING, INC 2854 CRANBERRY HIGHWAY EAST WAREHAM, MA 02538 508-273-0377	ANGELA MCKEOWN 484 LIBERTY STREET
DATE: MARCH 21, 2023	JC ENGINEERING, INC 2854 CRANBERRY HIGHWAY EAST WAREHAM, MA 02538
DATE: MARCH 21, 2023	
FIELD: BM/JF CALC./DESIGN: SJI	
DRAWN: SJI	
CHECK: JLC JOB NO: 6028	
SHEET 1 OF 10	SHEET 1 OF 10

OWNER OF RECORD: 388 MAIN STREET REALTY TRUST ANGELA MCKEOWN, TRUSTEE **484 LIBERTY STREET** ROCKLAND, MA 02370

FEMA FLOOD ZONE (LOT): Х


AS SHOWN ON COMMUNITY PANEL: #25023C0488K (dated 7-6-2021)

ASSESSOR'S MAP & LOT: MAP 61, LOT 1079

DEED REFERENCE: BOOK 55430, PAGE 277

PLAN REFERENCES: BOOK 38, PAGE 2941 BOOK 3385, PAGE 48

LEGEND:

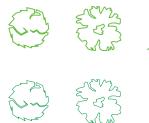


BUSH / TREE / STUMP TO BE REMOVED

= BUSH / TREE TO REMAIN



INSPECTOR: Unwitnessed EVALUATOR: Bradley Bertolo, EIT, CSE January 6, 2023 DATE: 1 TEST PIT #: ELEV TOP = 30.50' < 21.50' ELEV WATER = PERC RATE = DEPTH OF PERC = TEXTURAL CLASS: 1

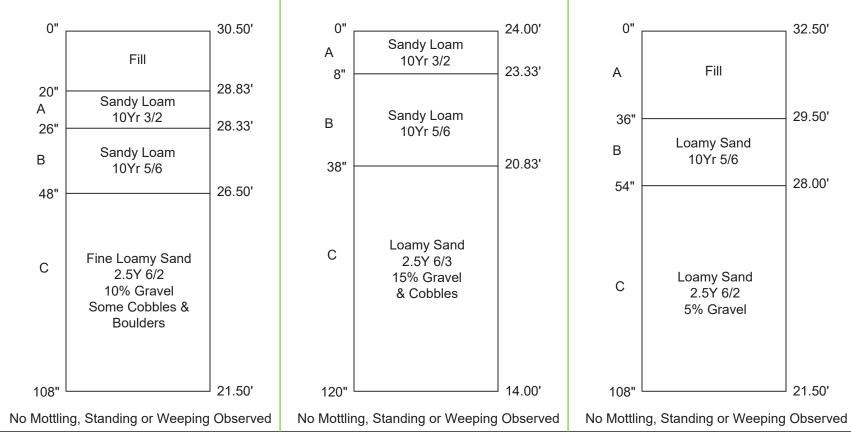

DRAINAGE **TEST PIT DATA**


INSPECTOR: Unwitnessed EVALUATOR: Bradley Bertolo, EIT, CSE DATE: January 6, 2023 2 TEST PIT #: ELEV TOP = 24.00' ELEV WATER = < 14.00' PERC RATE = DEPTH OF PERC =

TEXTURAL CLASS: 1

0"		24.00'
A 8"	Sandy Loam 10Yr 3/2	23.33'
В	Sandy Loam	20.00
38"	10Yr 5/6	20.83'
С	Loamy Sand 2.5Y 6/3 15% Gravel & Cobbles	
120"		14.00'
Mottlir	ng, Standing or Weeping	Observ


DRAINAGE **TEST PIT DATA**

INSPECTOR:	Unwitnessed
EVALUATOR:	Bradley Bertolo, EIT, CSE
DATE:	January 6, 2023
TEST PIT #:	3
ELEV TOP =	32.50'
ELEV WATER	= < 21.50'
PERC RATE =	:
DEPTH OF PE	ERC =
TEXTURAL CI	

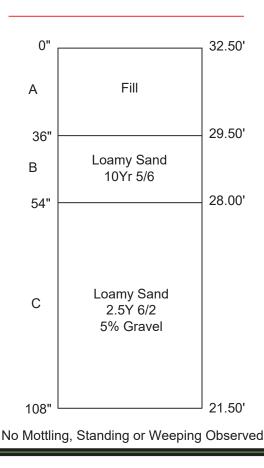

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#181 EXISTING DWELLING

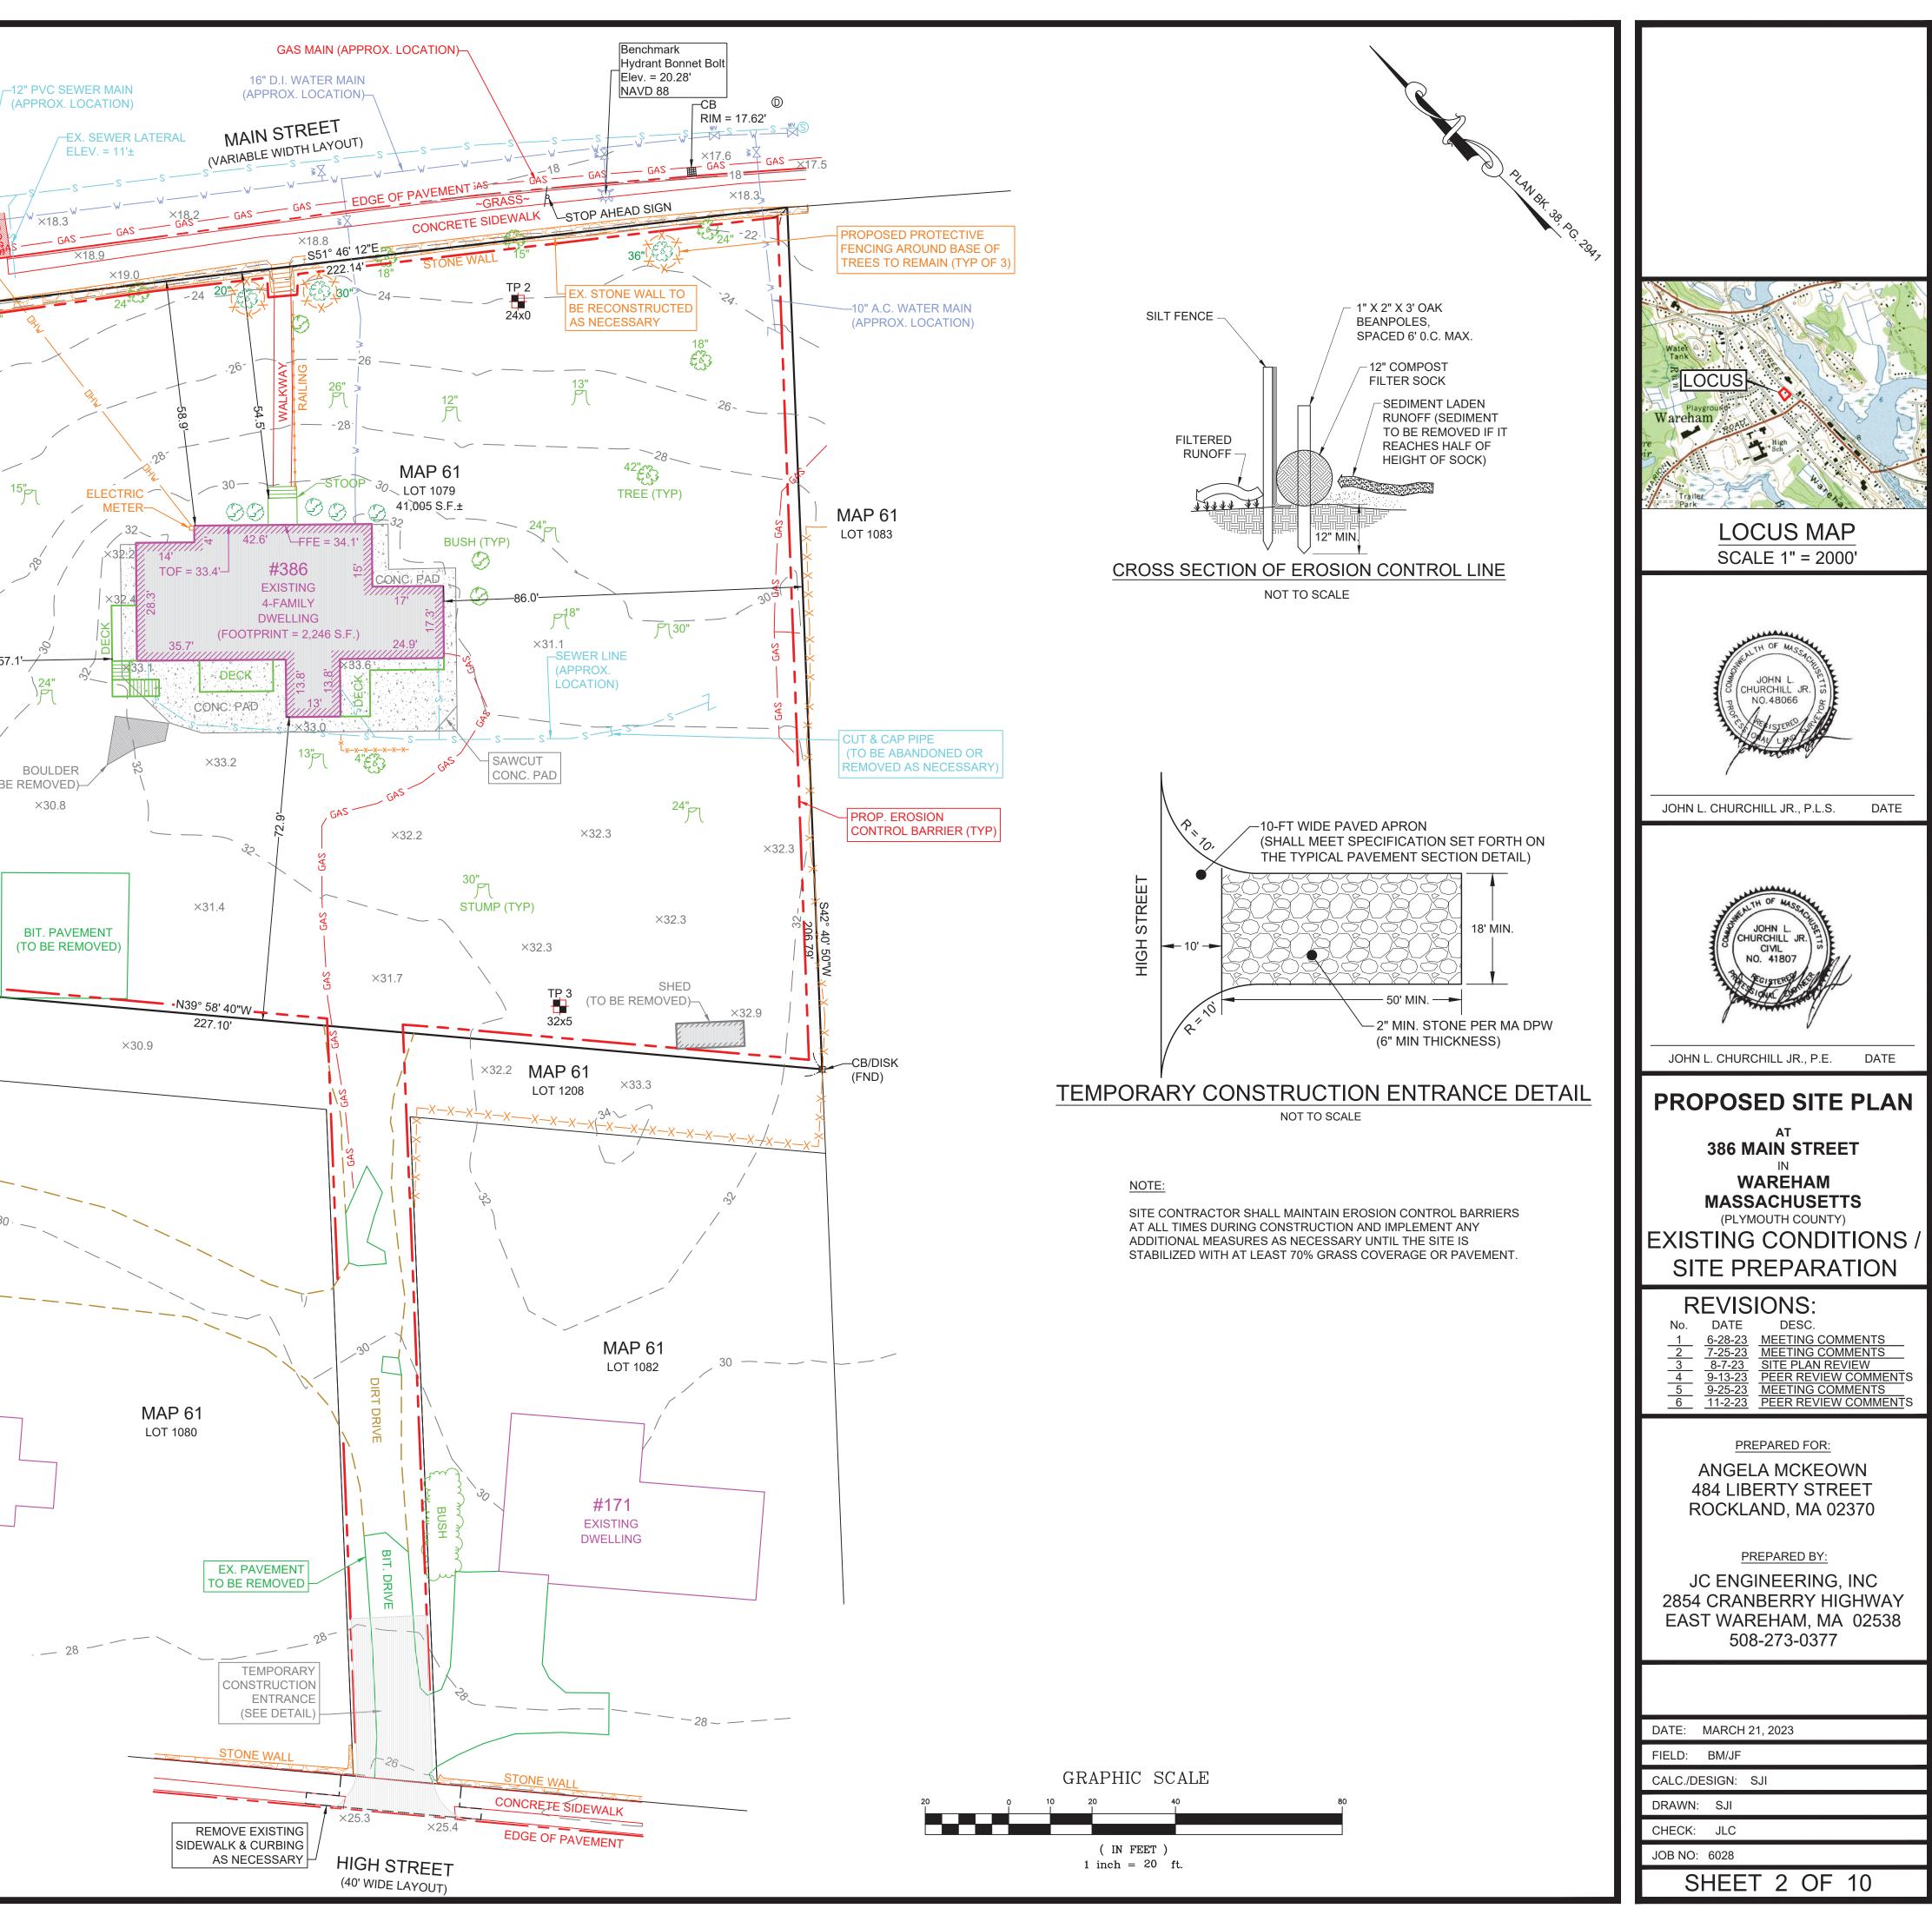


OFFSTREET PARKING SCHEDULE (TABLE 921)

PROPOSED USE 2-FAMILY DWELLING 4-FAMILY DWELLING

REQUIRED TOTAL PROVIDED TOTAL NUMBER OF REQUIRED PARKING SPACES12 (2 SPACES PER DWELLING UNIT)8 (2 SPACES PER DWELLING UNIT)

TAL <u>20</u>

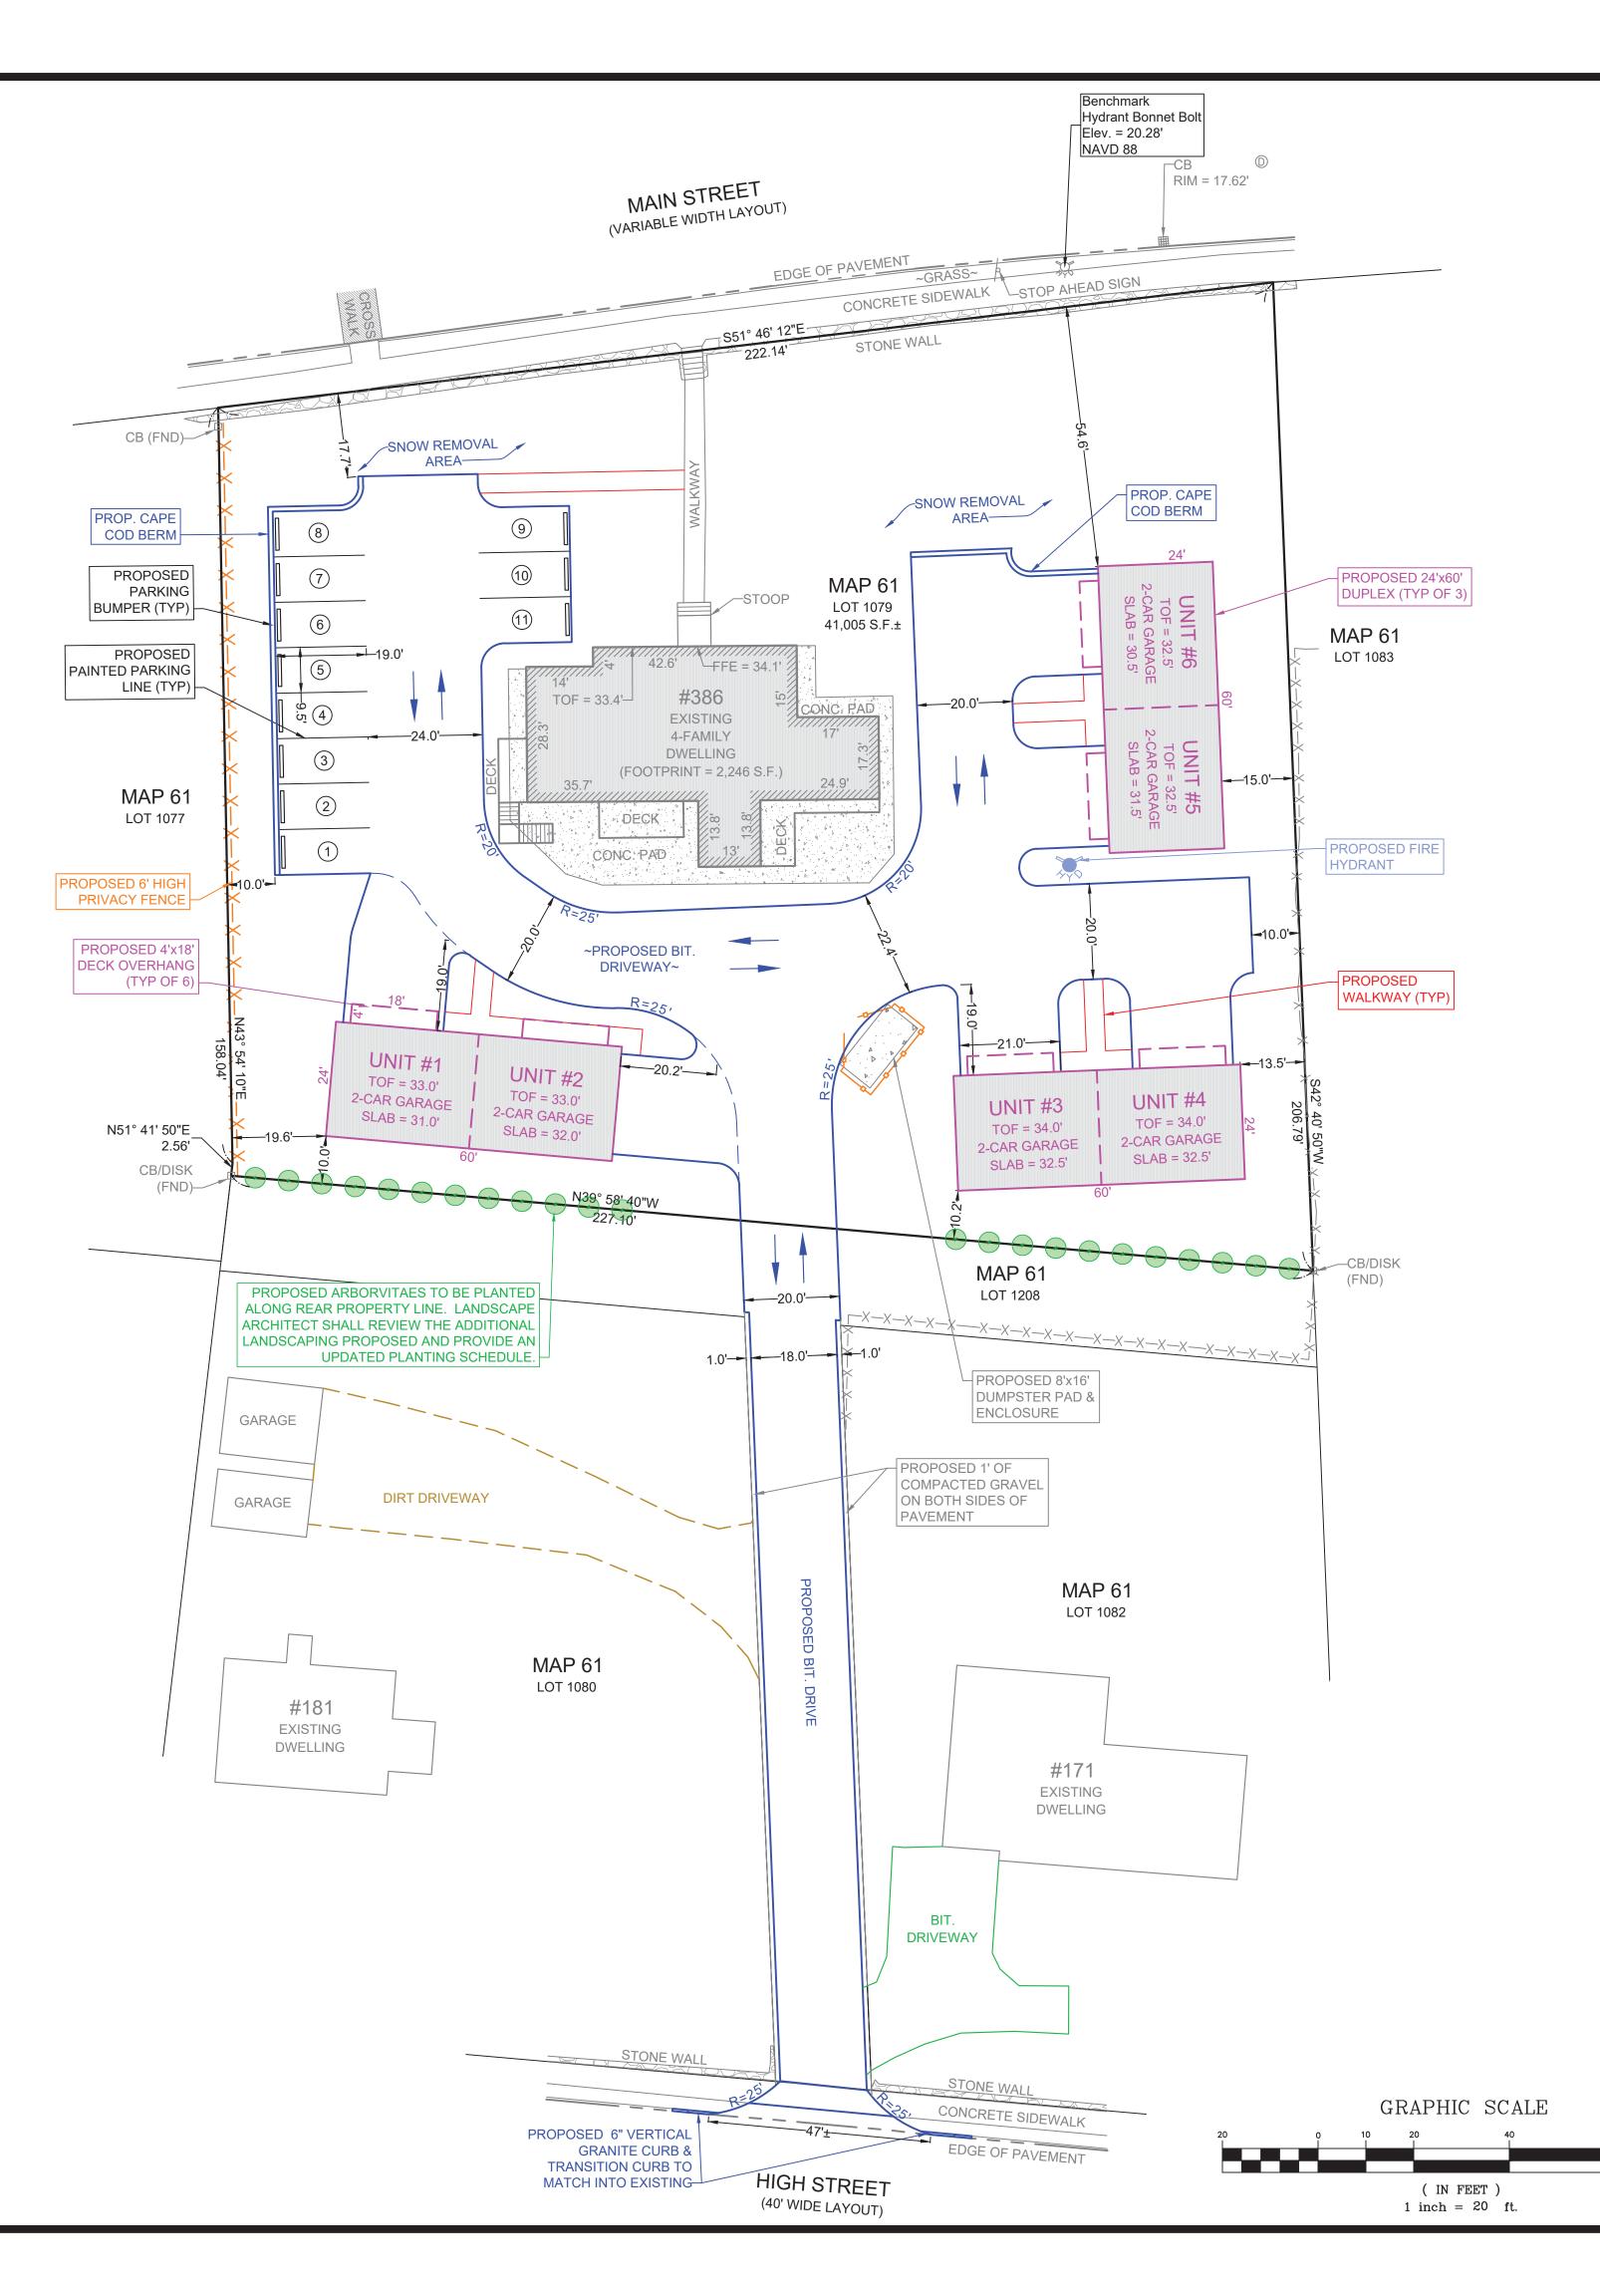

DENSITY

LOT AREA = 41,005 S.F. $\frac{\text{REQUIRED}}{15,000 \text{ S.F. FOR FIRST DWELLING UNIT}}$ 2,000 S.F. FOR EACH ADDITIONAL UNIT $\frac{\text{PROVIDED}}{1 \text{ DWELLING UNIT}} = 15,000 \text{ S.F.}$ 9 ADDITIONAL DWELLING UNITS = 9 x 2,000 S.F. = 18,000 S.F. TOTAL: 15,000 S.F + 19,000 S.F. =

33,000 S.F. < 41,005 S.F

ZONING SCHEDULE (TABLE 622) ZONING DISTRICT: WAREHAM VILLAGE 2 (WV-2)

ITEM	<u>REQUIRED</u>	EXISTING	PROPOSED	
MIN. LOT AREA	15,000 S.F.	41,005 S.F.	N/A	
MIN. FRONTAGE	75'	222.14'	N/A	
MIN. FRONT SETBACK	*50.3'	54.5'	54.5'	
MIN. SIDE SETBACK	10'	57.1'	13.5'	
MIN. REAR SETBACK	10'	72.9'	10.0'	
MAX. BUILDING HEIGHT	35'	< 35'	< 35'	
MAX. BUILDING COVERAGE	20%	5.7%	17.1%	
MAX. LOT COVERAGE	50%	11.8%	49.9%	

*AVERAGE OF THE SETBACKS OF FIVE (5) RESIDENTIAL STRUCTURES ON EITHER SIDE OF THE SUBJECT PROPERTY.

FRONT SETBACK CALCULATION:

ADDRESS	FRONT SETBACK
402 MAIN STREET	48.4'
400 MAIN STREET	48.2'
398 MAIN STREET	39.6'
394 MAIN STREET	40.3'
380 MAIN STREET	74.9'
TOTAL =	251.4'
	- 0.64 4! / 5 - 50 0.0!

AVERAGE = 251.4' / 5 = 50.28' USE = 50.3'

0.09 7 9 9	
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	Water Control of the second se
	Playgrounde Wareham
	re ir
	Trailer Park LOCUS MAP
	SCALE 1" = 2000'
	WINNELTH OF MASS TO THE
	JOHN L. CHURCHILL JR. NO.48066
	A CAN UNCLOSE OF
	JOHN L. CHURCHILL JR., P.L.S. DATE
	بيستشدين
	JOHN L. CHURCHILL JR. CIVIL
	NO. 41807
	JOHN L. CHURCHILL JR., P.E. DATE
	PROPOSED SITE PLAN
	AT 386 MAIN STREET
	WAREHAM MASSACHUSETTS (PLYMOUTH COUNTY)
	LAYOUT PLAN
	REVISIONS: No. DATE DESC. <u>1</u> 7-11-23 MEETING COMMENTS <u>7-11-23 MEETING COMMENTS</u>
	27-25-23MEETING COMMENTS38-7-23SITE PLAN REVIEW49-13-23PEER REVIEW COMMENTS59-25-23MEETING COMMENTS611-2-23PEER REVIEW COMMENTS
	PREPARED FOR: ANGELA MCKEOWN
	484 LIBERTY STREET ROCKLAND, MA 02370
	<u>PREPARED BY:</u> JC ENGINEERING, INC
	2854 CRANBERRY HIGHWAY EAST WAREHAM, MA 02538 508-273-0377
	DATE: MARCH 21, 2023
	FIELD: BM/JF
	CALC./DESIGN: SJI
	DRAWN: SJI CHECK: JLC
	JOB NO: 6028
	SHEET 3 OF 10

NOTES:


1. UTILITIES AS SHOWN ON THIS PLAN ARE BASED ON RECORD PLANS AVAILABLE AND FIELD LOCATED MARK OUTS PERFORMED BY THE RESPECTIVE UTILITY COMPANY. UTILITY LOCATIONS ON THIS PLAN SHALL BE CONSIDERED APPROXIMATE ONLY AND MAY NOT FULLY REPRESENT ALL UNDERGROUND UTILITIES LOCATED ON SITE. THE CONTRACTOR SHALL CONTACT DIG SAFE AT LEAST 72 HOURS PRIOR TO THE COMMENCEMENT OF CONSTRUCTION.

2. ALL SEWER WORK SHALL COMPLY WITH THE TOWN OF WAREHAM SEWER COMMISSIONERS RULES AND REGULATIONS. CONTRACTOR TO CONFIRM SIZE & ELEVATION OF EXISTING SEWER SERVICE PRIOR TO CONSTRUCTION. FINAL BUILDING SEWER INVERTS SHALL BE DETERMINED AT TIME OF CONSTRUCTION.

3. ALL WATER LINES AND CONNECTIONS SHALL COMPLY WITH THE WAREHAM FIRE DISTRICT RULES AND REGULATIONS. CONTRACTOR TO CONFIRM LOCATION OF EXISTING WATER SERVICE LINE PRIOR TO CONSTRUCTION.

4. CONTRACTOR SHALL COORDINATE WITH LOCAL UTILITY COMPANY & ELECTRICIAN FOR FINAL LOCATION, SIZE, & CONFIGURATION OF THE PROPOSED ELECTRICAL SERVICE.

5. CONTRACTOR SHALL COORDINATE WITH THE LOCAL GAS COMPANY FOR FINAL LOCATION, SIZE, & CONFIGURATION OF THE PROPOSED GAS SERVICE.

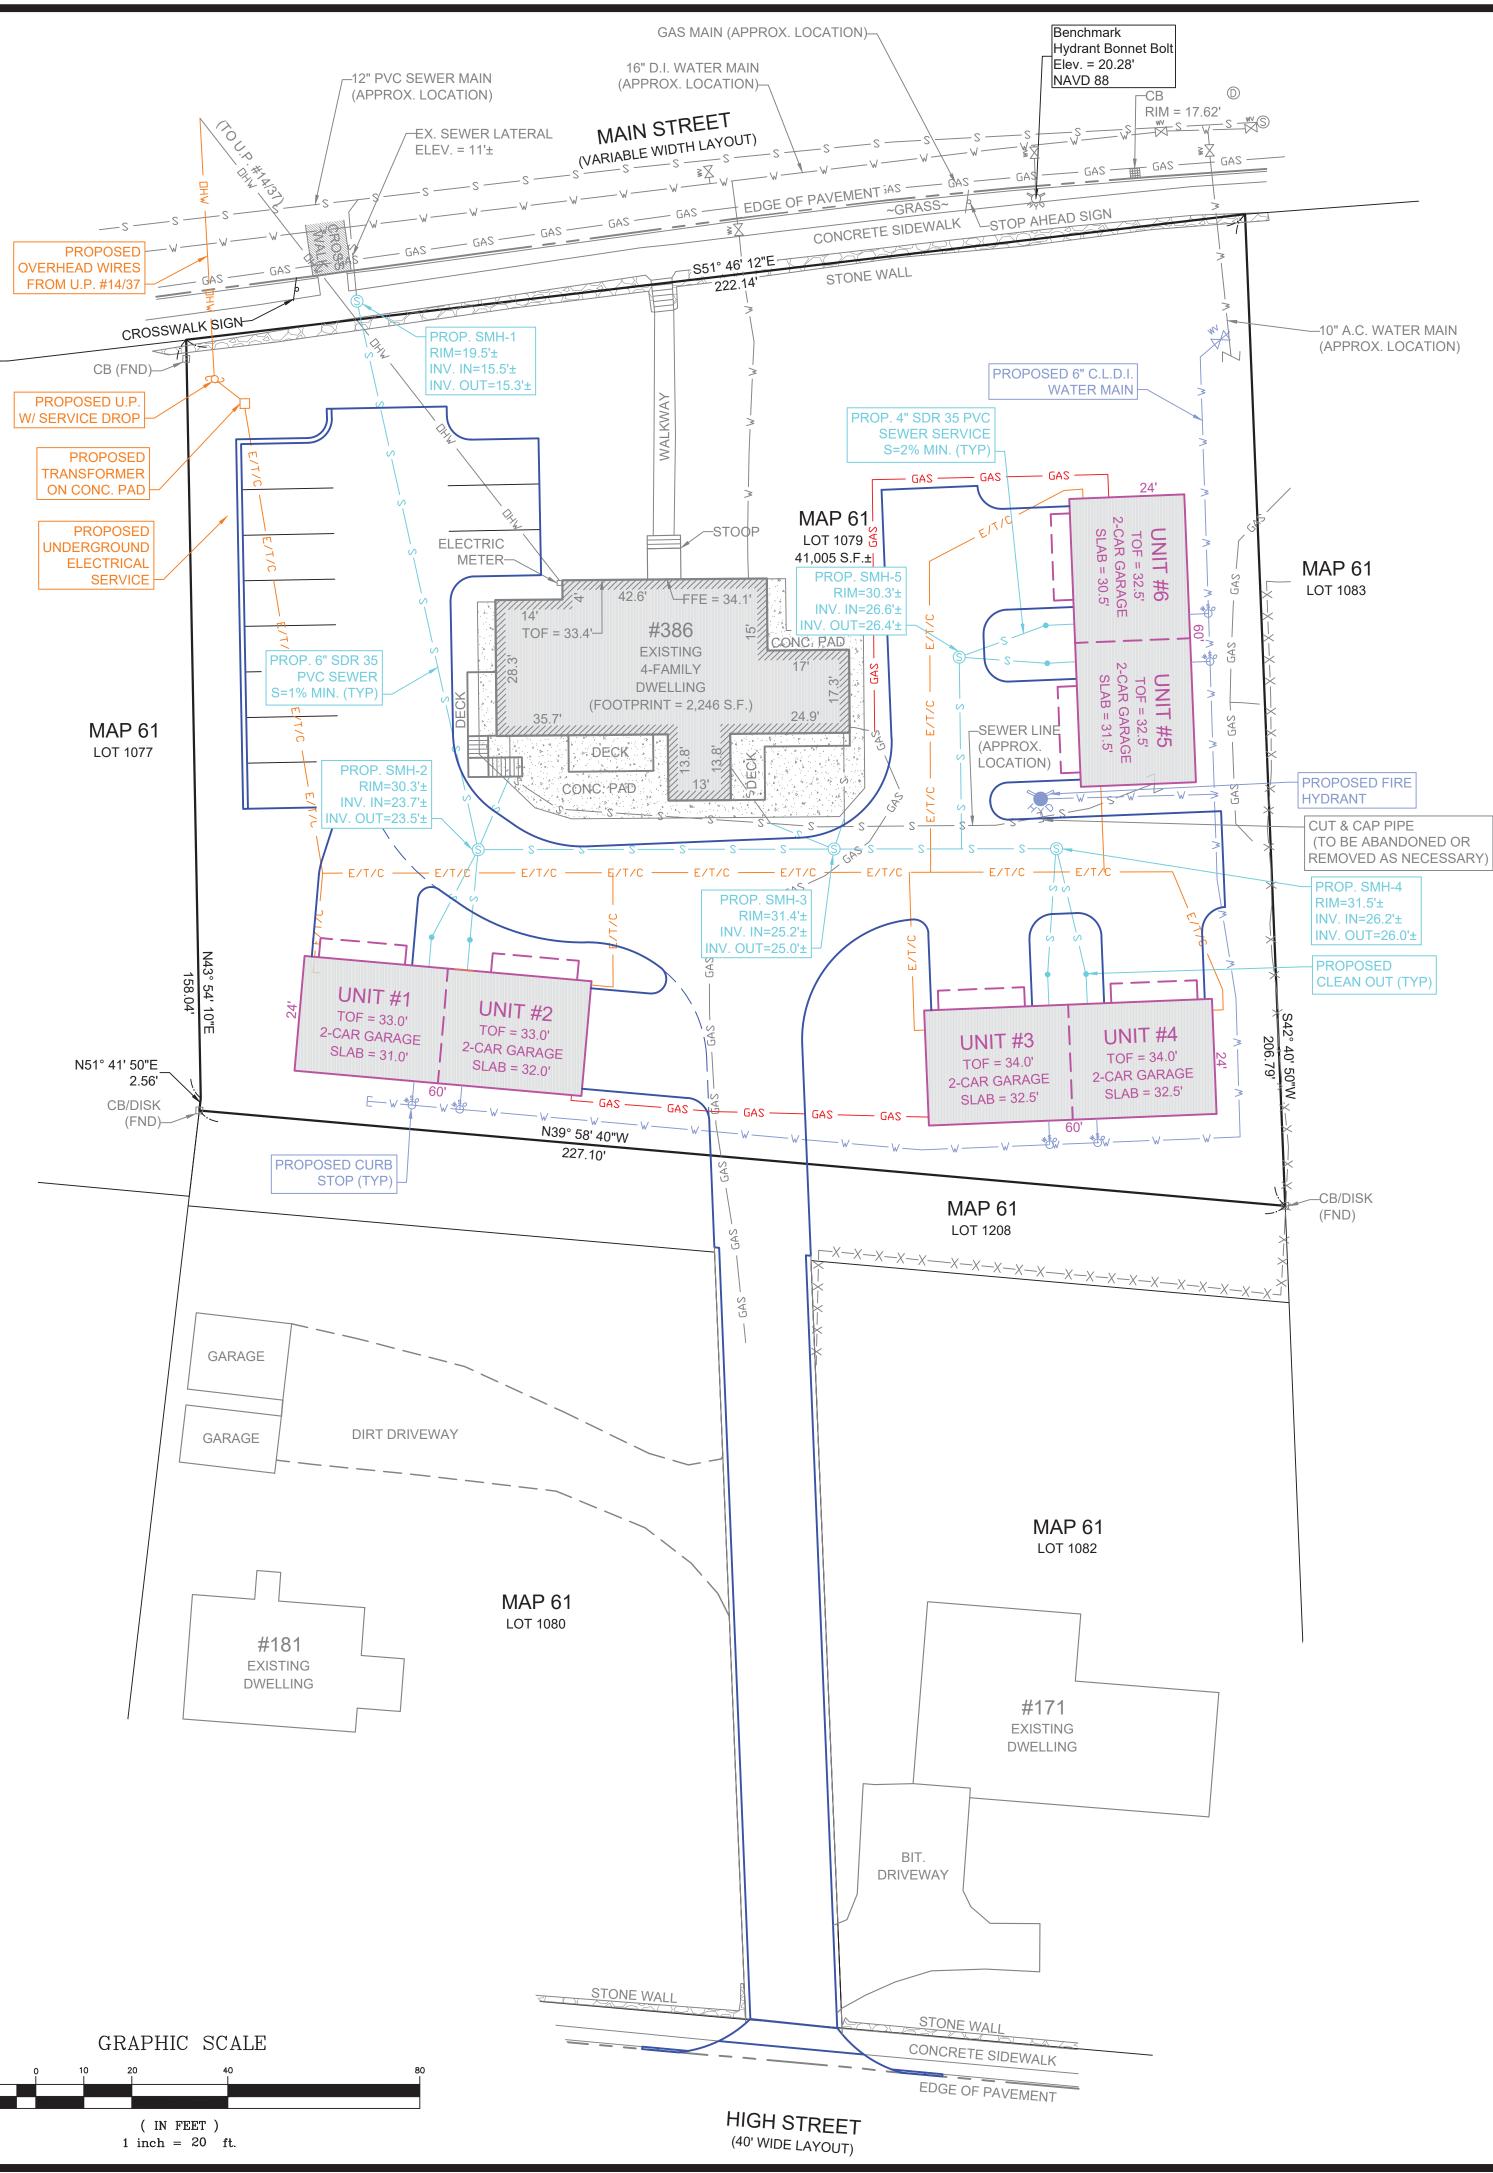



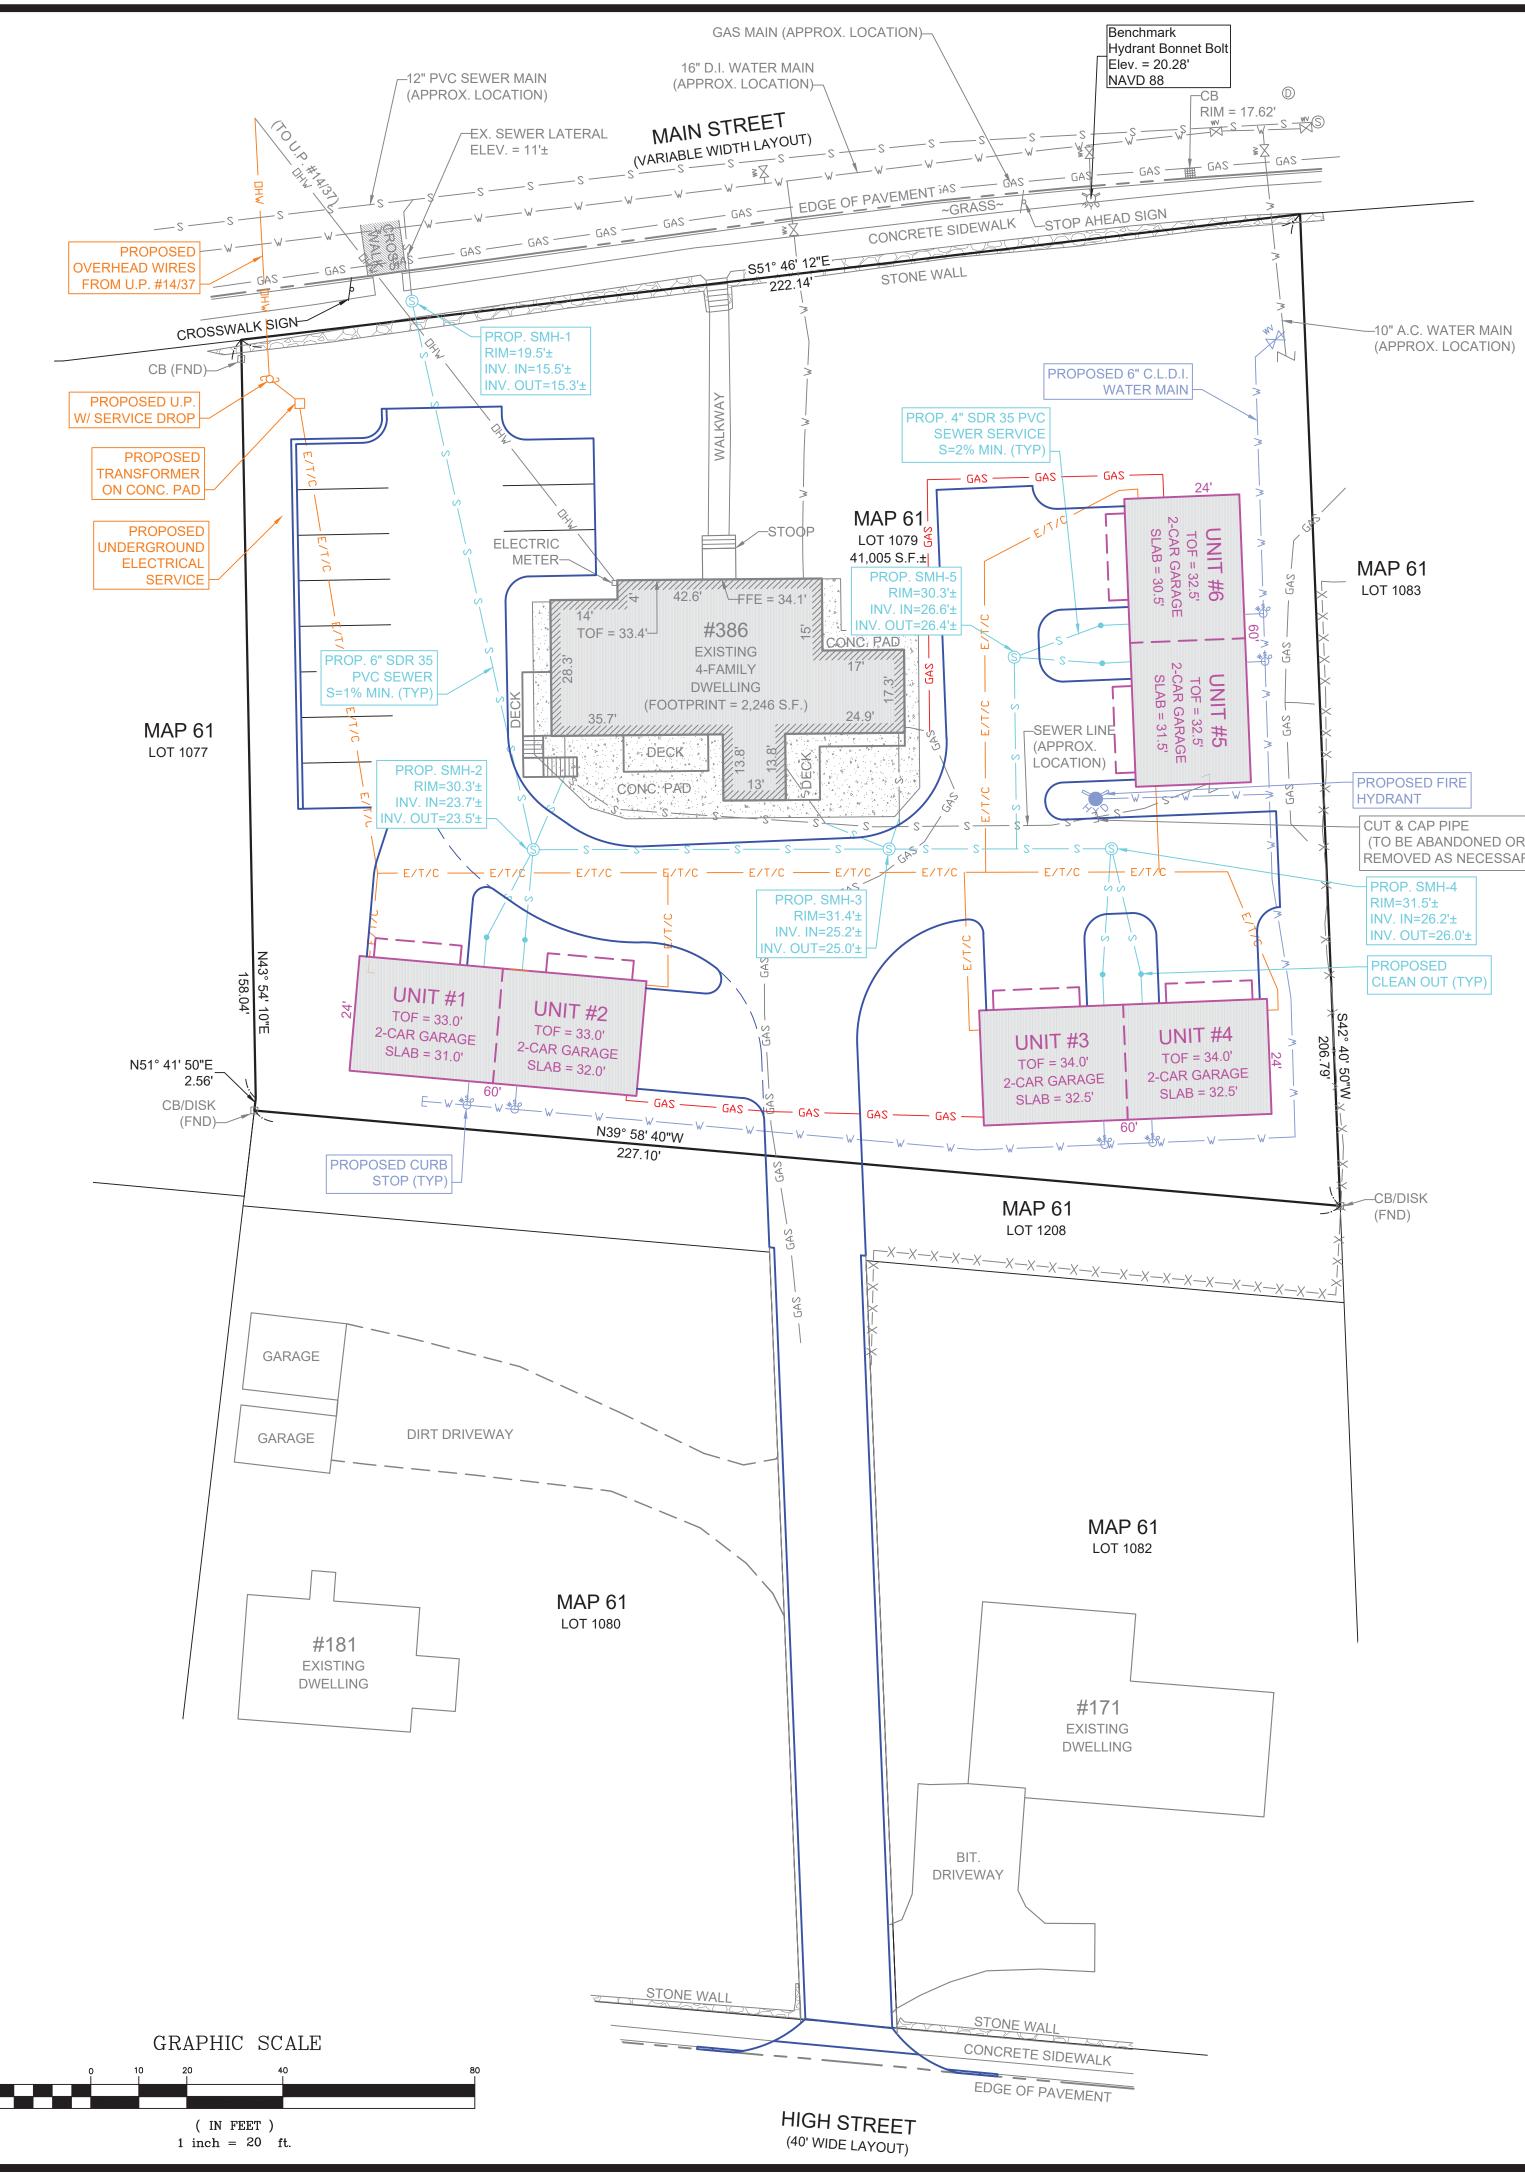


Image: state stat
JOHN L. CHURCHILL JR., P.L.S. DATE
JOHN L. CHURCHILL JR., P.E. DATE
· · · · ·
PROPOSED SITE PLAN
386 MAIN STREET IN WAREHAM MASSACHUSETTS (PLYMOUTH COUNTY) UTILITIES
REVISIONS:No.DATEDESC.16-28-23MEETING COMMENTS27-25-23MEETING COMMENTS38-7-23SITE PLAN REVIEW49-13-23PEER REVIEW COMMENTS59-25-23MEETING COMMENTS611-2-23PEER REVIEW COMMENTS
PREPARED FOR: ANGELA MCKEOWN 484 LIBERTY STREET ROCKLAND, MA 02370
PREPARED BY: JC ENGINEERING, INC 2854 CRANBERRY HIGHWAY
EAST WAREHAM, MA 02538 508-273-0377
EAST WAREHAM, MA 02538
EAST WAREHAM, MA 02538
EAST WAREHAM, MA 02538 508-273-0377 DATE: MARCH 21, 2023 FIELD: BM/JF
EAST WAREHAM, MA 02538 508-273-0377 DATE: MARCH 21, 2023
EAST WAREHAM, MA 02538 508-273-0377
EAST WAREHAM, MA 02538 508-273-0377 DATE: MARCH 21, 2023 FIELD: BM/JF CALC./DESIGN: SJI DRAWN: SJI

GRADING & DRAINAGE NOTES:

- 1. ALL CUT & FILL SLOPES SHALL BE 3:1 OR FLATTER UNLESS OTHERWISE NOTED ON THIS PLAN.
- 2. EXISTING AND PROPOSED GRADE CONTOURS ARE SHOWN AT 2-FT INTERVALS.
- 3. MINIMUM COVER OVER PIPE SHALL NOT BE LESS THAN 1.0 FEET.
- 4. THE DRIVEWAY SHALL NOT BE PAVED UNTIL THE ENTIRE PERMANENT DRAINAGE SYSTEM HAS BEEN INSTALLED AND PIPE CONNECTIONS COMPLETE. CONTRACTOR SHALL NOTIFY ENGINEER PRIOR TO BACKFILL FOR INSPECTION.
- 5. THE CONTRACTOR SHALL BE RESPONSIBLE FOR THE PROPER INSPECTION AND MAINTENANCE OF ALL STORMWATER MANAGEMENT FACILITIES UNTIL SUCH TIME THAT THE DRIVEWAY, BUILDINGS, AND ASSOCIATED UTILITIES ARE ACCEPTED BY THE OWNER.
- 6. THE CONTRACTOR SHALL EXCAVATE TO A DEPTH OF 4 FEET BELOW THE BOTTOM ELEVATION OF ALL INFILTRATION SYSTEMS IN THEIR RESPECTIVE LOCATIONS. ENGINEER SHALL WITNESS THE ONSITE EXCAVATION TO VERIFY SOIL CONDITIONS ARE CONSISTENT WITH THE TEST PITS AND ENSURE GROUNDWATER IS NOT ENCOUNTERED.

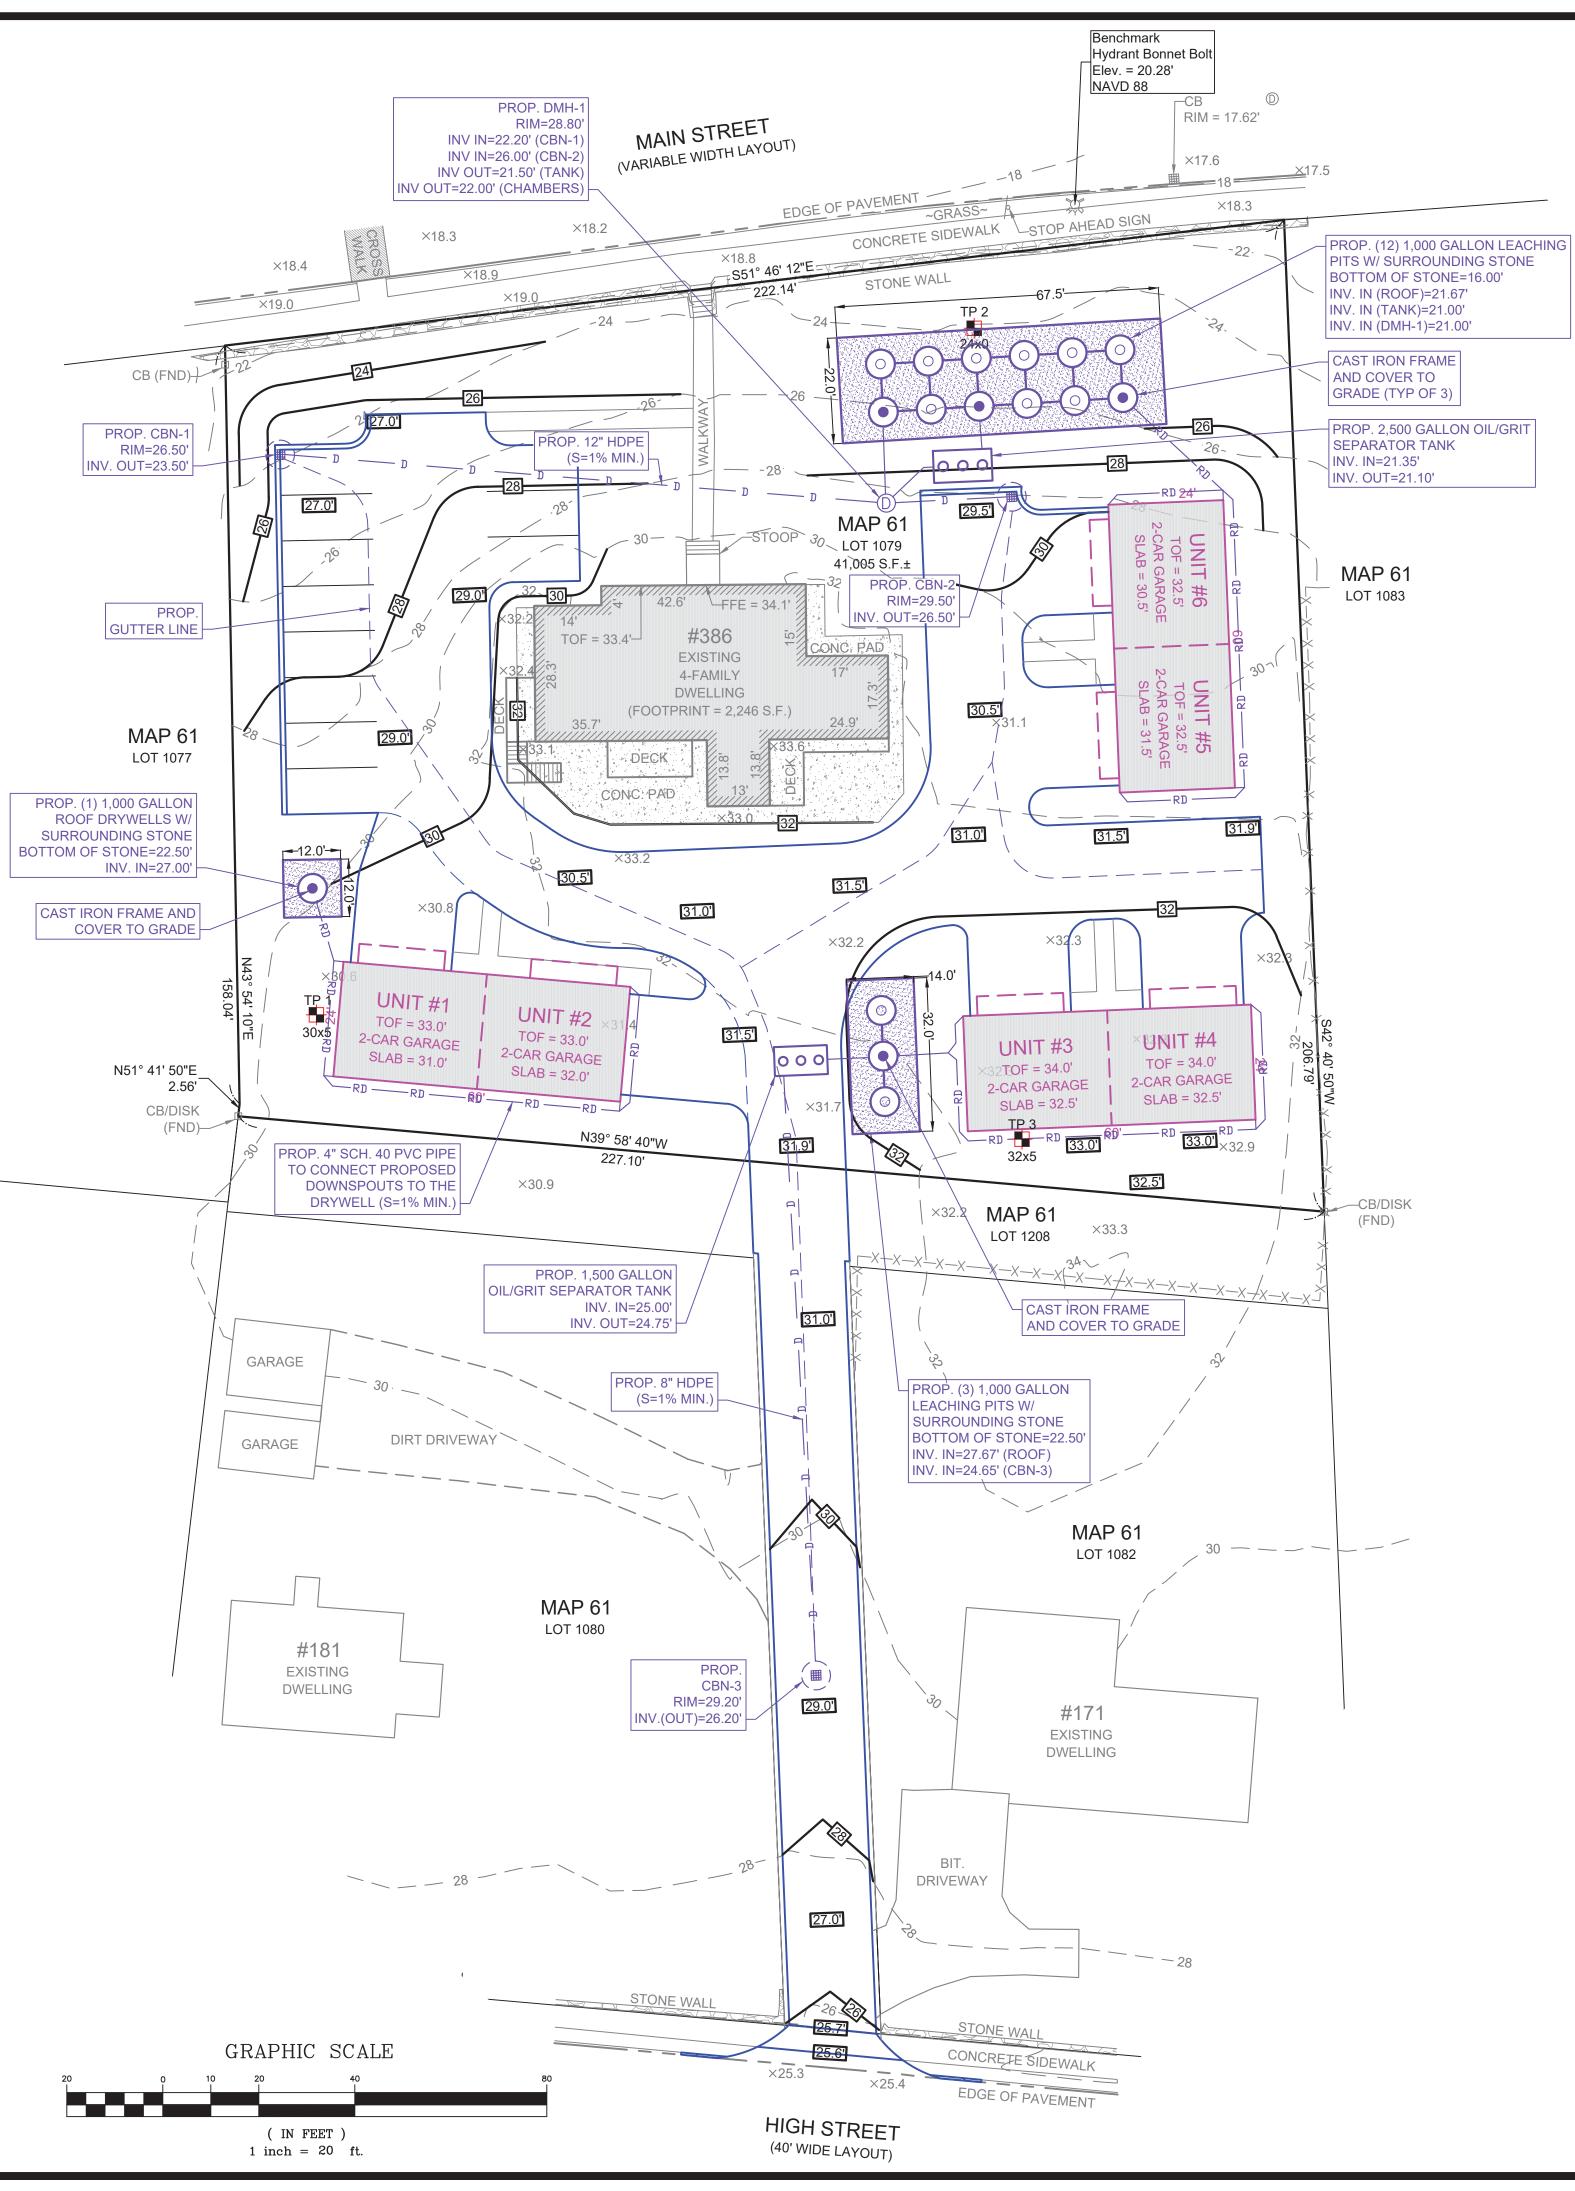

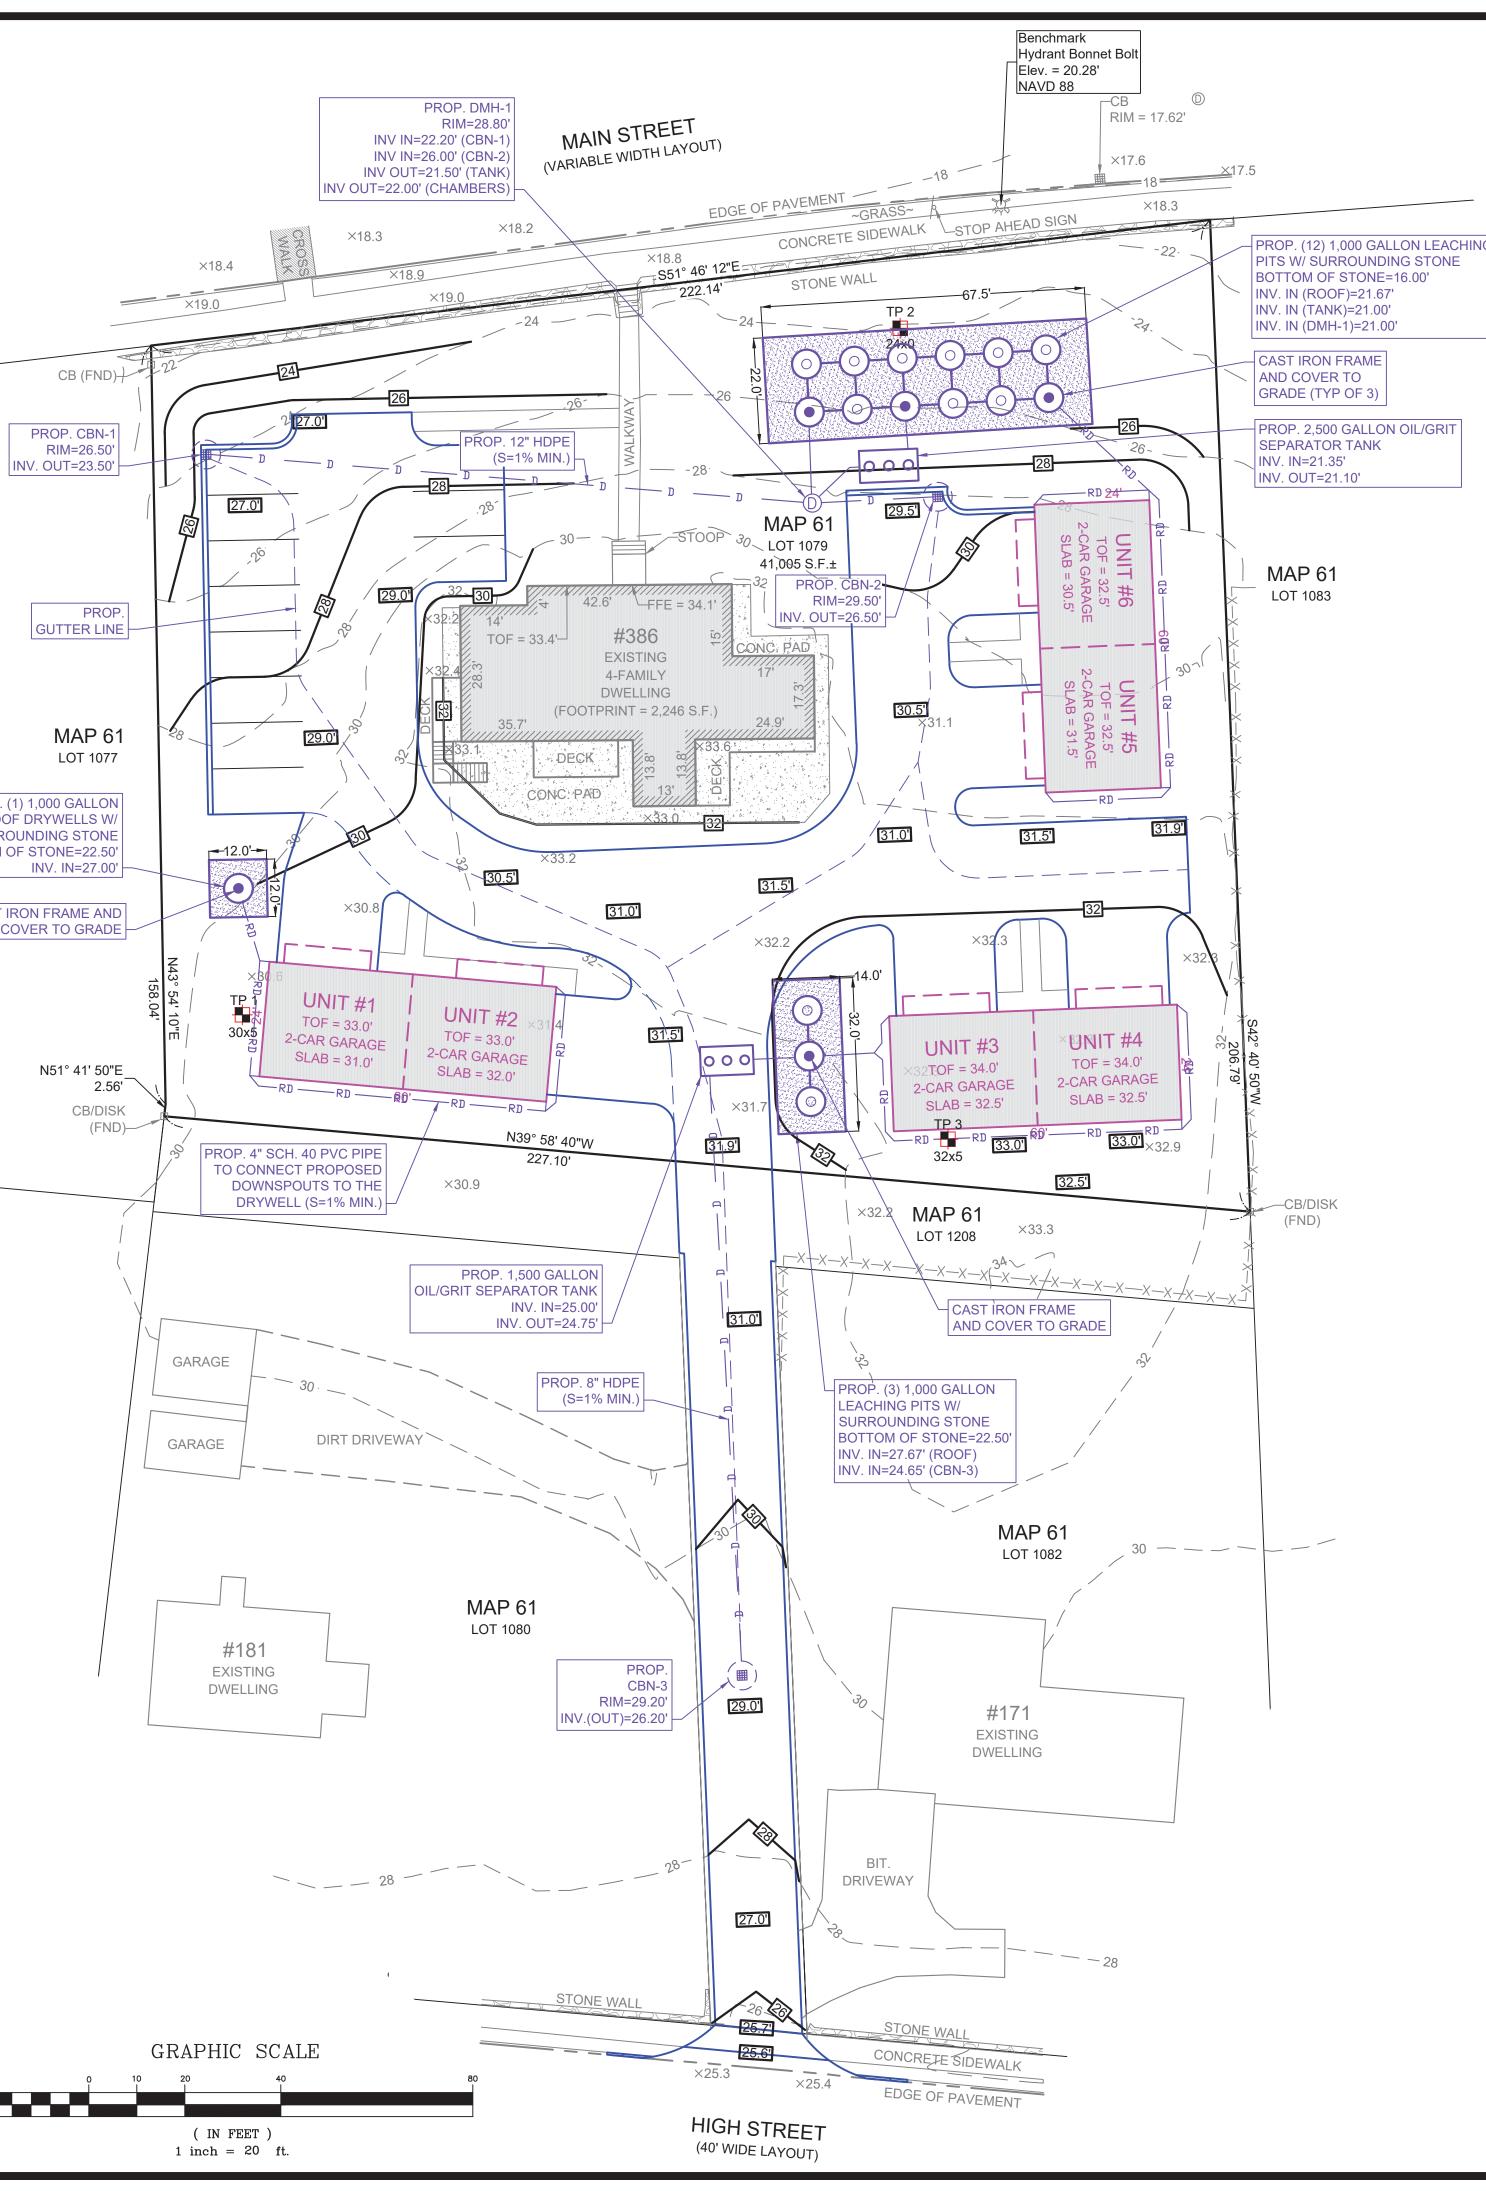

<image/>
JOHN L. JOHN L. CHURCHILL JR. NO. 48066 OAV LAND
JOHN L. CHURCHILL JR., P.L.S. DATE
JOHN L. CHURCHILL JR., P.E. DATE
PROPOSED SITE PLAN
AT 386 MAIN STREET
WAREHAM MASSACHUSETTS
(PLYMOUTH COUNTY)
REVISIONS:No.DATEDESC.17-11-23MEETING COMMENTS27-25-23MEETING COMMENTS38-7-23SITE PLAN REVIEW49-13-23PEER REVIEW COMMENTS59-25-23MEETING COMMENTS611-2-23PEER REVIEW COMMENTS
<u>PREPARED FOR:</u> ANGELA MCKEOWN 484 LIBERTY STREET ROCKLAND, MA 02370
PREPARED BY: JC ENGINEERING, INC 2854 CRANBERRY HIGHWAY EAST WAREHAM, MA 02538 508-273-0377
DATE: MARCH 21, 2023
FIELD: BM/JF CALC./DESIGN: SJI
DRAWN: SJI
CHECK: JLC JOB NO: 6028

PLANTING NOTES:

1. ALL PLANT MATERIAL SHALL CONFORM TO THE STANDARDS OF THE AMERICAN ASSOCIATION OF NURSERYMEN ANSI Z260.1 OR THE LATEST EDITION. ALL PLANT MATERIAL SHALL BE TRUE TO SPECIES, VARIETY AND SIZE AND SHALL BE CERTIFIED DISEASE AND INSECT FREE AT THE TIME OF DELIVERY TO THE SITE. THE OWNER AND/OR LANDSCAPE ARCHITECT RESERVES THE RIGHT TO APPROVE OR REJECT THE PLANT MATERIAL ON SITE PRIOR TO INSTALLATION.

2. THE LANDSCAPE ARCHITECT SHALL SPECIFY AN ACCEPTABLE REPLACEMENT SHOULD ANY PLANT MATERIAL BE UNAVAILABLE AT TIME OF DELIVERY.

3. ALL PLANT MATERIAL SHALL BE PROPERLY PLANTED AND STAKED IN CONFORMANCE WITH THE DETAILS PROVIDED. PROVIDE THREE (3) STAKES PER TREE UNLESS OTHERWISE NOTED. INSTALL ALL PLANT MATERIAL ON UNDISTURBED GRADE OR GRADES THAT HAVE BEEN ESTABLISHED DURING CONSTRUCTION AND APPROVED BY THE LANDSCAPE ARCHITECT. FURNISH ALL PLANT MATERIAL IN APPROVED CONTAINERS OR BALLED AND BURLAPPED. CUT AND REMOVE BURLAP FROM THE TOP ONE-THIRD (1/3) OF THE ROOT BALL. ENTIRELY REMOVE ALL WIRE ROOT BALL BASKETS FROM THE PLANTING PIT PRIOR TO FINAL BACKFILLING OF PLANTING PIT.

4. PROVIDE PLANTING PITS AS INDICATED ON THE PLANTING DETAILS. BACKFILL PLANTING PITS WITH ONE PART EACH OF TOPSOIL, ONE PART PEAT MOSS OR COMPOSTED LEAF MATTER (TWO YEARS OLD), AND ONE PART EXISTING SOILS ON THE SITE. IF IN THE OPINION OF THE LANDSCAPE ARCHITECT EXCESSIVELY WET SOIL CONDITIONS EXIST, THEN PLANTING PITS SHALL BE EXCAVATED AN ADDITIONAL 12" AND FILLED WITH SAND TO THE BOTTOM OF THE PLANT PIT. A SLOW RELEASE FERTILIZER SHALL BE ADDED TO THE BACKFILL MIX IN ACCORDANCE WITH MANUFACTURER'S RECOMMENDATIONS FOR NEW TRANSPLANTS.

5. NEWLY INSTALLED PANT MATERIAL SHALL BE WATERED AT THE TIME OF THE INSTALLATION AND AGAIN WITHIN 24 HOURS OF THE INSTALLATION. REGULAR WATERING SHALL BE PROVIDED BY THE LANDSCAPE CONTRACTOR TO ENSURE ESTABLISHMENT, GROWTH AND SURVIVAL OF ALL PLANTS.

6. ALL PLANT MATERIAL SHALL BE GUARANTEED FOR A PERIOD OF TWO YEARS AFTER THE DATE OF FINAL ACCEPTANCE BY THE LANDSCAPE ARCHITECT. ANY PLANT THAT DIES WITHIN THE GUARANTEE PERIOD SHALL BE REMOVED (INCLUDING THE ROOT BALL) AND REPLACED WITH A SPECIMEN OF THE SAME VARIETY AND SIZE AS THE ORIGINALLY SPECIFIED PLANT, AT THE EXPENSE OF THE LANDSCAPE CONTRACTOR.

7. THE LANDSCAPE CONTACTOR SHALL FURNISH A MINIMUM OF 24" OF TOPSOIL IN ALL PLANTING BEDS. A COMPLETE SOIL ANALYSIS SHALL BE CONDUCTED BY THE LANDSCAPE CONTRACTOR PRIOR TO PLANTING TO DETERMINE THE EXTENT OF MODIFICATIONS NECESSARY TO THE PH AND NUTRIENT LEVELS OF THE PLANTING SOIL TO ENSURE SURVIVAL OF THE PLANTS. THE CONTRACTOR SHALL FURNISH THE TEST RESULTS TO THE LANDSCAPE ARCHITECT FOR REVIEW AND APPROVAL PRIOR TO PLANTING.

8. ALL PLANTING BEDS AND TREE WELLS SHALL RECEIVE A 3" MINIMUM LAYER OF FINELY SHREDDED PINE BARK. THE LANDSCAPE CONTRACTOR SHALL SUBMIT A SAMPLE OF THE MULCH TO THE LANDSCAPE ARCHITECT PRIOR TO DELIVERY OF THE MULCH TO THE SITE.

9. ALL SHRUB MASSES SHALL BE PLANTED IN CONTINUOUS MULCHED BEDS.

10. IN THE CASE OF A DISCREPANCY BETWEEN THE QUANTITIES LISTED IN THE PLANT SCHEDULE AND THOSE ILLUSTRATED IN THE PLAN, THE PLAN SHALL RULE.

11. ALL LANDSCAPE AREAS NOT PLANTED WITH TREES, SHRUBS, GROUND COVER OR SOD SHALL BE RESTORES WITH 6" OF TOPSOIL AND SHALL BE SEEDED AS INDICATED ON THE PLANS. (T & S)

12. APPLICATION OF GRASS SEED FERTILIZER AND MULCH SHALL BE ACCOMPLISHED BY BROADCAST OR HYDRO

SEEDING AT THE RATES OUTLINED BELOW: LIMESTONE: 100 LBS / 1000 SF

FERTILIZER; USE LOW PHOSPHATE AND SLOW RELEASE NITROGEN FERTILIZER 1000 LBS/ACRE


SEED MIX	
CREEPING RED FESCUE	
TALL FESCUE	
PERENNIAL RYE	
RED TOP	

BS/A	CRE
20	
15	
5	
2	

NOTE:

THE LANDSCAPE ARCHITECT HAS CONDUCTED A SITE VISIT TO EXAMINE THE EXISTING TREES ALONG MAIN STREET.

PLANT	SCHEDULE					
SYMBOL	BOTANICAL NAME	COMMON NAME	SIZE	COMMENTS	REMARKS	QUANTITY
SHRUBS						
JCBP	Juniperus chinensis 'Blue Point'	Blue Point Chinese Upright Juniper	7'-8' ht	B & B	plant 7' on center	11
MD	Microbiota decussata	Siberian Carpet Cypress	18" - 24" spr.	3 gal.	plant 3' on center	16
RKO	Rosa 'Knock Out' Double	Double Red Knock Out Shrub Rose	24"- 30" ht	5 gallon	plant 5' on center	9
RPJM	Rhododendrom 'PJM'	PJM Rhododendrom	36" ht	5 gallon or B & B	plant 5' on center	10
			400 040	0 11		•
SJNF	Spiraea japonica 'Neon Flash'	Neon Flash Spirea	18" - 24" spr.	3 gallon	plant 3' on center	8
SJNF	Spiraea japonica 'Neon Flash'	Neon Flash Spirea	18" - 24" spr.	3 gallon	plant 3' on center	8
	Spiraea japonica 'Neon Flash' ORNAMENTAL TREES	Neon Flash Spirea	18" - 24" spr.	3 gallon	plant 3' on center	8
	na tao ang	Neon Flash Spirea	18" - 24" spr. 3" cal.	3 gallon B & B		8
SHADE &	ORNAMENTAL TREES		100000 0222553 0324 0534	A	plant as shown	2 8
SHADE & O	ORNAMENTAL TREES Acer rubrum 'October Glory'	October Glory Red Maple	3" cal.	B & B	plant as shown plant as shown-single stem form	4
SHADE & O ARO CK	ORNAMENTAL TREES Acer rubrum 'October Glory' Cornus kousa	October Glory Red Maple Kousa Dogwood	3" cal. 3" cal.	B & B B & B	plant as shown	4 4
SHADE & ARO CK CL TOS	ORNAMENTAL TREES Acer rubrum 'October Glory' Cornus kousa Cupressus x leylandii Thuja Occidentalis' Smaragd'	October Glory Red Maple Kousa Dogwood Leyland Cypress	3" cal. 3" cal. 7'- 8' ht.	B & B B & B B & B	plant as shown plant as shown-single stem form plant 8'on center- 2 rows staggered	4 4 17
SHADE & ARO CK CL TOS	ORNAMENTAL TREES Acer rubrum 'October Glory' Cornus kousa Cupressus x leylandii	October Glory Red Maple Kousa Dogwood Leyland Cypress	3" cal. 3" cal. 7'- 8' ht.	B & B B & B B & B	plant as shown plant as shown-single stem form plant 8'on center- 2 rows staggered	4 4 17

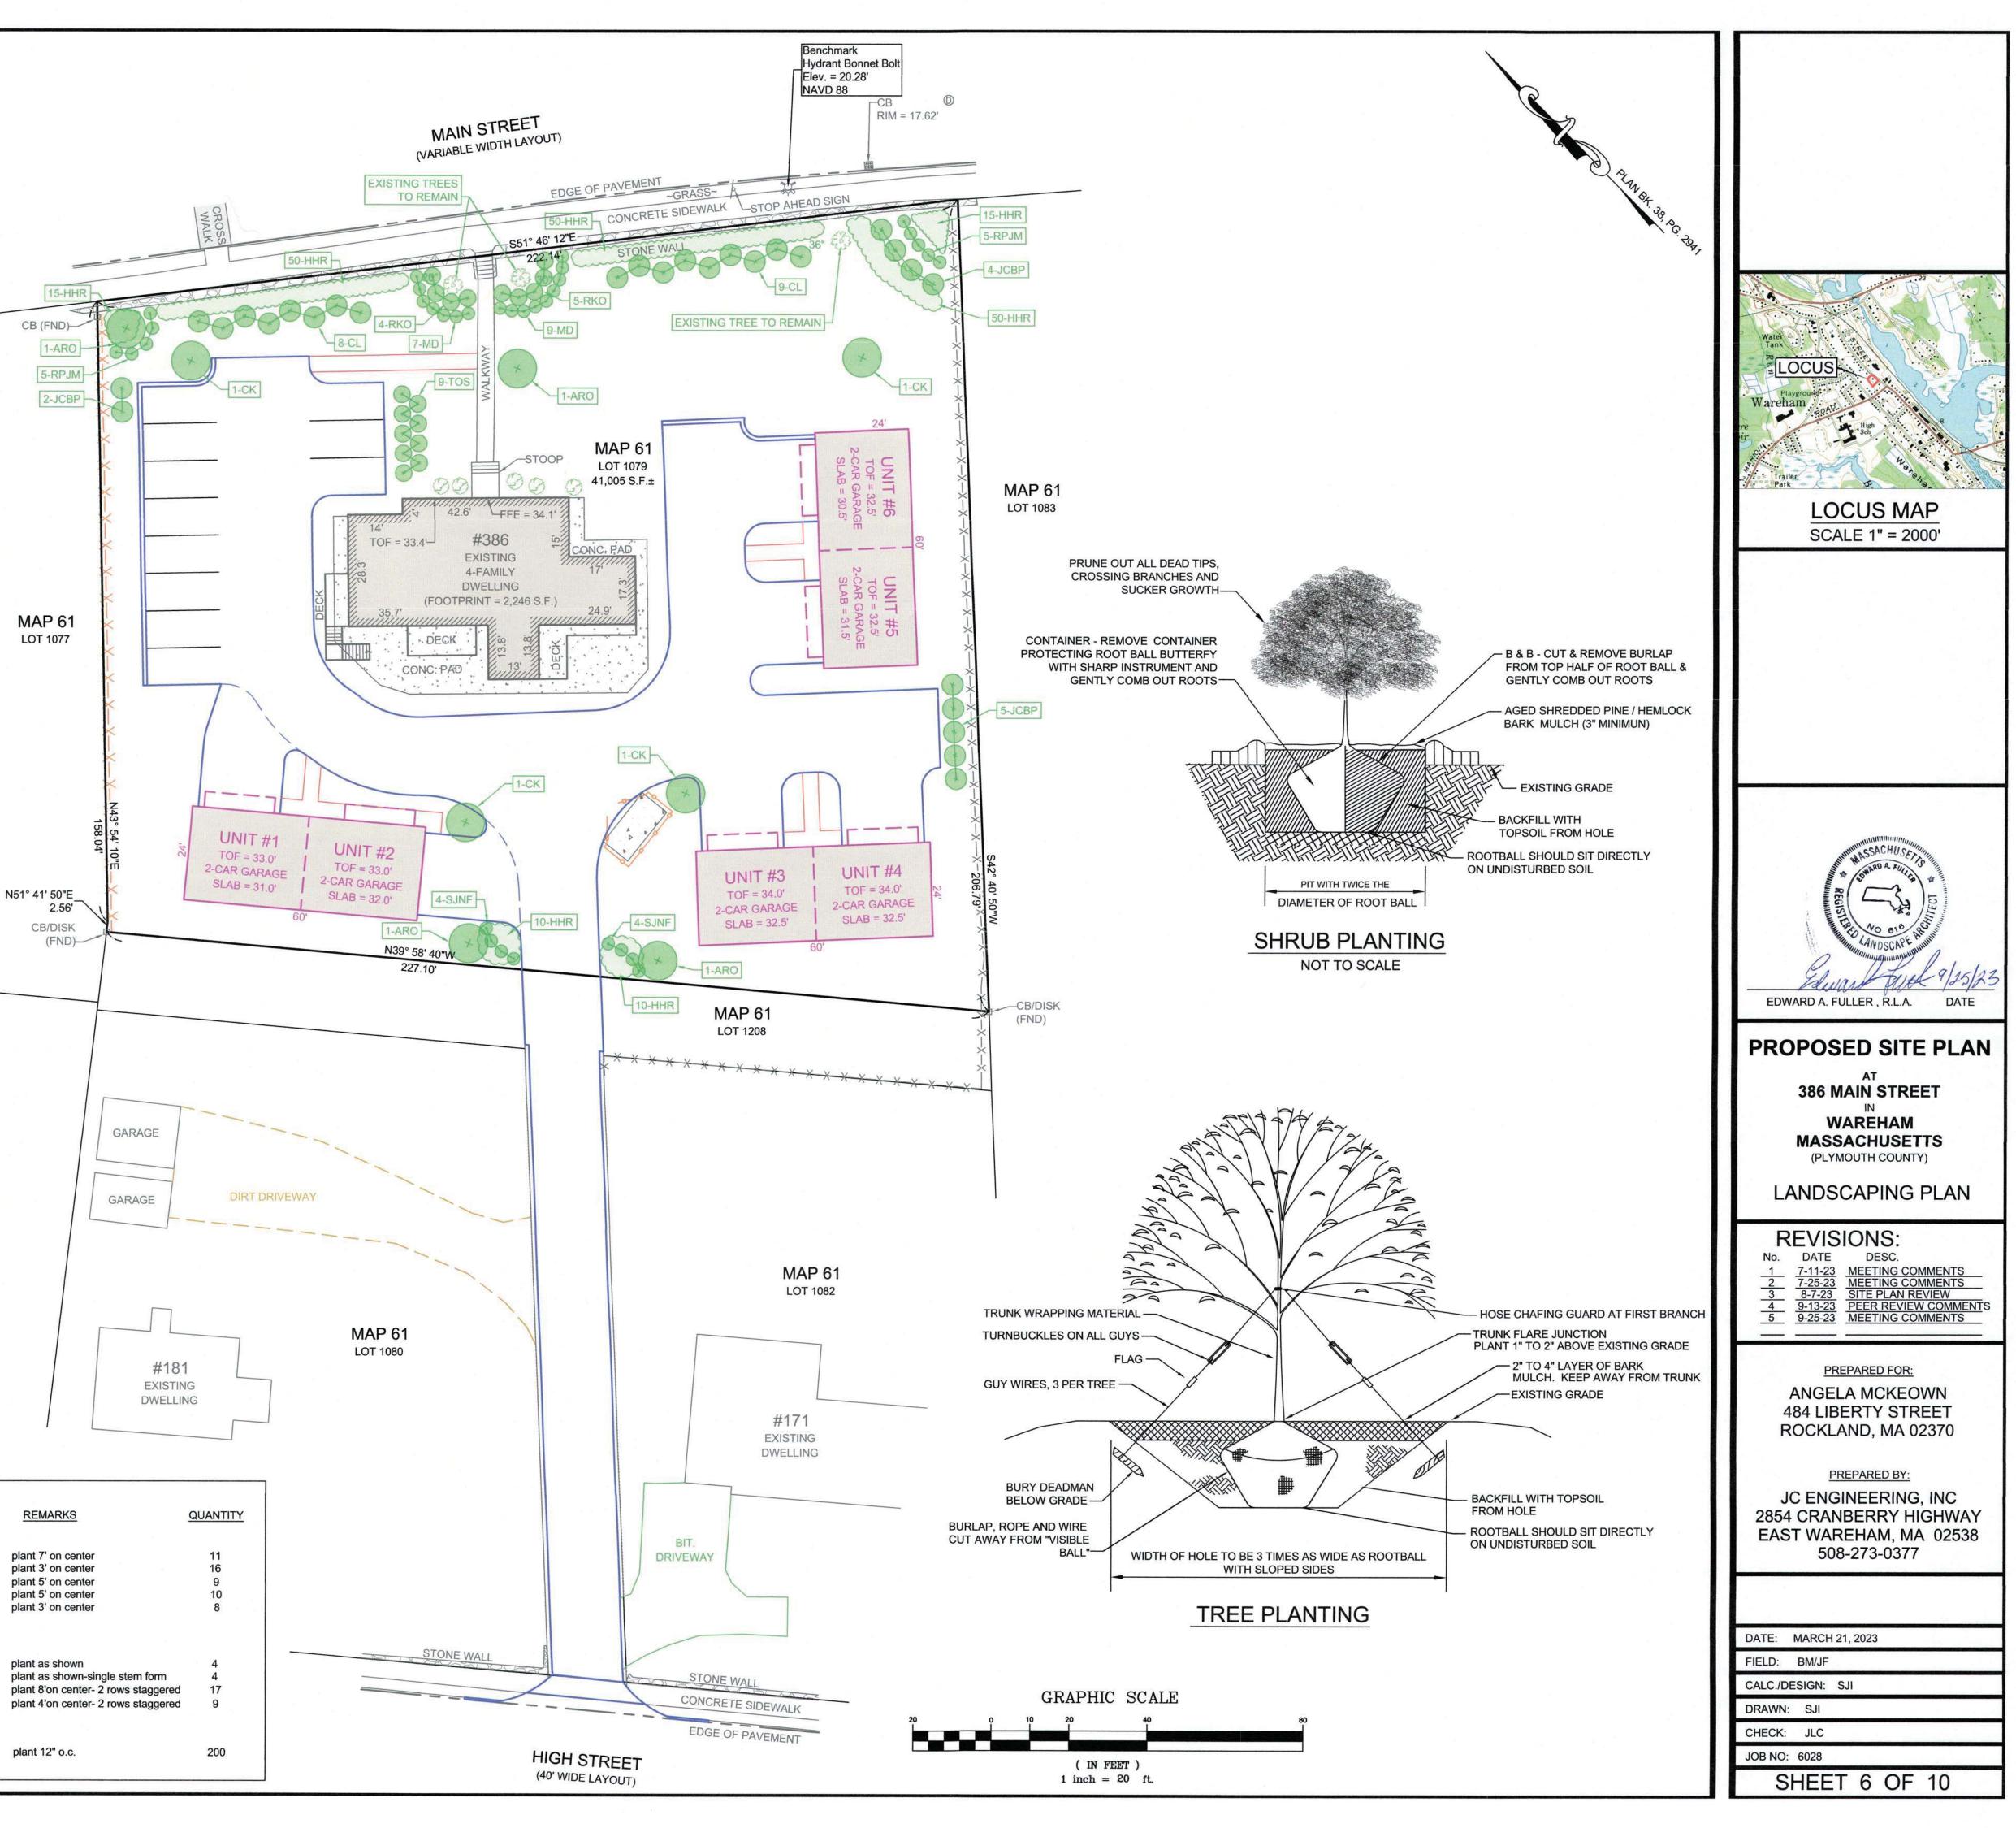

AREA & ROADWAY LIGHTING

PROJECT NAME:

PROJECT TYPE:

RAZAR SERIES - LED LOW PROFILE AREA LUMINAIRE

Optical Housing

Heavy cast, low copper aluminum assembly (A356 alloy, <.2% copper) minimum wall thickness .188". LED Module mounting area is machined to within a 0.002" surface flatness variance for maximum surface contact and thermal conductivity from the LED modules to the radiating fins. Passive radiating fins above the LED Optics provide superior thermal management and long LED life. The optical and electrical compartments are integrated with the support arm to create one assembly. Cast and hinged driver

compartment cover allows access to the drivers and wiring.

Electrical Housing w/ Integrated Arm Heavy cast low copper aluminum (A356 alloy; <0.2% copper) assembly with integral cooling ribs surrounding the electrical compartment and a flat surface on the top of the arm to accommodate a photocell receptacle. Solid barrier wall separates optical and electrical compartments. The optical compartment and electrical compartment with the integrated support arm combine to create one assembly. Minimum wall thickness is .188". Cast and hinged driver assembly cover is integrated with wiring compartment cover

PLED[®] Optics Emitters (LED's) are arrayed on a metal core PCB panel with each emitter

located on a copper thermal transfer pad and enclosed by an LED refractor. LED optics completely seal each individual emitter to meet an IP66 rating. In asymmetric distributions, a micro-reflector inside the refractor re-directs the house side emitter output towards the street side and functions as a house side shielding element. Refractors are injection molded H12 acrylic. Each LED refractor is sealed to the PCB over an emitter and all refractors are retained by an aluminum frame. Any one Panel, or group of Panels in a luminaire, have the same optical pattern. LED refractors produce standard site/area distributions. Panels are field replaceable and field rotatable in 90° increments.

LED Driver(s)

Constant current electronic with a power factor of >.90 and a minimum operating temperature of -40°F/-40°C. Driver(s) is/are UL and cUL ecognized and mounted directly against the Electrical Housing to facilitate thermal transfer, held down by universal clamps to facilitate easy removal. In-line terminal blocks facilitate wiring between the driver and optical arrays. Drivers accept an input of 120-277V, 50/60Hz or 347V-480V, 50,60Hz. (0 - 10V dimmable driver is standard. Driver has a minimum of 3KV internal surge protection. Luminaire supplied with 20KV surge protector for field accessible installation.)

LED Emitters

High output LED's are utilized with drive currents ranging from 350mA to 1050mA. 70CRI Minimum. LED's are available in standard Neutral White (4000K), or optional Cool White (5000K) or Warm White (3000K). Consult actory for other LED options.


Amber LED's TRA (True Amber) LED's utilize material that emits light in the amber spectral bandwidth only without the use of phosphors.

Electrostatically applied TGIC Polyester Powder Coat on substrate prepared with 20 PSI power wash at 140°F. Four step media blast and iron phosphate pretreatment for protection and paint adhesion. 400°F bake for maximum hardness and durability.

Mast Arm Fitter/Electrical Housing

Replaces standard Electrical Housing. Fits standard 2 3/8" O.D. horizontal tenon. Two (2) straps with two (2) bolts each encircle the lower half of the tenon. Upper half of the tenon rests on self-centering steps that position the angle of the luminaire at 0° , +1.5°, +1.5 or +3° up from the horizontal. All ardware is stainless steel.

U.S. Pole Company Inc An Employee Owned Company Phone (661) 233-2000 www.usaltg.com

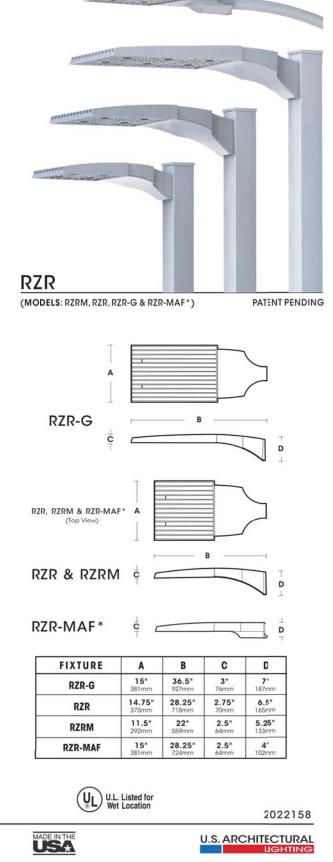

AREA & ROADWAY LIGHTING

Small Neoclassical, Domed Bell Luminaire

Features

The NEW Deziner Series is a flexible, configurable pedestrian scale decorative pendant luminaire with an 6.7" diameter upper housing of 0.125" thick formed aluminum with a large assortment of spun aluminum shades and ornamental options. Each lower housing is comprised of a 0.080" thick spun aluminum reflector with an integrated LED module seat, thermal management for long LED life and a thermally isolated solid state power supply chamber. Trulevel ™ ball coupling.

PLED[™] Optics

Emitters (LED's) are arrayed on a metal core PCB panel with each emitter located on a copper thermal transfer pad and enclosed by an LED refractor. LED optics completely seal each individual emitter to meet an IP66 rating. In asymmetric distributions, a micro-reflector inside the refractor re-directs the house side emitter output towards the street side and functions as a house side shielding element. Refractors are injection molded H12 acrylic. Each LED refractor is sealed to the PCB over an emitter and all refractors are retained by an aluminum frame. Any one Panel, or group of Panels in a luminaire, have the same optical pattern. LED refractors produce standard site/area distributions. All optics are U0, Zero Uplight and are Dark Sky compliant. Panels are field replaceable and field rotatable in 90° increments.

LED Emitters

High Power White LED's are driven between 350mA and 875mA for a maximum output of 2.5 Watts nominal. LED's are available in standard Warm White (2700K & 3000K), Neutral White (4000K), or Cool White (5000K). All Standard LED's have a minimum of 70 CRI. Consult Factory for other LED options. Lumen Maintenance of L93 at 100,000 hours (TM-21 calculated at 6x Test Time) for all LED options.

True Amber LED's TRA-True Amber LED's emit light in the amber spectral bandwidth centered on 585-590nm. True Amber has negligible blue light and is suitable for wildlife.

LED Driver

Constant current electronic with a power factor of >.90 and a minimum operating temperature of -40°F/-40°C. Driver(s) is/are UL and cUL recognized and mounted directly against the Electrical Housing to facilitate thermal transfer, held down by universal clamps to facilitate easy removal. In-line terminal blocks facilitate wiring between the driver and optical arrays. Drivers accept an input of 120-277V (UNV), 50/60Hz or 347V & 480V, 50,60Hz. 0 - 10V dimmable driver is standard. Driver has a minimum of 3KV internal surge protection. Luminaire supplied with 20KV surge protector for field accessible installation.)

Finish

Super TGIC polyester powder coating is applied onto a metal substrate this has been pretreated with a four-stage process for maximum adhesion and color retention. The top coat is baked at 400° F for maximum hardness and exterior durability.



PROJECT NAME:

PROJECT TYPE:





•_____ 16" _____ 406mm

DS6D Deep Bell

The smallest models within the Deziner Series, offer 5 customizable styles available with optional Ambience[™] Low Luminance Lens and unlit Bands.


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APEX LIGHTING SOLUTIONS WORKPLANE/CALC PLANE: AT FINIS MOUNTING HEIGHT: SEE LUMINAIRE APPS: DM SALES: SS SPECIFIER: JC ENGINEERING							
Luminaire Schedule							
Qty	Label	Arrangement					
1	SL2A	Single					
3	SL2B	Single					
1	SL3	Single					
17	WM	Single					
Calculation Summary							
Label							
CalcPt	s_1						

PARKING AND DRIVE LANES

U.S. Pole Company Inc | 660 West Avenue O, Palmdale, CA 93551 An Employee Owned Company | Phone (661) 233-2000 www.usaltg.com



Lumens	Input Watts	LLF	BUG Rating		Description		
4594	42.7	0.900	B1-U0-G1		USAL RZR-PLED-II-40LED-350mA-30K-HS-VOLT-FINISH / MOUNTED TO POLE @ 20FT		
2406	23.6	0.900	B0-U0-G1		USAL DS6C-PLE	D-II-20LED-350	mA-30K-HS-VOLT-FINISH / MOUNTED TO POLE @ 20FT
6392	42.7	0.900	B2-U0-G2		USAL RZR-PLED-III-M-40LED-350mA-30K-VOLT-FINISH / MOUNTED TO POLE @ 20FT		
964	10.5	0.900	B1-U0-G0		LUMENART AWL.18-11W LEDUNV-3000K-W-FINISH / WALL MOUNTED @ 15FT AFG TO BOF		
			•]
	Grid Height	Avg	Max	Min	Avg/Min	Max/Min	

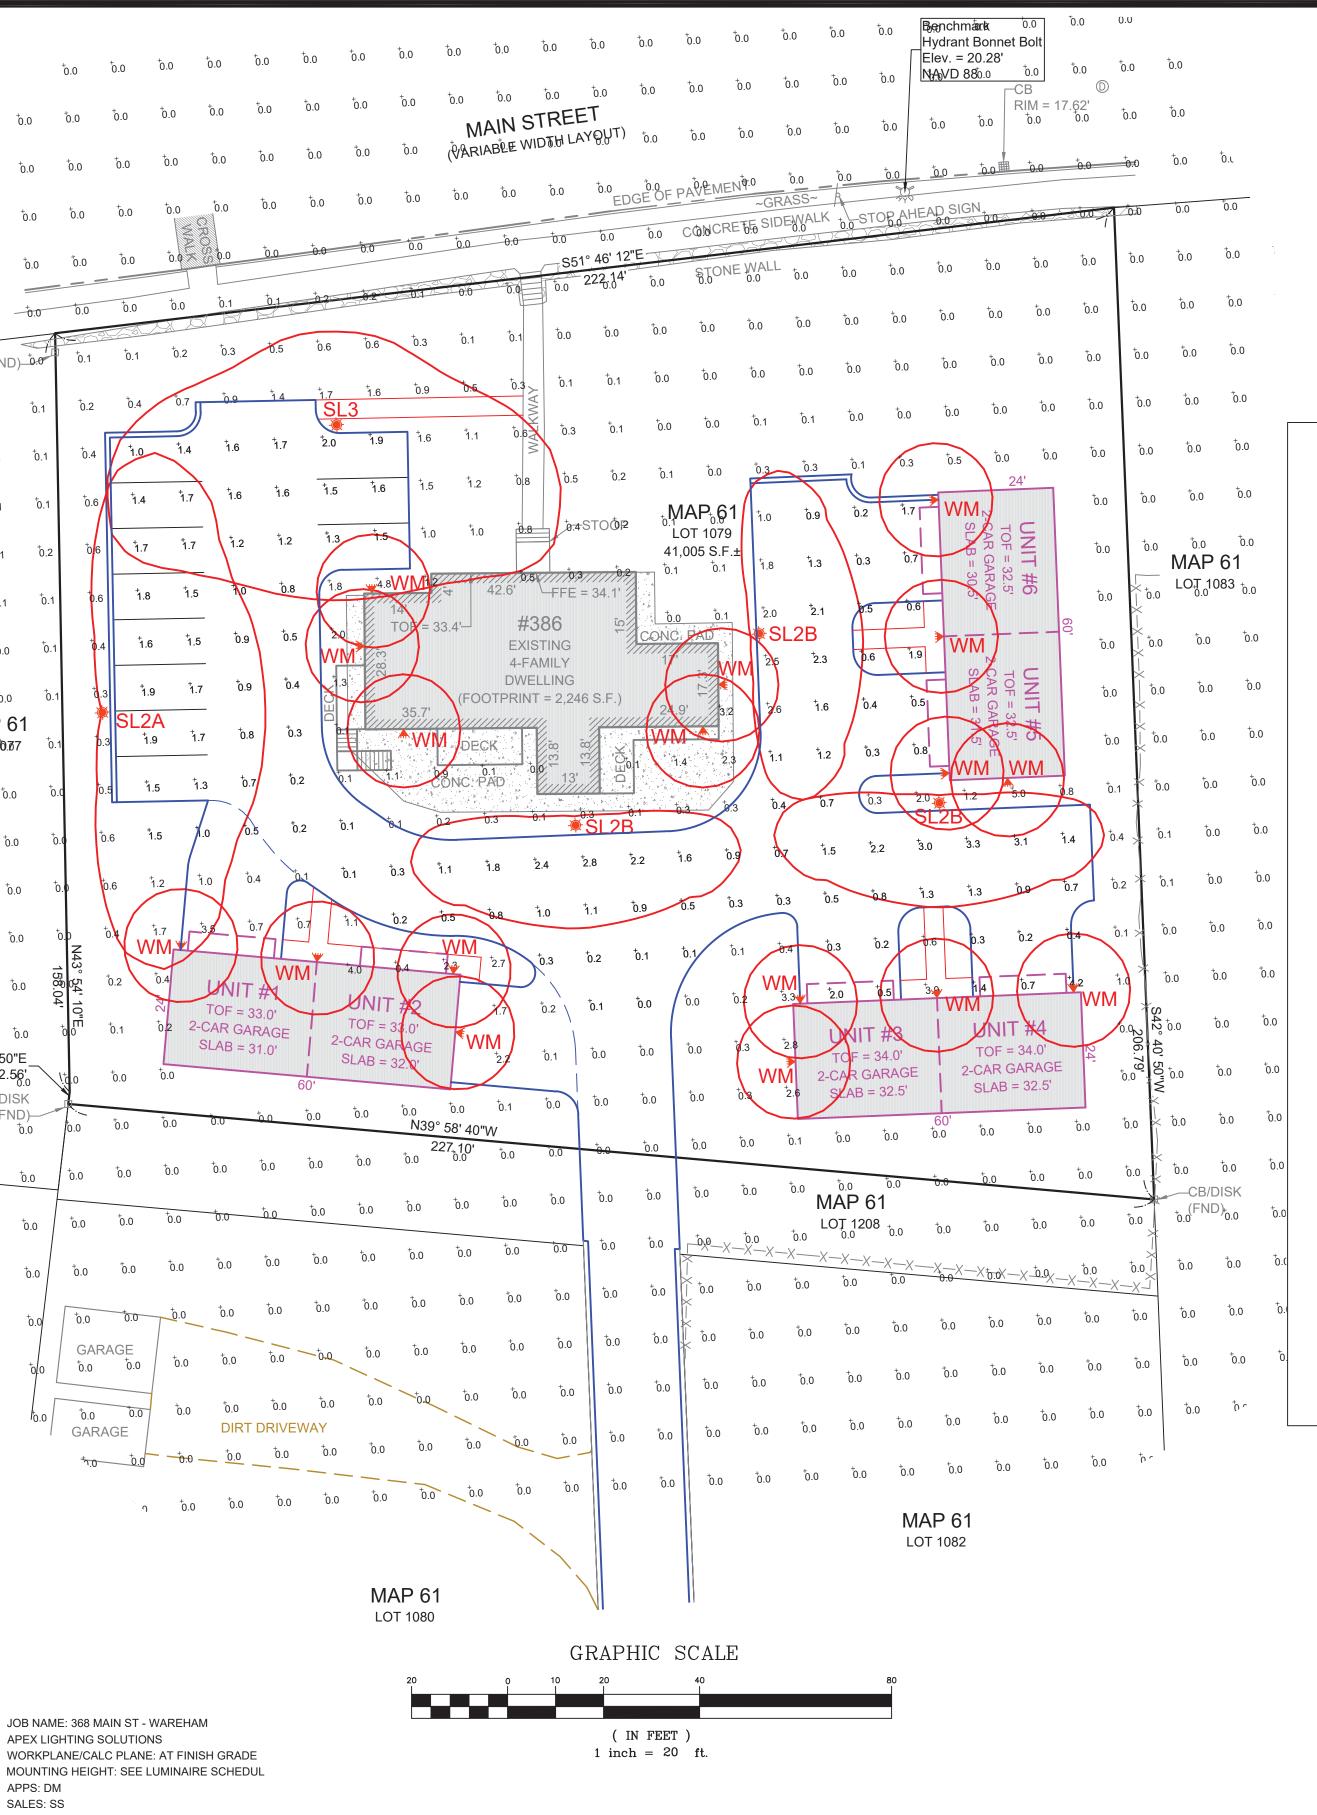0.0

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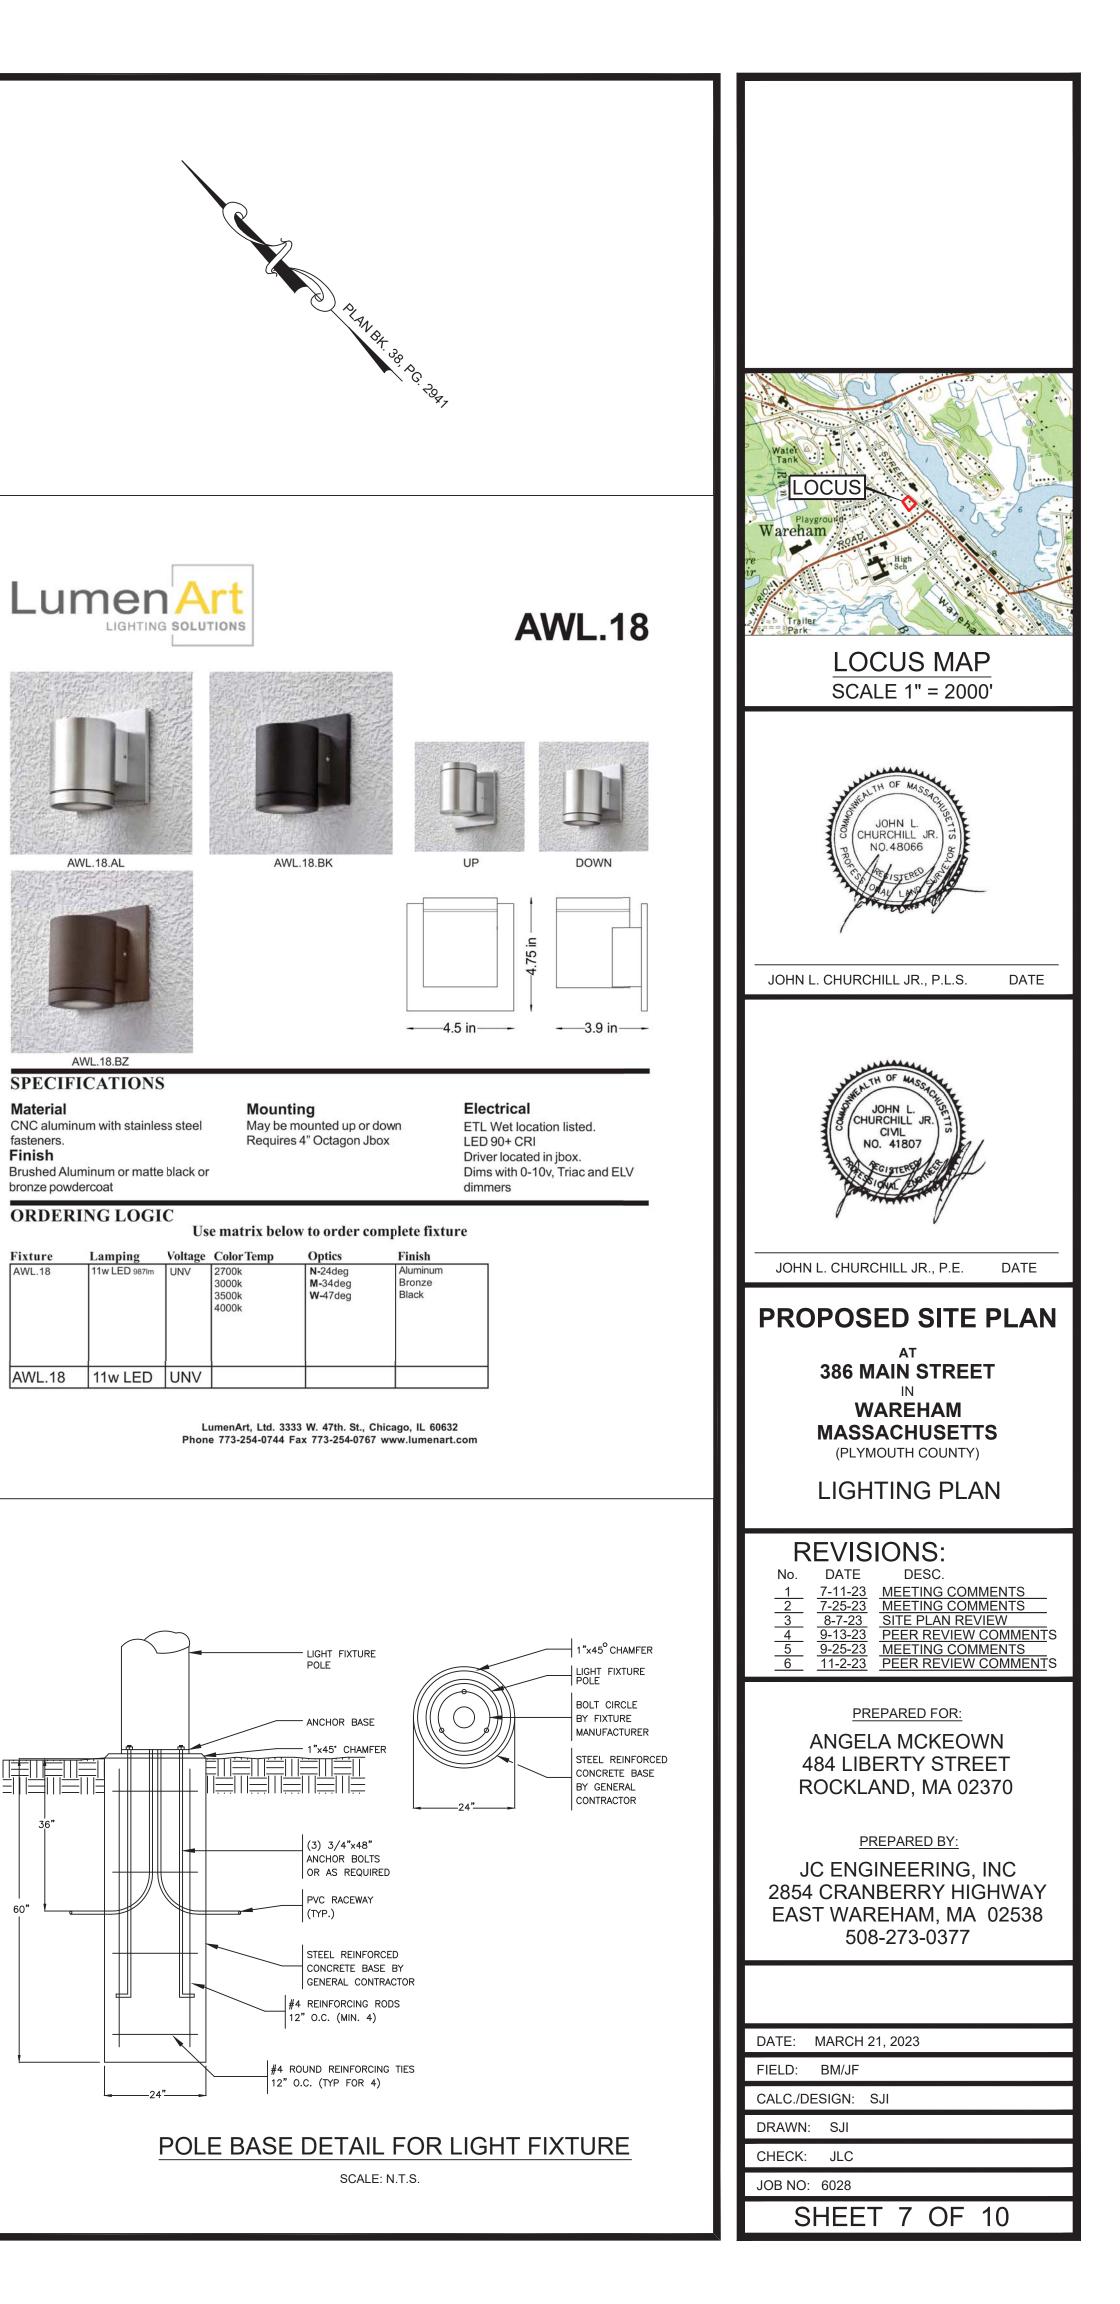
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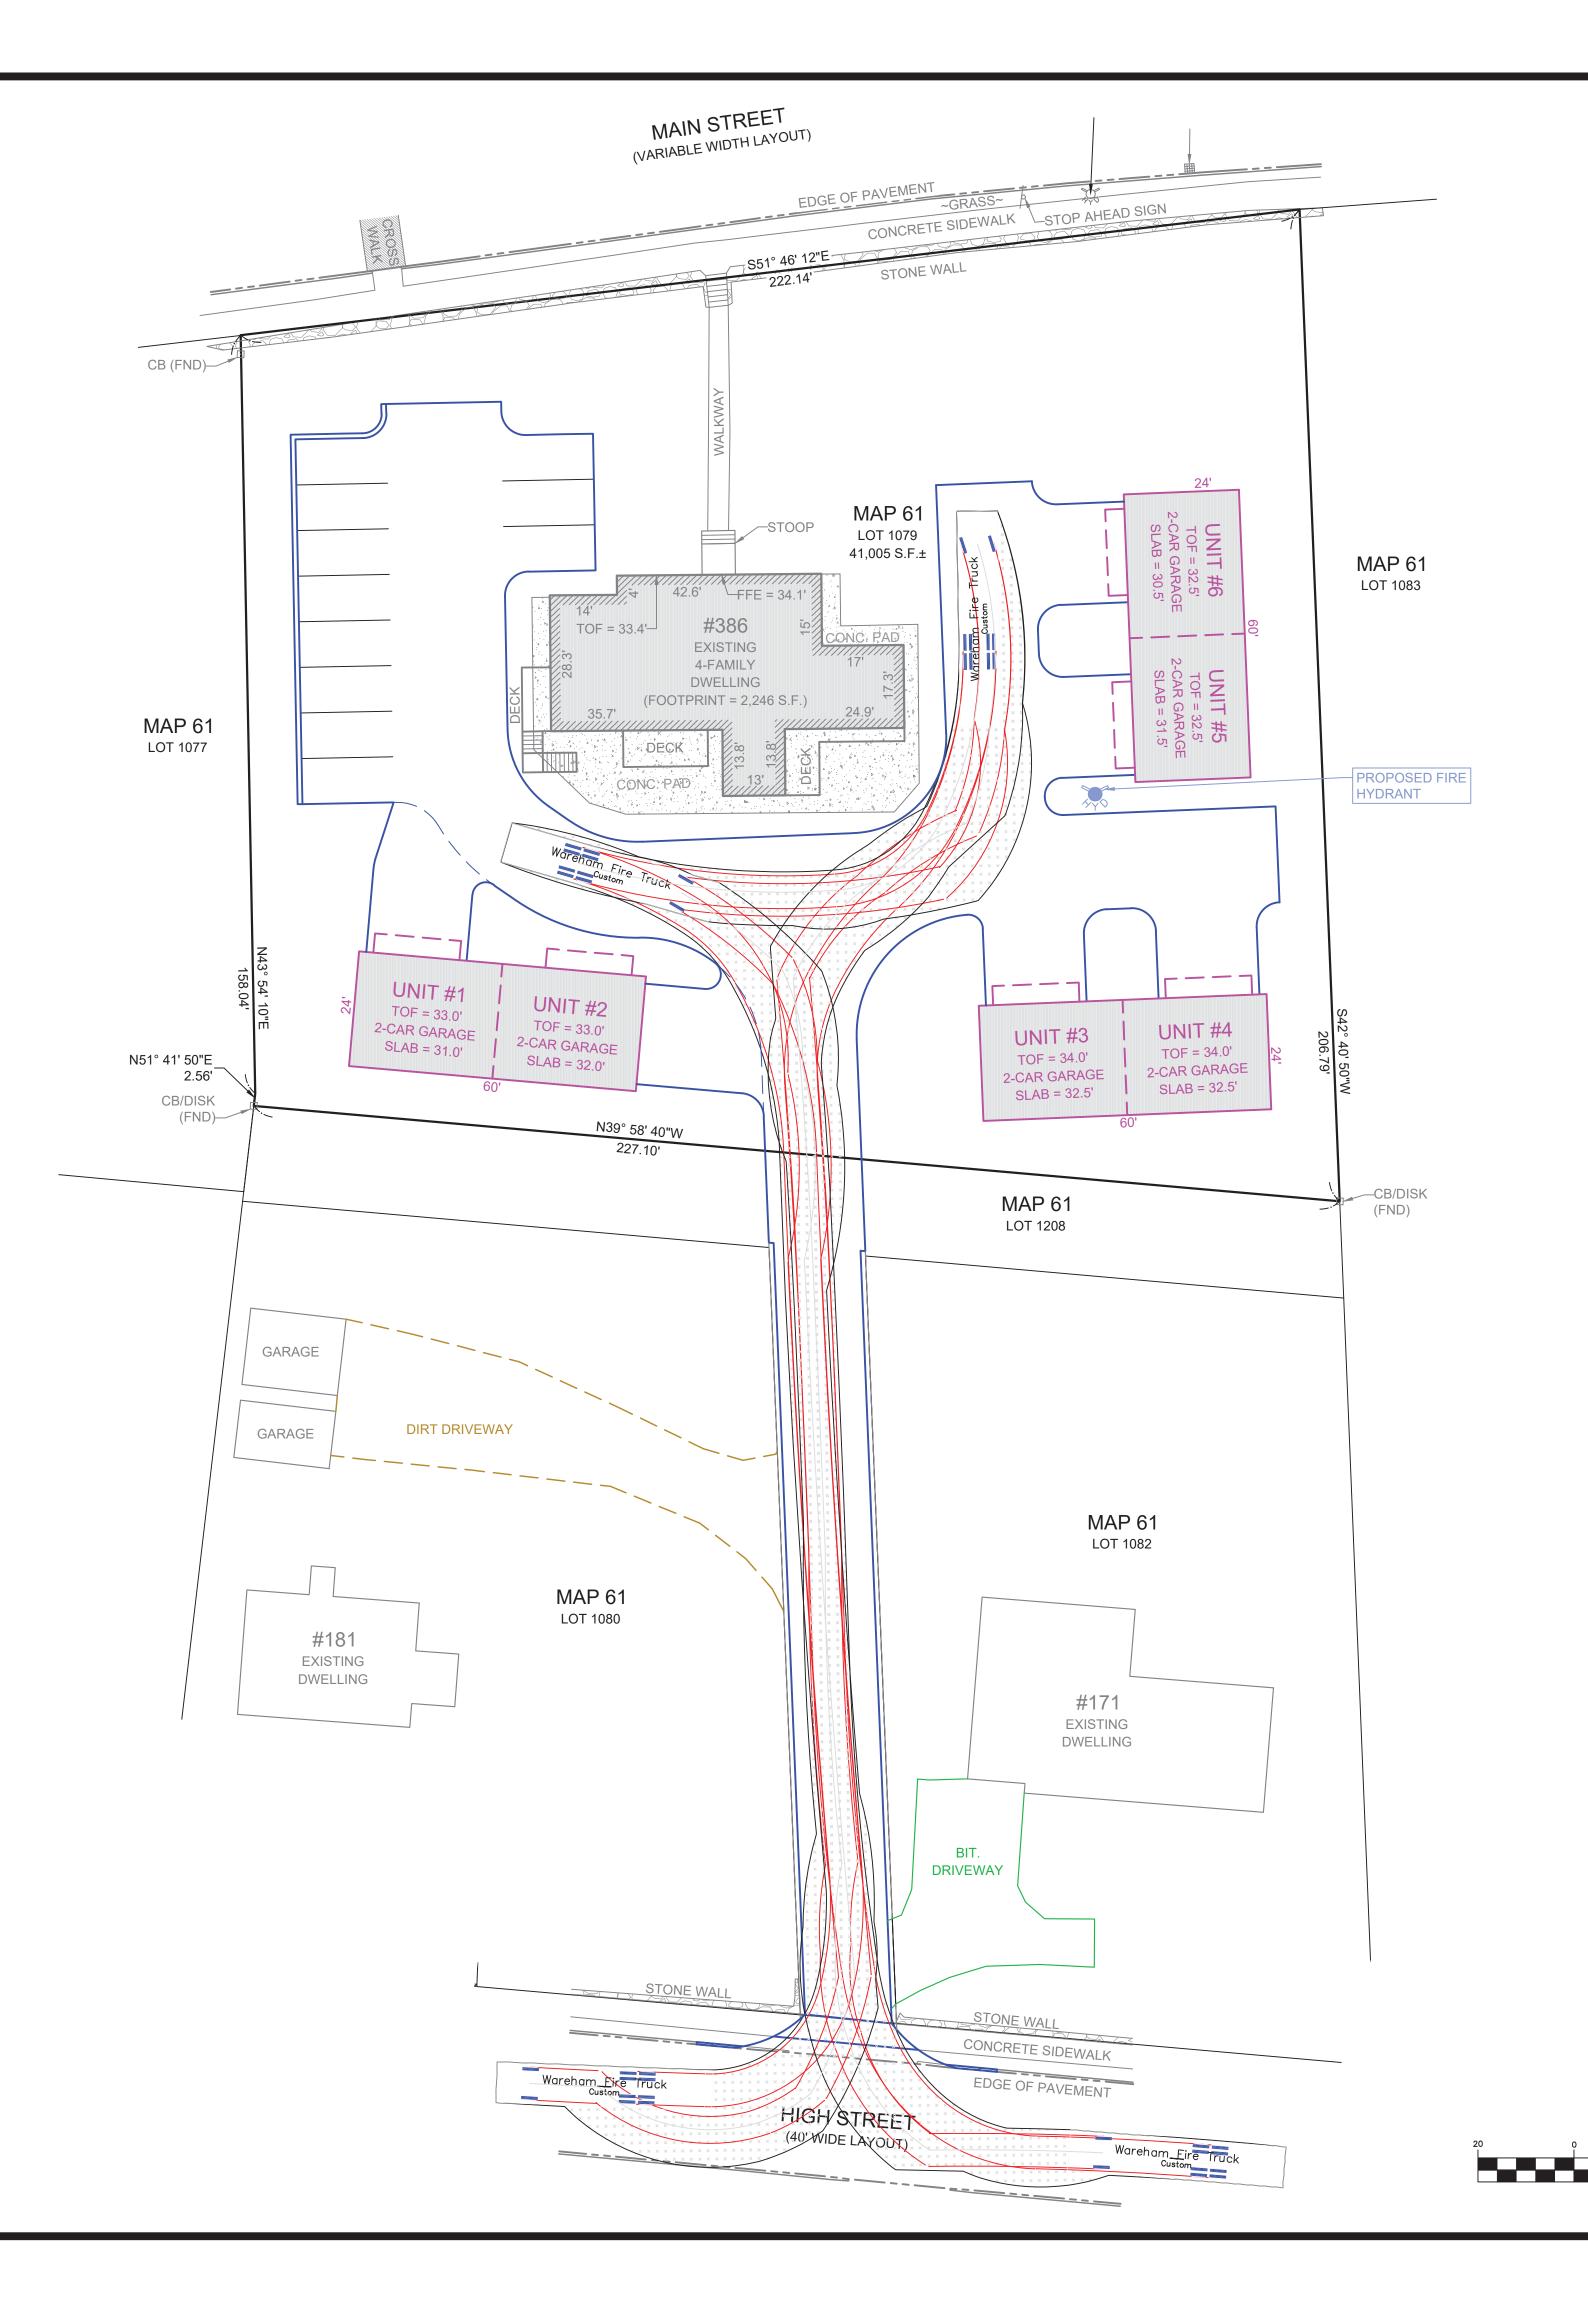
PHOTOMETRIC PLAN PREPARED BY APEX LIGHTING SOLUTIONS.




LEGEND

TRUCK ENVELOPE OVERHANG PATH

TIRE PATH ------_____




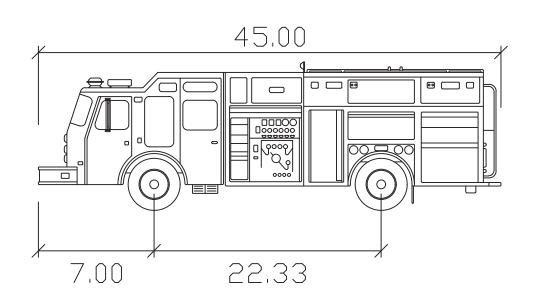

Wareham Fire Truck	feet
Width Track Lock to Lock Time Steering Angle	: 8,50 : 6,83 : 6,0 : 40,0

Punner 38 PC - 39	AF7
	LOCUS MAP BCALE 1" = 2000'
	JOHN L. CHURCHILL JR., P.L.S. DATE
	JOHN L. CHURCHILL JR., P.E. DATE PROPOSED SITE PLAN AT 386 MAIN STREET IN WAREHAM MASSACHUSETTS (PLYMOUTH COUNTY) EMERGENCY ACCESS PLAN REVISIONS: NO. DATE DESC.
	1 7-11-23 MEETING COMMENTS 2 7-25-23 MEETING COMMENTS 3 8-7-23 SITE PLAN REVIEW 4 9-13-23 PEER REVIEW COMMENTS 5 9-25-23 MEETING COMMENTS 6 11-2-23 PEER REVIEW COMMENTS PREPARED FOR: NGGELA MCKEOWN 484 LIBERTY STREET ROCKLAND, MA 02370 PREPARED BY: JC ENGINEERING, INC
GRAPHIC SCALE	2854 CRANBERRY HIGHWAY EAST WAREHAM, MA 02538 508-273-0377 DATE: MARCH 21, 2023 FIELD: BM/JF CALC./DESIGN: SJI DRAWN: SJI CHECK: JLC
(IN FEET)	
1 inch = 20 ft.	SHEET 8 OF 10



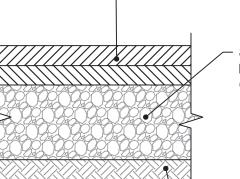


PAVEMENT NOTES:


1. SUBGRADE MATERIAL SHALL CONSISTS OF INERT MATERIAL THAT IS HARD, DURABLE STONE AND/OR COARSE SAND, FREE FROM LOAM AND CLAY TO A DEPTH NOT LESS THAN 4-FT BELOW FINISHED GRADE ELEVATION. ALL UNSUITABLE MATERIAL SHALL BE EXCAVATED AND REMOVED PRIOR TO SUBGRADE INSTALLATION.

2. SUBGRADE SHALL BE PLACED IN MAXIMUM 8" LIFTS (COMPACTED TO 95%)

3. REFER TO SITE PLAN FOR EXTENTS OF BIT. PAVEMENT. 4. THE INSTALLED BINDER COARSE SHALL BE SWEPT CLEAN PRIOR TO THE INSTALLATION OF THE WEARING COARSE BY A MECHANICAL SWEEPER. TACK COAT SHALL BE APPLIED PER THE SPECIFICATIONS.



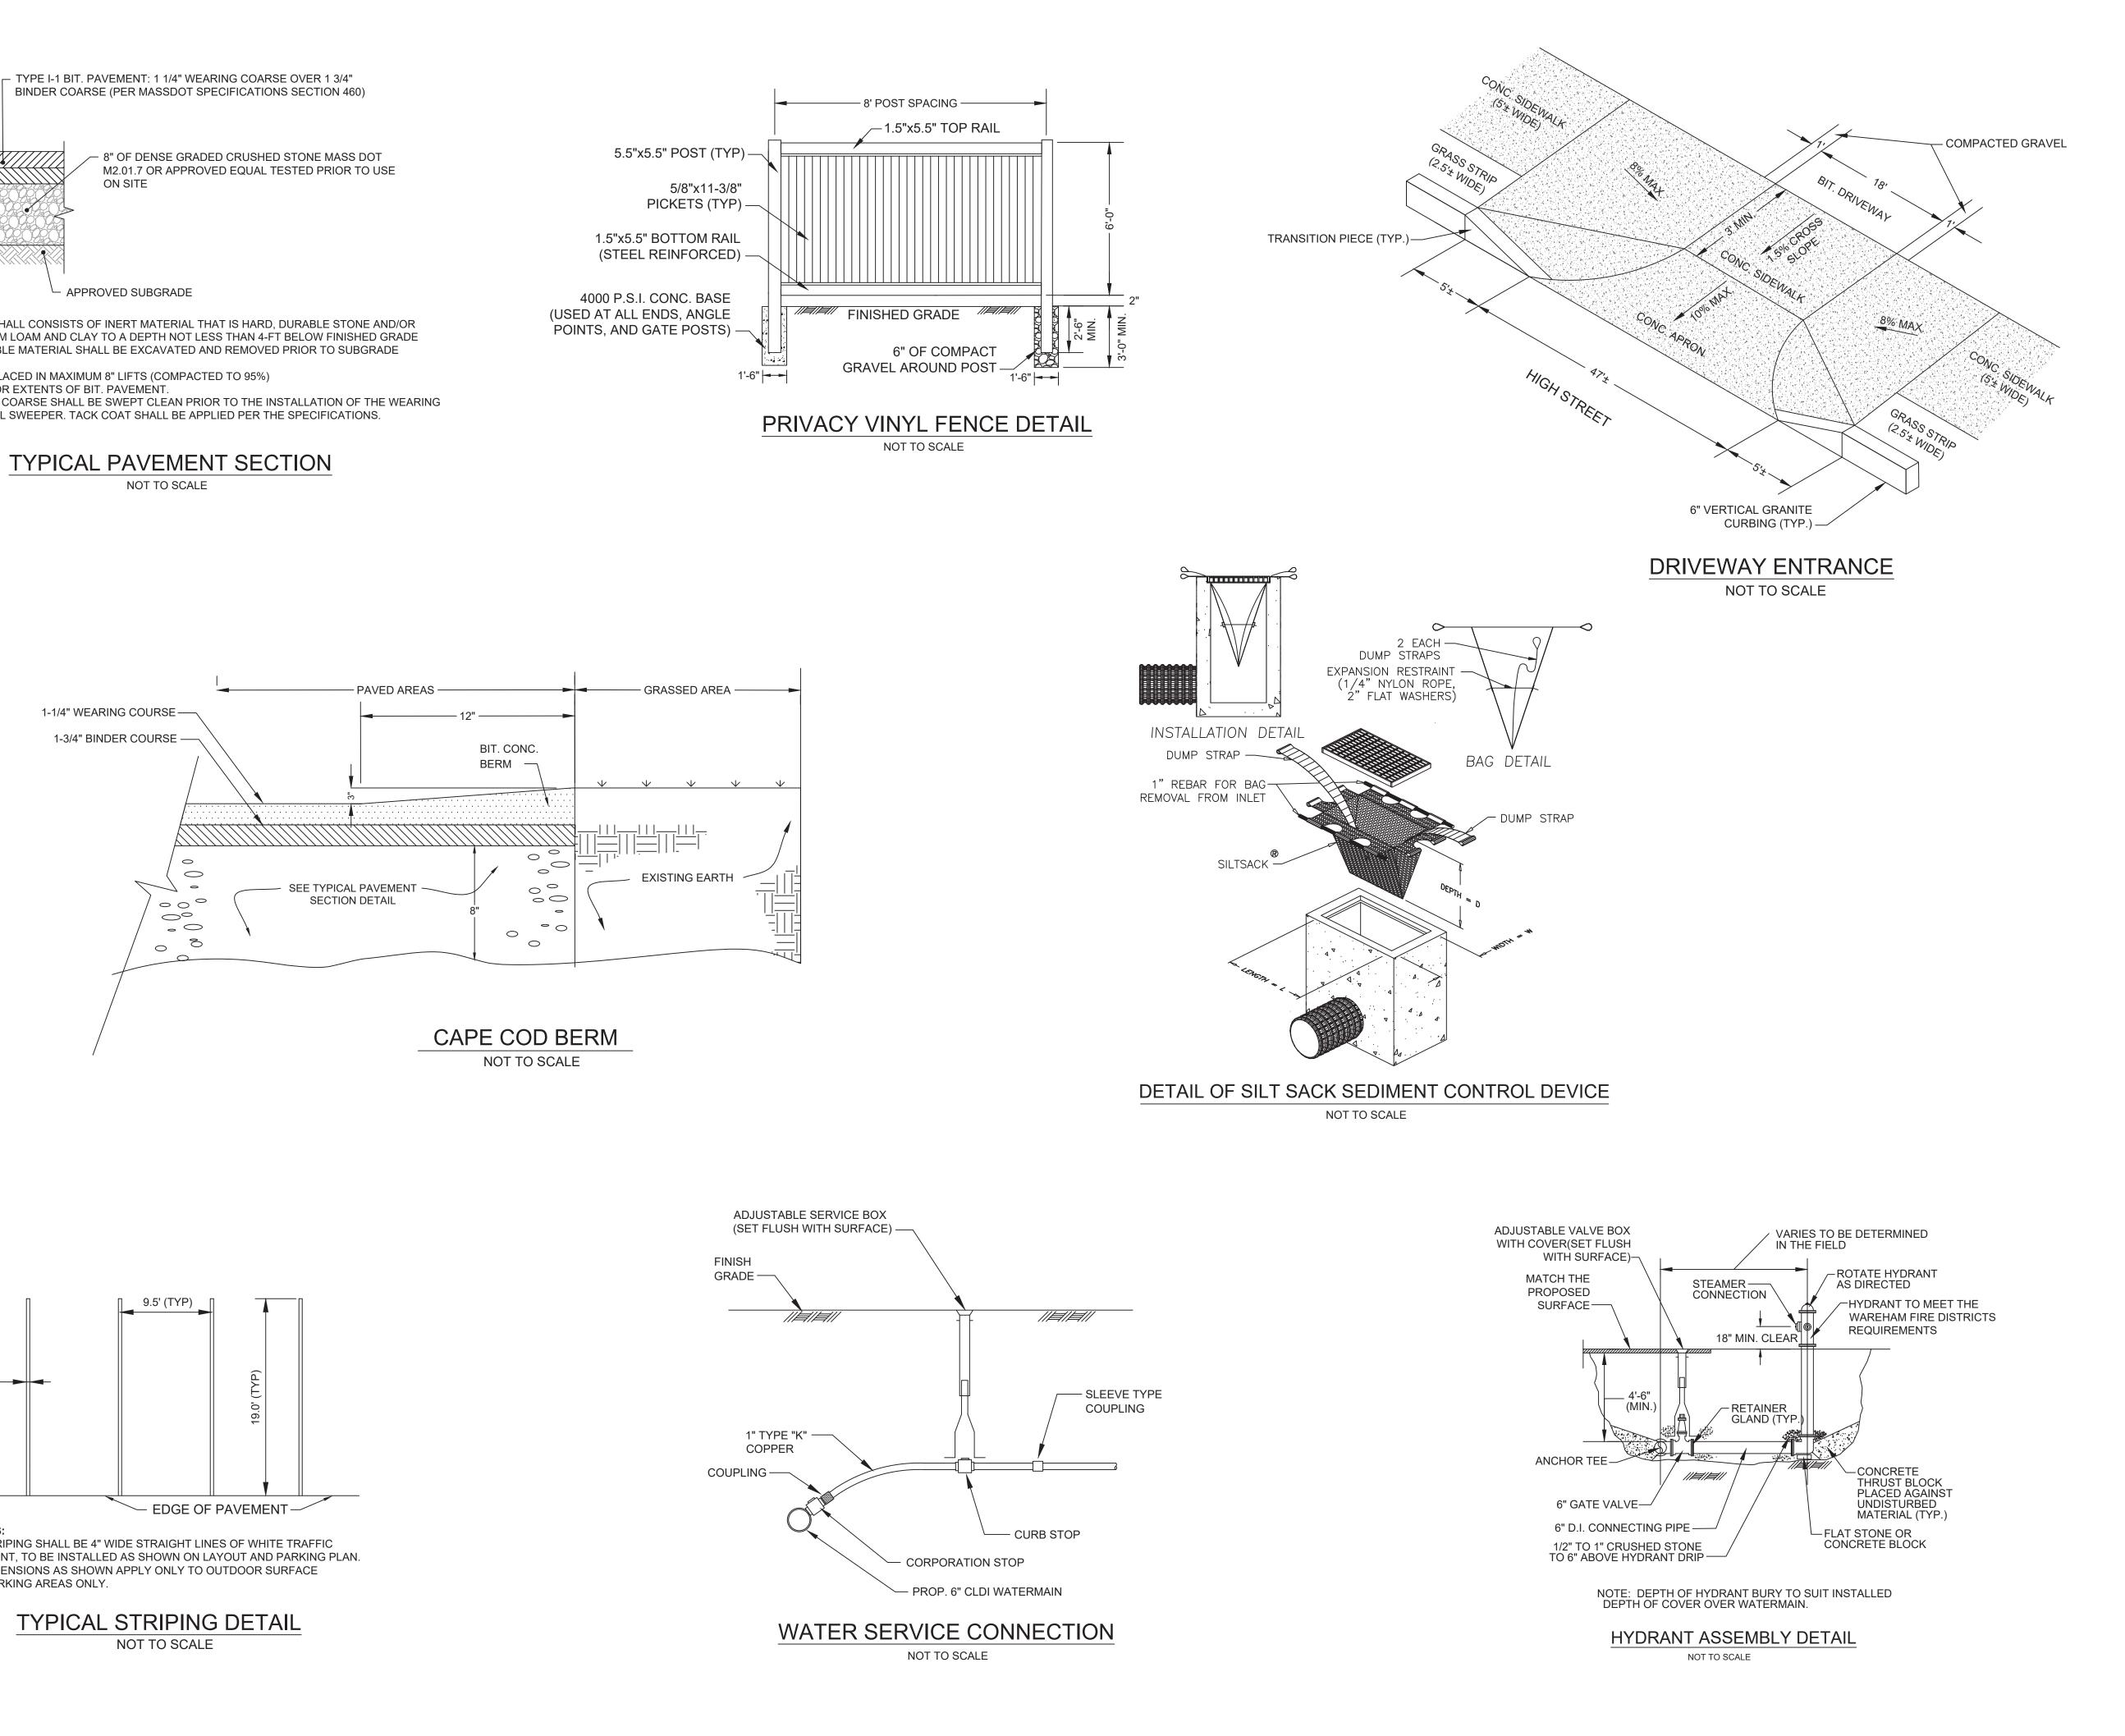


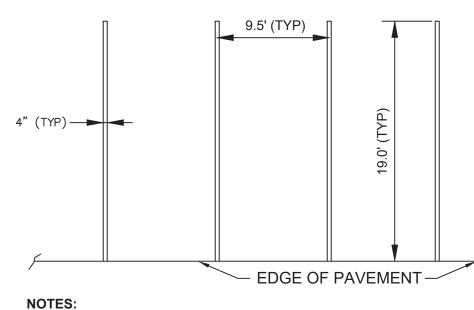

(1) STRIPING SHALL BE 4" WIDE STRAIGHT LINES OF WHITE TRAFFIC PAINT, TO BE INSTALLED AS SHOWN ON LAYOUT AND PARKING PLAN. (2) DIMENSIONS AS SHOWN APPLY ONLY TO OUTDOOR SURFACE PARKING AREAS ONLY.



Water Tank LOCUS Playground
Wareham re ir OC
LOCUS MAP SCALE 1" = 2000'
JOHN L. CHURCHILL JR., P.L.S. DATE
JOHN L. JOHN L. CHURCHILL JR. TS
NO. 41807
JOHN L. CHURCHILL JR., P.E. DATE
PROPOSED SITE PLAN
AT 386 MAIN STREET
MASSACHUSETTS (PLYMOUTH COUNTY)
DETAIL
REVISIONS:No.DATEDESC.16-28-23MEETING COMMENTS27-25-23MEETING COMMENTS
38-7-23SITE PLAN REVIEW49-13-23PEER REVIEW COMMENTS59-25-23MEETING COMMENTS611-2-23PEER REVIEW COMMENTS
PREPARED FOR: ANGELA MCKEOWN
484 LIBERTY STREET ROCKLAND, MA 02370
JC ENGINEERING, INC 2854 CRANBERRY HIGHWAY EAST WAREHAM, MA 02538 508-273-0377
DATE: MARCH 21, 2023
FIELD: BM/JF CALC./DESIGN: SJI
DRAWN: SJI
CHECK: JLC JOB NO: 6028
SHEET 9 OF 10

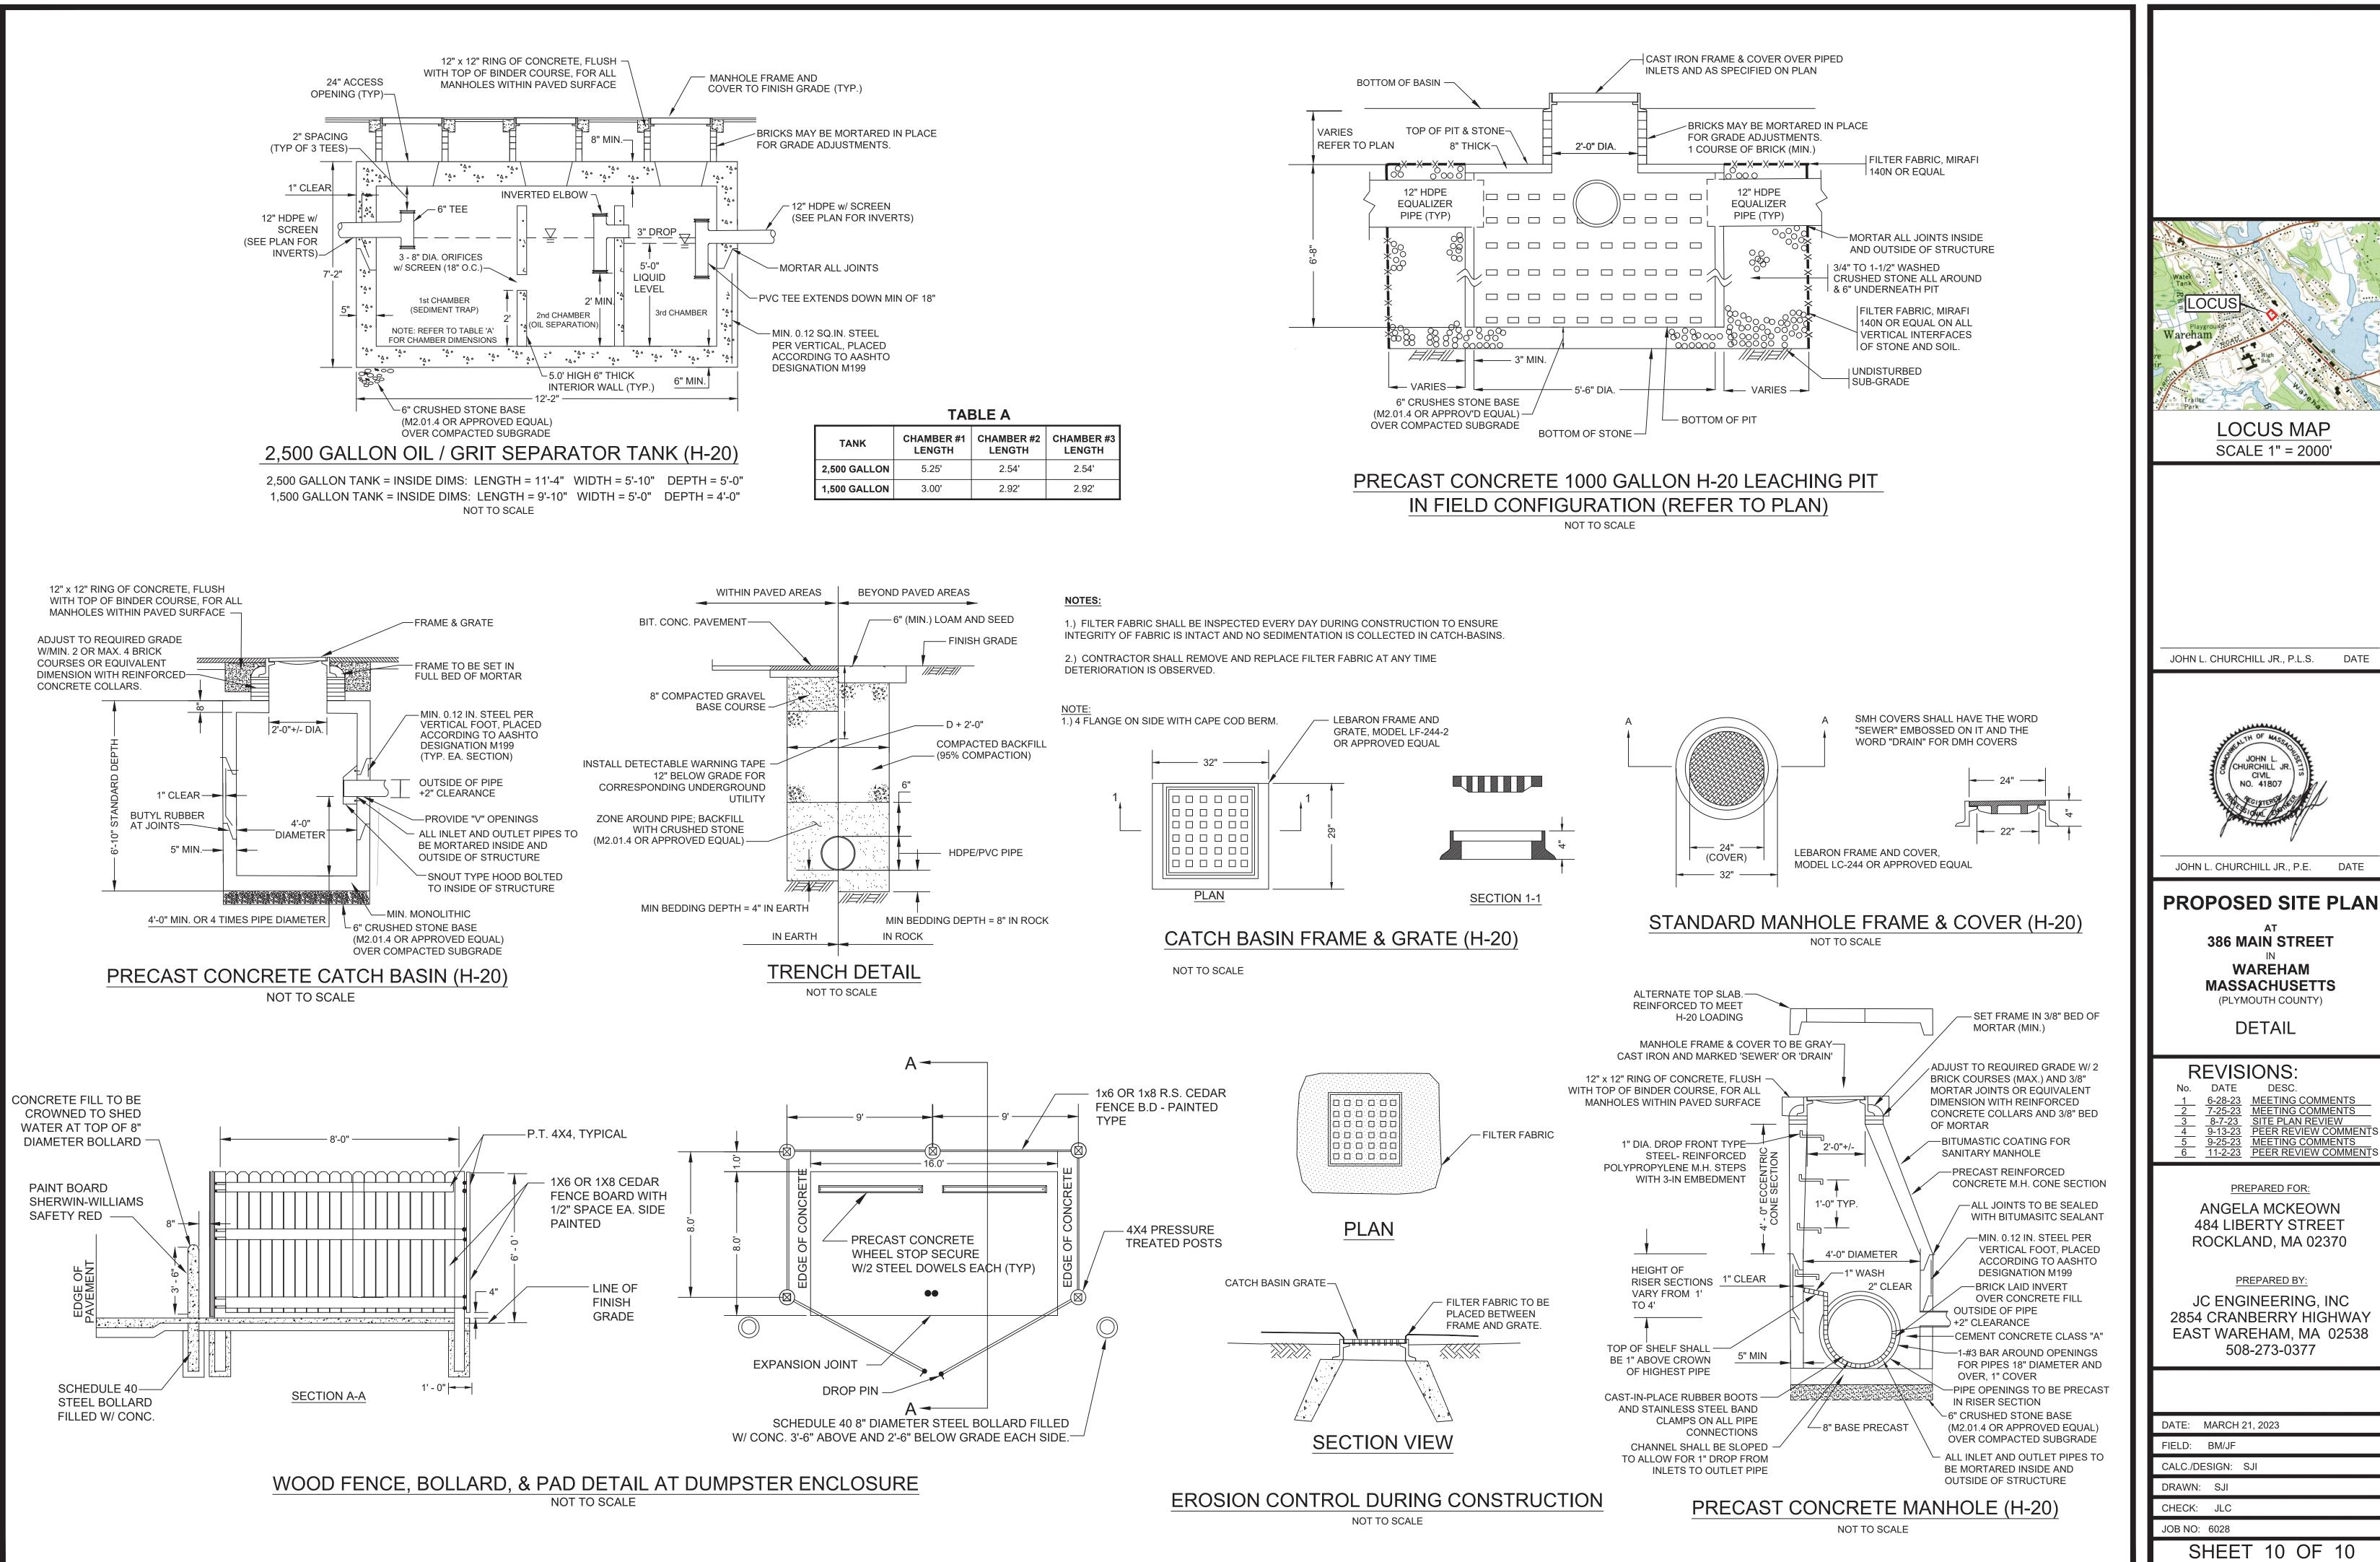

TANK	CHAMBER #1 LENGTH	CHAMBER #2 LENGTH	CHAMBER #3 LENGTH
2,500 GALLON	5.25'	2.54'	2.54'
1,500 GALLON	3.00'	2.92'	2.92'

