С D **EVERSOURCE WAREHAM VEHICLE STORAGE** DOTY STREET, WAREHAM, MA 02576



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PROJECT LOCATION NOT TO SCALE

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C101 Click Hall C201 Grading Plan C202 Basin Cross Sections C250 Erosion & Sediment Control Plan C401 Landscape Plan C402 Landscape Plan Details	LOT			F		TURE + ENGINEERING et, Suite 320 Chicago, Illinois 60654 w.shive-hattery.com ana Nebraska
Sheet Number Sheet Title C000 Cover Sheet C001 Civil General Notes & Legends C002 Civil General Notes & Legends C003 Boundary Survey by SGC Engineering, LLC C004 Existing Conditions by SGC Engineering, LLC C001 Existing Conditions & Demolition C101 Site Plan C202 Basin Cross Sections C250 Erosion & Sediment Control Plan C401 Landscape Plan C402 Landscape Plan C403 Londor C104 Landscape Plan C405 Landscape Plan C406 Landscape Plan C407 Landscape Plan C408 Landscape Plan C509 Erostor C1000 Landscape Plan C1000 Landscape Plan C1000 Landscape Plan C1000 Landscape Plan	Sh	eet List Table			1	<u> </u>
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an authoritative property location.	AREA OF MINIMAL FLOOD H	PROJECT LOCATION HZARD ham	SEE FIS REPORT FOR DETAILED SPECIAL FLOOD HAZARD AREAS OTHER AREAS OF FLOOD HAZARD NO SCRI OTHER AREAS GENERAL STRUCTURES IIIII E C THER MAP PANELS The P	 Without Base Flood Elevation (BFE) Zone A, V, A99 With BFE or Depth Zone AE, AO, AH, VE, AR Regulatory Floodway O.2% Annual Chance Flood Hazard, Areas of 1% annual chance flood with average depth less than one square mile Zone X Future Conditions 1% Annual Chance Flood Hazard Zone X Area with Reduced Flood Risk due to Levee. See Notes. Zone X Area with Flood Risk due to Levee Zone D EEN Area of Minimal Flood Hazard Zone X Effective LOMRs Area of Undetermined Flood Hazard Zone Z Effective LOMRs Area of Undetermined Flood Hazard Zone D Channel, Culvert, or Storm Sewer Levee, Dike, or Floodwall Cosstal Transect Base Flood Elevation Line (BFE) Limit of Study Jurisdiction Boundary Coastal Transect Baseline Profile Baseline Hydrographic Feature Digital Data Available No Digital Data Available No Digital Data Available Inmapped 	3	/ERSOURCE EHICLE STOR RSOURCE ENERGY

National Flood H



NORTH FLOOD INSURANCE RATE MAP NOT TO SCALE

1:6,000 Feet 2,000

Basemap: USGS National Map: Orthoimagery: Data refreshed October, 2020

DEVELOPER / OWNER: EVERSOURCE ENERGY, INC. 5 DOTY STREET, WAREHMA, MA 02576 DATE OF APPLICATION: 07/05/2022

PROPERTY ZONING DISTRICT: CS - COMMERCIAL STRIP

GENERAL ON-SITE SOIL TYPES (PER NRCS) - CARVER LOAMY COARSE SAND (GROUP A) AND UDORTHENTS - URBAN LAND COMPLEX (GROUP A)



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COVER

was exported on 6/14/2021 at 4:43 PM and does not reflect changes or amendments subsequent to this date and

time. The NFHL and effective information may change or

unmapped and unmodernized areas cannot be used for

This map image is void if the one or more of the following map elements do not appear: basemap imagery, flood zone labels, legend, scale bar, map creation date, community identifiers, FIRM panel number, and FIRM effective date. Map images for

become superseded by new data over time.

regulatory purposes.

ENEF	RAL NOTES	3.	EXCAVATED TOPSOIL SHALL BE STOCKPILED ON THE SITE IN AREAS D THAT THIS TOPSOIL CAN BE USED FOR FINAL GRADING. UNLESS OTH		
	CONTRACTOR TO CONFIRM THE HORIZONTAL AND VERTICAL LOCATION OF ALL EXISTING UTILITIES AND INFORM THE ENGINEER OF ANY POTENTIAL CONFLICTS WITH PROPOSED UTILITIES PRIOR TO CONSTRUCTION.	Л	RE-SPREAD AND SEEDING FOR ALL DISTURBED AREAS IS REQUIRED. THE GEOTECHNICAL INVESTIGATION REPORT FOR THE SITE AND ALL		
	CONTRACTOR SHALL BE RESPONSIBLE FOR SITE SAFETY AND ALL WAYS, MEANS AND METHODS OF CONSTRUCTION.	4.	THIS PROJECT. THE RECOMMENDATIONS AS STATED IN SAID REPORT	ARE HEREBY INCORPORATED INTO THESE CONSTRUCTION	
	CONTRACTOR SHALL COMPLY WITH ALL APPLICABLE FEDERAL, STATE AND LOCAL AGENCY CODES, STANDARDS AND SPECIFICATIONS.		NOTES BY REFERENCE AND SHALL BE FOLLOWED BY ALL CONTRACT SUPERVISED AND INSPECTED, PARTICULARLY DURING THE REMOVAL		
	CONTRACTOR SHALL OBTAIN ALL NECESSARY SITE PERMITS AND LICENSES FROM THE APPLICABLE GOVERNING AUTHORITIES.		EMBANKMENTS OR BUILDING PADS, BY A SOILS ENGINEER OR HIS RE		
	ALL CONSTRUCTION MATERIALS AND WORKMANSHIP SHALL BE IN ACCORDANCE WITH THE LATEST STATE AND LOCAL GOVERNMENT CONSTRUCTION STANDARDS AND SPECIFICATIONS.		WILL NOT BE PERMITTED UNTIL THE SOILS ENGINEER ISSUES A WRIT SATISFACTORILY PREPARED AND IS READY FOR CONSTRUCTION.	TEN STATEMENT THAT THE AREA IN QUESTION HAS BEEN	
	UNLESS OTHERWISE NOTED ON THE PLANS, CONTRACTOR SHALL NOTIFY THE LOCAL ENGINEERING OR PUBLIC WORKS DEPARTMENT AND/OR OTHER PROJECT GOVERNING AUTHORITY(S) A MINIMUM OF FORTY-EIGHT (48) HOURS PRIOR TO	5.	ALL TESTING, INSPECTION AND SUPERVISION OF SOIL QUALITY, UNSU SOILS RELATED OPERATIONS SHALL BE THE RESPONSIBILITY OF THE		
	COMMENCING CONSTRUCTION OPERATIONS AND TO SCHEDULE ANY REQUIRED SITE INSPECTIONS.		PERFORMED AT THE DIRECTION OF THE OWNER'S GEOTECHNICAL EN		
	CONTRACTOR SHALL SCHEDULE A UTILITY LOCATING SERVICE AND/OR NOTIFY ALL UTILITY COMPANIES (GAS, ELECTRIC, TELEPHONE, CABLE, ETC.) AND THE LOCAL MUNICIPALITY TO DETERMINE THE LOCATION OF UNDERGROUND UTILITIES PRIOR TO	6.	THE CONTRACTOR SHALL USE CARE IN GRADING NEAR TREES, SHRU SO AS NOT TO CAUSE INJURY TO ROOTS OR TRUNKS.	BS, AND BUSHES WHICH ARE NOT NOTED TO BE REMOVED	
	THE COMMENCEMENT OF CONSTRUCTION IN ORDER TO AVOID POTENTIAL CONFLICTS. IT IS ULTIMATELY THE RESPONSIBILITY	7.	THE CONTRACTOR SHALL USE CARE IN GRADING OR EXCAVATING NE		
	OF THE CONTRACTOR TO LOCATE ALL EXISTING UTILITIES WHETHER INDICATED ON THE PLANS OR NOT AND TO HAVE THESE UTILITIES STAKED PRIOR TO CONSTRUCTION. ANY NECESSARY RELOCATIONS OR REMOVALS OF EXISTING UTILITY LINES SHALL		INDICATED TO BE REMOVED. ANY DAMAGE DONE TO THESE EXISTING REPAIRED AT HIS OWN EXPENSE.	TIEMS BY THE CONTRACTOR'S OPERATIONS SHALL BE	
	BE PERFORMED BY THE CONTRACTOR AT NO ADDITIONAL COST TO THE OWNER. CONTRACTOR SHALL BE RESPONSIBLE FOR THE PROTECTION OF ALL PRIVATE AND PUBLIC UTILITIES EVEN THOUGH THEY MAY	8.	REMOVED PAVEMENTS, SIDEWALKS, CURBS, TREES AND STUMPS SHA DETERMINED BY THE CONTRACTOR.	ALL BE DISPOSED OF LEGALLY OFFSITE AT LOCATIONS	
	NOT BE SHOWN ON THE PLANS. ANY UTILITY THAT IS DAMAGED DURING CONSTRUCTION SHALL BE REPAIRED OR REPLACED BY	9.	ON AND OFFSITE PAVING AND CURBS TO REMAIN SHALL BE PROTECT		
	THE CONTRACTOR AT HIS EXPENSE AND TO THE SATISFACTION OF THE UTILITY OWNER. ALL EASEMENTS FOR EXISTING UTILITIES, BOTH PUBLIC AND PRIVATE, AND UTILITIES WITHIN PUBLIC RIGHTS-OF-WAY ARE	10.	PROMPTLY TO MEET STATE AND LOCAL STANDARD SPECIFICATIONS I PROPOSED ELEVATIONS INDICATE FINISHED GRADE CONDITIONS. FO		
	SHOWN ON THE PLANS PREPARED BY THE SURVEYOR ACCORDING TO INFORMATION AVAILABLE FROM PUBLIC RECORDS OR VISIBLE FIELD MARKINGS. THE CONTRACTOR SHALL BE ULTIMATELY RESPONSIBLE FOR DETERMINING THE EXACT LOCATION IN	11	THICKNESS OF THE PROPOSED PAVEMENT SECTION (ROADS, WALKS CONTRACTOR SHALL PROVIDE SMOOTH VERTICAL CURVES THROUGH		
	THE FIELD OF THESE UTILITY LINES AND FOR THEIR PROTECTION FROM DAMAGE DUE TO CONSTRUCTION OPERATIONS. IF	11.	ELEVATIONS ON THE PLANS. CONTRACTOR SHALL PROVIDE UNIFORM		
	EXISTING UTILITY LINES OF ANY NATURE ARE ENCOUNTERED WHICH CONFLICT IN LOCATION WITH THE PROPOSED CONSTRUCTION, THE CONTRACTOR SHALL IMMEDIATELY NOTIFY THE ENGINEER SO THE CONFLICT MAY BE RESOLVED.	12.	ANY RIDGES AND/OR DEPRESSIONS. ALL PROPOSED GRADING, PAVEMENT, APRONS, CURBS, WALKS, ETC.	SHALL MATCH EXISTING GRADES FLUSH.	
•	ALL UTILITY CONNECTIONS TO EXISTING LINES SHALL BE CONSTRUCTED IN ACCORDANCE WITH THE RULES AND REGULATIONS	13.	ALL EXISTING AND PROPOSED TOP OF FRAME ELEVATIONS FOR STOP	RM, SANITARY, WATER AND OTHER UTILITY STRUCTURES	
	AND TO THE SATISFACTION OF THE APPLICABLE UTILITY OWNER(S). CONTRACTOR SHALL FIELD VERIFY ALL DIMENSIONS, COORDINATES AND ELEVATIONS PRIOR TO THE COMMENCEMENT OF	14.	SHALL BE ADJUSTED TO MEET FINISHED GRADE WITHIN THE PROJEC REQUIRED RIM ADJUSTMENTS SHALL BE MADE WITH PRECAST CONCI		
	CONSTRUCTION AND SHALL IMMEDIATELY NOTIFY THE ENGINEER OF ANY DISCREPANCIES SO THE CONFLICT MAY BE RESOLVED. ALL PROPERTY MARKERS AND SURVEY REFERENCE MARKERS SHALL BE CAREFULLY PRESERVED DURING CONSTRUCTION		EIGHT (8) INCHES IN OVERALL HEIGHT. A MAXIMUM OF TWO (2) ADJUS SHALL BE USED ON ALL JOINTS BETWEEN THE PRECAST ELEMENTS.	TING RINGS ARE ALLOWED. BUTYLROPE JOINT SEALANT	
•	UNTIL THEIR LOCATION HAS BEEN WITNESSED OR OTHERWISE TIED IN BY AN AUTHORIZED AGENT OR PROFESSIONALLY	15.	SITE GRADING AND CONSTRUCTION OF THE PROPOSED SITE IMPROV		
	LICENSED SURVEYOR. THE SAFE AND ORDERLY PASSAGE OF TRAFFIC AND PEDESTRIANS SHALL BE PROVIDED WHERE CONSTRUCTION OPERATIONS		ALL AREAS ADJACENT TO THESE IMPROVEMENTS SHALL BE GRADED GRADES FLUSH.	TO ALLOW POSITIVE DRAINAGE AND MATCH EXISTING	
	ABUT PUBLIC THROUGH-FARES AND ADJACENT PROPERTY. ALL AREAS DISTURBED BY THE GENERAL CONTRACTOR OR SUB-CONTRACTORS SHALL BE RETURNED TO THE ORIGINAL	16.	CONTRACTOR SHALL ENSURE POSITIVE SITE DRAINAGE AT THE END OPERATIONS. FAILURE TO PROVIDE ADEQUATE DRAINAGE WILL PREC		
-	CONDITION OR BETTER, EXCEPT WHERE PROPOSED CONSTRUCTION IS INDICATED ON THE PLANS.		COMPENSATION REQUESTED DUE TO DELAYS OR UNSUITABLE MATEI	RIALS CREATED AS A RESULT.	
•	PRIOR TO INITIAL ACCEPTANCE BY THE OWNER(S) AND/OR GOVERNING AUTHORITY, ALL WORK SHALL BE INSPECTED AND APPROVED BY THE OWNER AND MUNICIPALITY ENGINEER OR HIS REPRESENTATIVE(S). THE CONTRACTOR SHALL GUARANTEE	17. 18.	DRIVEWAYS SHALL BE CONSTRUCTED SO AS NOT TO IMPEDE THE SU TRAFFIC CONTROL DEVICES SHALL BE IN CONFORMANCE WITH THE A		
	HIS WORK FOR A PERIOD OF 12 (TWELVE) MONTHS FROM THE DATE OF SUBSTANTIAL COMPLETION AND SHALL BE HELD		STANDARDS AND SHALL BE INSTALLED AND PROVIDED WHENEVER C		
	RESPONSIBLE FOR ANY DEFECTS IN MATERIAL OR WORKMANSHIP OF THIS WORK DURING THAT PERIOD AND UNTIL FINAL ACCEPTANCE IS MADE.		APPLICABLE ORDINANCES OF THE MUNICIPALITY, COUNTY OR STATE REQUIREMENTS.	SHALL ALSO GOVERN THE TRAFFIC CONTROL	
•	CONTRACTOR SHALL BE RESPONSIBLE FOR PROVIDING SAFE AND ADEQUATE WORKING CONDITIONS THROUGHOUT THE DURATION OF CONSTRUCTION OF THE PROPOSED IMPROVEMENTS.	19.	ALL GRADING AND SITE PREPARATION WORK SHALL CONFORM WITH IN THE GEOTECHNICAL REPORT.	THE RECOMMENDATIONS AND SPECIFICATIONS CONTAINED	
	CONTRACTOR SHALL KEEP THE PUBLIC STREET PAVEMENTS CLEAN OF DIRT AND DEBRIS AND, WHEN NECESSARY, CLEAN	20.	CONTRACTOR SHALL CAREFULLY PRESERVE ALL SITE BENCHMARKS	AND REFERENCE POINTS DURING CONSTRUCTION	
	PAVEMENTS AT THE END OF EACH WORKING DAY. ALL CONSTRUCTION STAKING, SCHEDULING AND PAYMENT IS THE RESPONSIBILITY OF THE CONTRACTOR.	21.	OPERATIONS. CONTRACTOR IS SPECIFICALLY CAUTIONED THAT THE LOCATION AND	D/OR ELEVATION OF EXISTING UTILITIES AS SHOWN ON	
•	AFTER COMPLETION OF THE PROPOSED IMPROVEMENTS AND WHEN REQUIRED BY THE GOVERNING AUTHORITY(S), CONTRACTOR SHALL PROVIDE THE OWNER AND ENGINEER WITH AS-BUILT AND/OR RECORD DRAWINGS, SIGNED AND SEALED BY		THESE PLANS IS BASED ON RECORDS OF THE VARIOUS UTILITY COMP THE FIELD. THE INFORMATION IS NOT TO BE RELIED ON AS BEING EXA		
	A PROFESSIONALLY LICENSED ENGINEER OR SURVEYOR AND SHALL INCLUDE AT A MINIMUM (WHERE APPLICABLE TO THE		LOCAL UTILITY LOCATION CENTER AT LEAST FORTY-EIGHT (48) HOUR	S BEFORE ANY EXCAVATION TO REQUEST EXACT FIELD	
19.1	SCOPE OF WORK) THE FOLLOWING ITEMS: . TOPOGRAPHY AND SPOT GRADE ELEVATIONS OF ALL PROPOSED PERMANENT SITE FEATURES INCLUDING ANY STORM		LOCATIONS OF THE UTILITIES. IT SHALL BE THE RESPONSIBILITY OF T WHICH CONFLICT WITH THE PROPOSED SITE IMPROVEMENTS SHOWN		
19.2	WATER FACILITIES OR MODIFICATIONS TO EXISTING STORM WATER FACILITIES. HORIZONTAL AND VERTICAL LOCATION AND ALIGNMENT OF ALL PROPOSED ROADWAYS, PARKING LOTS, UTILITIES,	22.	CONTRACTOR SHALL INSTALL APPROPRIATE TREE PROTECTION MEA OPERATIONS.	SURES PRIOR TO COMMENCEMENT OF SITE GRADING	
	BUILDINGS OR OTHER PERMANENT SITE FEATURES.	23.	CONTRACTOR SHALL UTILIZE CARE WHEN WORKING NEAR EXISTING		
19.3 19.4			NOT NOTED TO BE REMOVED SHALL BE REPAIRED AT THE CONTRACT AND/OR ENGINEER.	OR'S EXPENSE AND TO THE SATISFACTION OF THE OWNER	
	FOR CONSTRUCTION. ANY AND ALL DEVIATIONS FROM THESE APPROVED PLANS SHALL BE SHOWN BY MEANS OF STRIKING THROUGH THE PROPOSED INFORMATION AND CLEARLY INDICATING THE AS-BUILT LOCATIONS AND	24.	CONTRACTOR SHALL REPAIR AT HIS EXPENSE ANY DAMAGE TO EXIST RESULTING FROM CONSTRUCTION TRAFFIC AND/OR OPERATIONS. RE		
	ELEVATIONS ON THE APPLICABLE PLAN SHEET.		OWNER AND/OR ENGINEER.		
	CONTRACTOR SHALL BE RESPONSIBLE FOR VERIFICATION OF ALL SITE SETBACKS, EASEMENTS AND DIMENSIONS PRIOR TO COMMENCEMENT OF CONSTRUCTION.	25. 26.	CONTRACTOR SHALL RESTORE ALL DISTURBED AREAS OUTSIDE OF C MAXIMUM CROSS SLOPES AND LONGITUDINAL SLOPES FOR ALL CONC		
	ALL HANDICAP ACCESSIBLE SITE IMPROVEMENTS SHALL BE CONSTRUCTED IN ACCORDANCE WITH ALL FEDERAL, STATE AND LOCAL CODES AND REQUIREMENTS.	27.	SHALL NOT EXCEED 2% AND 5%, RESPECTIVELY. MAXIMUM SLOPES WITHIN THE HANDICAP ACCESSIBLE PARKING ARE/		
	IF DURING THE COURSE OF CONSTRUCTION THE CONTRACTOR FINDS ANY DISCREPANCIES OR CONFLICTS BETWEEN THE	27. 28.	MAXIMUM GRADE DIFFERENCE BETWEEN PAVEMENT SURFACES AND	ADJACENT CONCRETE SIDEWALKS FOR THE ACCESSIBLE	
	PROPOSED SITE IMPROVEMENTS INDICATED ON THE PLANS AND THE PHYSICAL CONDITIONS OF THE SITE, OR ANY ERRORS OR OMISSIONS WITHIN THE PLANS OR IN THE SITE LAYOUT AS PROVIDED BY THE ENGINEER, IT SHALL BE THE RESPONSIBILITY OF	29.	ROUTE TO THE BUILDING SHALL NOT EXCEED 1/4" VERTICAL OR 1/2" V ALL HANDICAP ACCESSIBLE EXTERIOR DOORWAY LOCATIONS REQUI		
	THE CONTRACTOR TO IMMEDIATELY NOTIFY THE ENGINEER. UNTIL AUTHORIZED TO PROCEED, ANY WORK PERFORMED BY THE CONTRACTOR AFTER SUCH A DISCOVERY WILL BE AT THE CONTRACTOR'S SOLE RISK AND EXPENSE.	२ 0	FEET IN LENGTH WITH A SLOPE NOT EXCEEDING 2% IN ANY DIRECTIO EXCAVATION SHORING SHALL BE DONE AS NECESSARY FOR THE PRO	N.	
	CONTRACTOR SHALL COORDINATE ALL SITE IMPROVEMENTS WITH ARCHITECTURAL PLANS. ARCHITECTURAL PLANS SHALL BE	50.	PERSONNEL. SHORING SHALL BE IN ACCORDANCE WITH ALL O.S.H.A	AND LOCAL REGULATIONS.	
	USED FOR BUILDING STAKEOUT. CONTRACTOR SHALL COORDINATE ALL LANDSCAPE IMPROVEMENTS, INCLUDING NEW PLANTINGS AND TURF AREA	31.	ALL STRUCTURE BENCH WALLS SHALL BE SHAPED AND FORMED FOR ALLOW THE SMOOTH CONVEYANCE OF FLOWS THROUGH THE MANHO		
	RESTORATION REQUIREMENTS, WITH LANDSCAPE PLANS. ALL DIMENSIONS SHOWN ARE MEASURED FROM FACE OF CURB TO FACE OF CURB OR EDGE OF PAVEMENT TO EDGE OF		DEFINED CHANNEL, TO A MINIMUM HEIGHT OF 80-PERCENT OF THE IN A "U" SHAPED CHANNEL, CONSTRUCTED AT A MINIMUM ½-INCH PER F	ISIDE DIAMETER OF THE INLET AND OUTLET PIPES TO FORM	
	ALL DIMENSIONS SHOWN ARE MEASURED FROM FACE OF CORB TO FACE OF CORB OR EDGE OF PAVEMENT TO EDGE OF PAVEMENT PACE PAVEMENT PACE PAVEMENT	32.	ALL STORM WATER INLETS AND CATCH BASIN CASTINGS SHALL HAVE		
	ALL CURB RADII ARE MEASURED AT THE FACE OF CURB UNLESS OTHERWISE NOTED. ALL NEW ASPHALT AND/OR CONCRETE PAVING SHALL MATCH EXISTING PAVEMENTS FLUSH.		SIMILARLY APPROVED MESSAGE, CAST IN RAISED OR RECESSED LET SYMBOL OF A FISH SHALL ALSO BE CAST WITH THE LETTERS.	TERS AT A MINIMUM OF 1" IN HEIGHT. IN ADDITION, A	
•	CONTRACTOR SHALL RESTORE ALL DISTURBED AREAS OUTSIDE OF CONSTRUCTION LIMITS TO ORIGINAL CONDITION OR BETTER. CONTRACTOR SHALL REPAIR AT HIS EXPENSE ANY DAMAGE TO EXISTING ASPHALT, CONCRETE, CURBS, SIDEWALKS, ETC.				
	RESULTING FROM CONSTRUCTION TRAFFIC AND/OR OPERATIONS. REPAIRS SHALL BE MADE TO THE SATISFACTION OF THE				
	OWNER AND/OR ENGINEER. ALL FIRE ACCESS LANES WITHIN THE PROJECT AREA SHALL REMAIN IN SERVICE, CLEAN OF DEBRIS, AND ACCESSIBLE FOR USE				
	BY EMERGENCY VEHICLES.				
•	ALL DETECTABLE WARNING PLATES SHALL BE PREFORMED PLASTIC INSERTS UNLESS OTHERWISE NOTED.				
TE G	RADING & PAVING NOTES				
	ALL SITE WORK, GRADING, AND PAVING OPERATIONS WITHIN THE LIMITS OF THE PROJECT SHALL BE PERFORMED IN ACCORDANCE WITH THE NOTES IN THE PLANS AND THE STANDARDS, SPECIFICATIONS, CODES AND ORDINANCES OF THE LOCAL				
	GOVERNING AUTHORITIES. IN CASE OF CONFLICT, THE MORE STRINGENT CODE SHALL TAKE PRECEDENCE.				
	EARTH EXCAVATION SHALL INCLUDE CLEARING, STRIPPING AND STOCKPILING TOPSOIL, REMOVING UNSUITABLE MATERIALS, CONSTRUCTION OF EMBANKMENTS, NON-STRUCTURAL FILLS, FINAL SHAPING AND TRIMMING TO THE LINES, GRADES AND CROSS				
	SECTIONS SHOWN ON THE PLANS. ALL UNSUITABLE OR EXCESS MATERIAL SHALL BE DISPOSED OF LEGALLY OFFSITE OR AS				
	DIRECTED BY THE PROJECT REPRESENTATIVE IN THE FIELD.				

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1	ACHIECTURE + ENGINE ACHIECTURE + ENGI
2	EVERSOURCE WAREHAM VEHICLE STORAGE LOT EVERSOURCE ENERGY DOTY STREET, WAREHAM, MA 02576
3	PRELIMINARY EVERSOUF - NOT FOR VEHICLE S - NOT FOR VEHICLE S - ONSTRUCTION EVERSOURCE ENERGY
4	CIVIL GENERAL DRAWN: EAW DITES & LEGENDS APPROVED: JMR NOTES & LEGENDS ISSUED FOR: DRAMITTAL DATE: 07/05/2022 DATE: 07/05/2022 PROJECT NO: 7211970 FIELD BOOK: LEIELD BOOK: CLIENT NO:
	C001

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1	 PAVEMENT GENERAL NOTES LIMIT OPERATIONS TO THE PUBLIC RIGHT-OF-WAYS AND EASEMENTS OR INDICATED PROJECT LIMITS. THE CONTRACTOR SHALL NOT UTILIZE PRIVATE PROPERTY UNLESS HE HAS SUBMITTED A COPY OF THE PROPERTY OWNER'S WRITTEN PERMISSION TO THE OWNER'S REPRESENTATIVE. ALL SLOPES IN PAVEMENT SHALL BE UNFORM TO AVOID PONDING. REMOVE AND REPLACE OR RESTORE ALL STREET SIGNS, PAVEMENT MARKINGS, SIDEWALK LAMPS, SIDEWALKS, STEPS, LANDSCAPE STRUCTURES, CURB AND GUTTER, STREETS, DRIVES, AND ALL OTHER SURFACE STRUCTURES REMOVED OR OTHERWISE DAMAGED DURING THE COURSE OF THE WORK. SIDEWALKS SHALL BE REMOVED AND REPLACED TO NEAREST JOINT BEYOND CONSTRUCTION AREA. COMPACT SUBGRADE BENEATH PAVEMENTS IN ACCORDANCE WITH GRADING NOTES. <u>SURFACE RESTORATION</u> ALL DISTURBED AREAS NOT PAVED OR HARD SURFACE ON THE SITE SHALL RECEIVE 6 INCHES OF TOPSOIL. SCARIFY AREAS TO RECEIVE TOPSOIL TO A DEPTH OF 3 INCHES. REMOVE ALL STONES, WOOD, AND OTHER DEBRIS LARGER THAN 2 INCHES FROM AREAS TO RECEIVE TOPSOIL. DO NOT COMPACT TOPSOIL. ALL DISTURBED AREAS SHALL BE SEEDED, FERTILIZED, AND MULCHED IN ACCORDANCE WITH THE PROVIDED LANDSCAPING PLAN, NOTES, AND DETAILS. REFER TO LANDSCAPE PLAN FOR PLANTING INSTRUCTIONS AND DETAILS. MAINTAIN ANY SEEDED AREAS UNTIL AND ADEQUATE STAND OF GRASS HAS BEEN ESTABLISHED. RESEED ANY AREAS AS NECESSARY DURING MAINTENANCE PERIOD. <u>EROSION CONTROL NOTES</u> USE ALL AVAILABLE MEANS TO MINIMIZE THE AMOUNT OF SOIL EROSION CAUSED BY THE WORK OF THE PROJECT. THIS
	 INCLUDES RESPONSIBILITY FOR MAINTENANCE OF ALL SOIL EROSION CONTROL DEVICES INDICATED. REPAIRS TO SOIL EROSION CONTROL DEVICES SHALL BE COMPLETED WITHIN 2 DAYS FROM NOTIFICATION. EROSION CONTROL DEVICES SHALL BE CHECKED ONCE PER WEEK AND AFTER EACH RAINFALL TO ENSURE WORKING ORDER. SILT FENCE SHALL BE LOCATED AS SHOWN ON THE PLANS. SEED ALL DISTURBED AREAS EXPOSED FOR MORE THAN 21 DAYS WITH A STABILIZING CROP.
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	SURVEY
PLAN MARK	DESCRIPTION
B M	BENCH MARK
	CONTROL POINT
•	IRON ROD - FOUND
0	IRON ROD - SET
	SECTION CORNER FOUND
	MONUMENT SET
×	X CUT FOUND
×	X CUT SET
	RIGHT OF WAY MARKER
۲	NAIL FOUND
0	NAIL SET
	STATION MARKER
•	SOIL BORING
(00)	RECORD BEARING/DISTANCE
00	MEASURED BEARING/DISTANCE
РОВ	POINT OF BEGINNING
POR	POINT OF REFERENCE

	LEGEND
	GENERAL SITE
PLAN MARK	DESCRIPTION
	EXISTING STRUCTURE
۲	GUARD POST/ BOLLARD
MB	MAILBOX
OPM	PARKING METER
\checkmark	FLAGPOLE
ولل	HANDICAPPED PARKING
()	SHRUB
\bigcirc	DECIDUOUS TREE
mary and	CONIFEROUS TREE
	SINGLE POLE SIGN
-0-0-	DOUBLE POLE SIGN
○ ——□	TRAFFIC SIGNAL WITH ARM
ů	TRAFFIC SIGNAL
Ť	UTILITY MARKER
X RR	RAILROAD CROSSING SIGNAL
\otimes	TRAFFIC MANHOLE
- X	WIRE FENCE
o	WOOD FENCE
o	CHAINLINK FENCE
	RAILROAD
	GUARD RAIL
~~~~~~	TREE LINE
- — -621— — -	MINOR CONTOUR
- — -620 - — -	MAJOR CONTOUR

-	— -621— — — MINOR CONTOUR				
_	— – 620 – — – MAJOR CONTOUR		LEGEND		
			G	ENERAL SITE DESIGN	
	LEGEND			ESCRIPTION	
	UTILITY LINES	SF SF	POT ELEVATION		
EXISTING LINE TYPE	DESCRIPTION	PROPOSED LINE TYPE	•		
OE	ELECTRIC - OVERHEAD	OE		OP OF CURB AND GUTTER ELEVATION	
E	ELECTRIC - UNDERGROUND			OPE ARROW	
	GAS MAIN			OW ARROW	
W	WATER MAIN	w		RAFFIC FLOW	
))))	SANITARY SEWER			LT FENCE	
	SANITARY FORCE MAIN			MITS	
>	STORM SEWER	>>		FT-TURN ARROW	
OT	TELEPHONE - OVERHEAD			GHT-TURN ARROW	
T	TELEPHONE - UNDERGROUND			IRU ARROW	
OC	CABLE LINE - OVERHEAD	0C		FT/ THRU ARROW	
	CABLE LINE - UNDERGROUND		RI	GHT/ THRU ARROW	
—FO	FIBER OPTICS	FO		FT/ RIGHT/ THRU ARROW	
	PROCESS/HEATING STEAM		_		

## UTILITY NOTE

С

THE LOCATIONS OF UTILITY MAINS, STRUCTURES, AND SERVICE CONNECTIONS PLOTTED ON THIS DRAWING ARE APPROXIMATE ONLY AND WERE OBTAINED FROM RECORDS MADE AVAILABLE TO SHIVE-HATTERY, INC. THERE MAY BE OTHER EXISTING UTILITY MAINS, STRUCTURES, AND SERVICE CONNECTIONS NOT KNOWN TO SHIVE-HATTERY, INC., AND NOT SHOWN ON THIS DRAWING.


D

## LEGEND

LEGEND								
UTILITIES								
PLAN MARK	DESCRIPTION							
•	FLOODLIGHT							
0¢	LIGHT POLE OVERHANG							
¢	LIGHT POST							
8	SIREN POLE							
Ø	UTILITY POLE							
$\longrightarrow$	GUY ANCHOR							
ØØ	UTILITY POLE W/ TRANSFORMER							
þ	FIRE HYDRANT							
	FLARED END SECTION							
[	UTILITY END CAP							
$\boxtimes$	VALVE							
OPIV	POST INDICATOR VALVE							
	CABLE TV PEDESTAL							
	CLEANOUT							
J	JUNCTION BOX							
F	FIBER OPTIC BOX							
MH	MANHOLE							
0	DRAINAGE MANHOLE							
Ē	ELECTRICAL MANHOLE							
S	SANITARY MANHOLE							
Ū	TELEPHONE MANHOLE							
 	TELEPHONE PEDESTAL							
	VAULT BOX MONITORING WELL							
Ŵ	WONTORING WELL							
W	WATER MANHOLE							
×	WATER IRRIGATION VALVE							
 W								
HH								
S	SIGNAL BOX							
G	GAS METER							
E								
A								
	INTAKE - RECTANGLE							
	INTAKE - SQUARE							
	RA-3 INTAKE							
	RA-5 INTAKE							
P F								
F F	FIRE DEPARTMENT VALVE							
R	GAS REGULATOR							
$\otimes$	ROOF DOWNSPOUT							


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	> o 4
1	<b>BARCHITECTURE+ENGINEERING</b> ARCHITECTURE+ENGINEERING 440 North Wells Street, Suite 320   Chicago, Illinois 60654 312.324.5500   www.shive-hattery.com lowa   Illinois   Indiana   Nebraska
	JEFF RATH, PE 61591 07/05/2022
2	ERSOURCE WAREHAM HICLE STORAGE LOT OURCE ENERGY STREET, WAREHAM, MA 02576
	EVERS VEHICI EVERSOURCE DOTY STREET,
3	PRELIMINARY - NOT FOR CONSTRUCTION
4	CIVIL GENERAL NOTES & LEGENDS NOTES & LEGENDS ISSUED FOR: PERMIT RESUBMITTAL DATE: 07/05/2022 PROJECT NO: 7211970 FIELD BOOK: CLIENT NO:
	C002

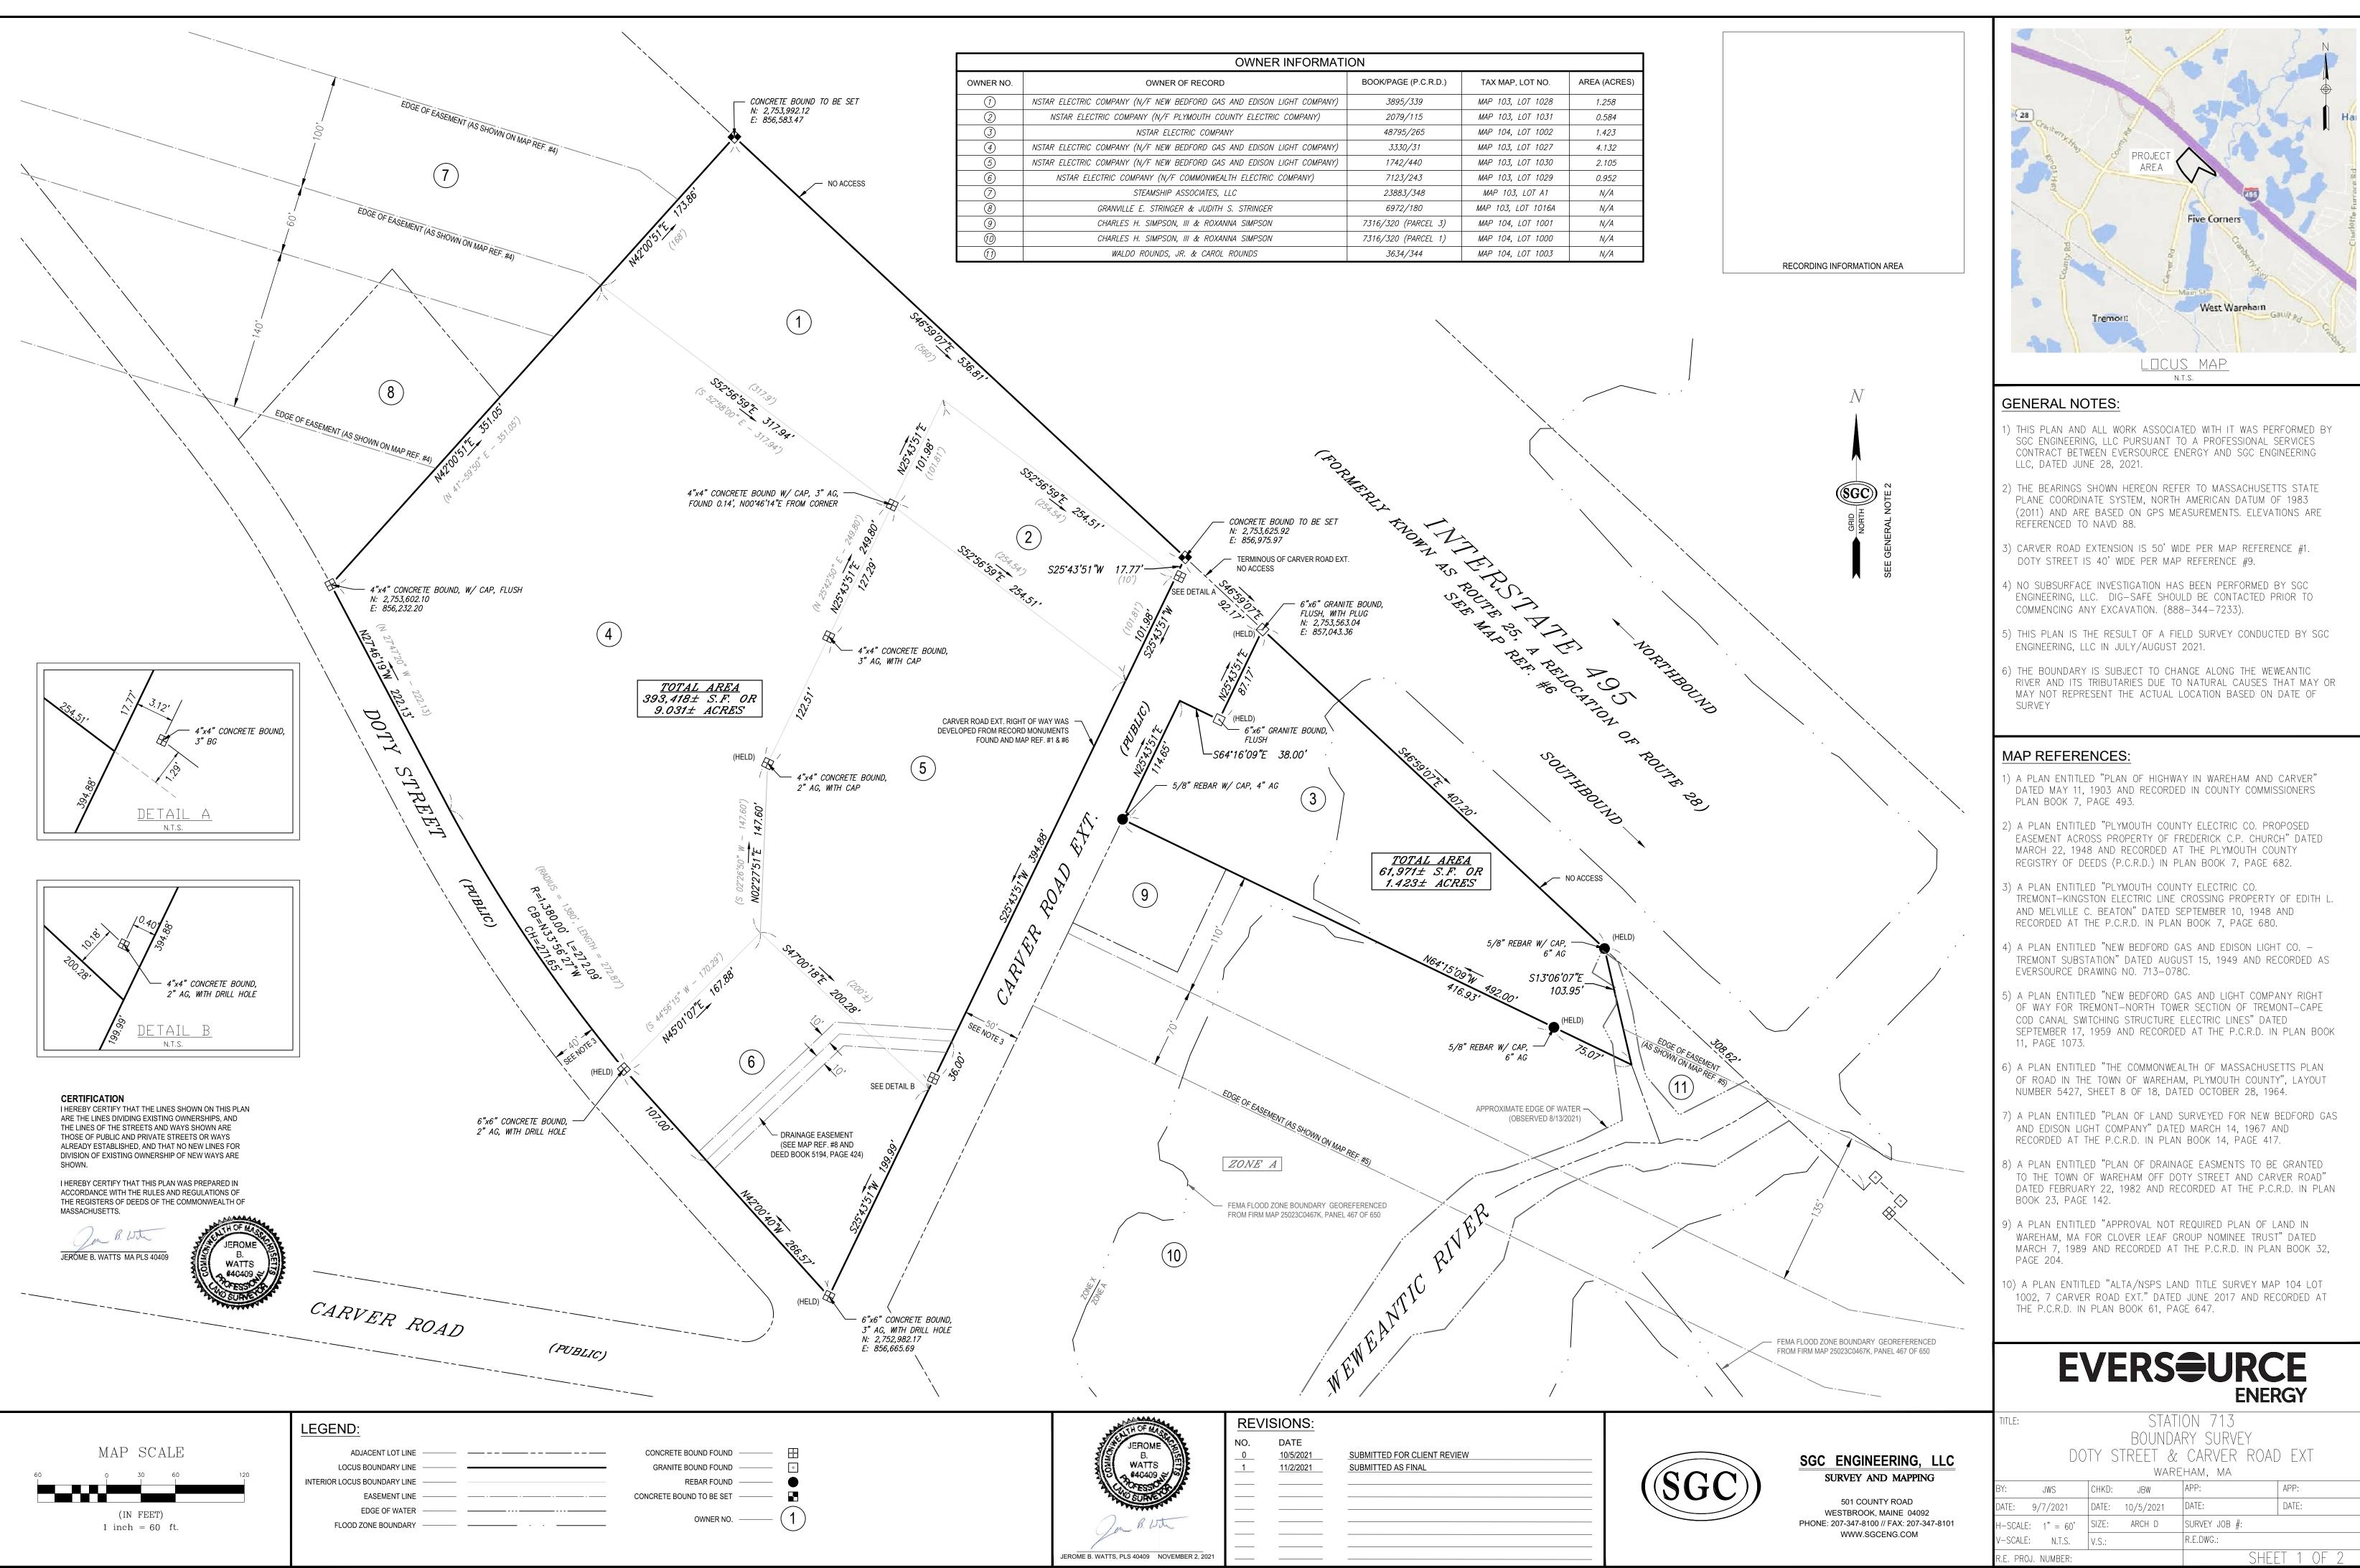


e: Station 713 Boundary Survey									
DO	DOTY STREET & CARVER ROAD EXT wareham, ma								
JWS	CHKD: JBW	APP:	APP:						
E: 9/7/2021	DATE: 10/5/2021	DATE:	DATE:						
SCALE: 1" = 60'	SIZE: ARCH D	SURVEY JOB #:							
SCALE: N.T.S.	V.S.:	R.E.DWG.:							
. PROJ. NUMBER:		Shee	ET 1 OF 2						

			<u> </u>					``	
		FAVA TO PLYMA	MISSION 1			WF2-106		W.	WF2-100 START
		DEED BOO	H COUNTY ELEC K 2018, PAGE 306 ()	EMENT TRIC COMPANY P.C.R.D.)	EDGE OF EASEMENT (AS SHO	END/OPEN			
					_ 100'.	WF2-200 START		-68	
1,		-		· · · · · ·		7)			
\	<u> </u>				EDGE OF EASEMENT ;	T4		113.86	- F
`, FAIJ	TRAM	<u> </u>	<u>,</u>	/	WF2-214	REF, #4)		151 13- 14- 150 - 14- 150 - 14-	
	DEED BOOK 1;	SSION LINE EASEME D GAS & EDISON LI 746, PAGE 391 (P.C.)	ENT SHT ca		END/OPEN			NA2 150	
$\langle \rangle$	Ì	° ' (P.C.)	R.D.)					GRAVEL	
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				`\	HAR I I	3 7		GRAVEL	Ē
					N27746;19"W		+ STOR	AGE GP GP	
INVERT				]		CRANEL		× ×	
NAME <i>CB-1</i>	RIVIELEV	^{7.} INV. A 69.8	INV. B	INV. C		* Gr			
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CB-3	73.8	N/A	N/A	N/A		ARAS TO THE			
<i>CB</i> -4		68.1	68.1	N/A	STREET	CON CON	SRETE SEE DE		74 CO
CB-5		68.1	68.1	70.4 N/A		78_		TAIL C	
CB-6 CB-7		69.4 73.4	69.3 69.0	N/A N/A				B	
CB-8	74.7	N/A	N/A	N/A		OU BITICE	180 7.15	ONCRETE D	14
CB-9	74.7	71.4	71.4	N/A		-77 F	100, 33,56, Lang	TAR ~	© /
<i>CB</i> -10		71.8	71.7	N/A			2017	(E)	
CB-12 CB-12		N/A N/A	N/A N/A	N/A N/A		, 76			INV.
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DMH-2	2 74.2	68.2	68.5	N/A		Ň	K M	GRAVEL	
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DMH-3	5 78.2	73.4	73.1	N/A			FILLED WITH SHIE	15 F. 19. 18. 1980 F.	Stewarts Barris
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			$C_{1}$	ARVER	ROAD			CLOGGED, TO OBTAIN	INVERTS
					A[]	(PUBLIC)			/
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	$\lambda I \wedge \nabla$				LEGEND:			GUARDRAIL WETLAND DELINEATION TREELINE	
60		SCALE		120	ABUTTER BOUNDARY LINE	X	X	STORM DRAIN LINE	
					MAJOR CONTOUR			BOLLARD — DECIDUOUS TREE —	0 [_]
		FEET)			EDGE OF CONCRETE	********			
	1 men	= 60 ft.			EDGE OF GRAVEL			GUY POLE —	

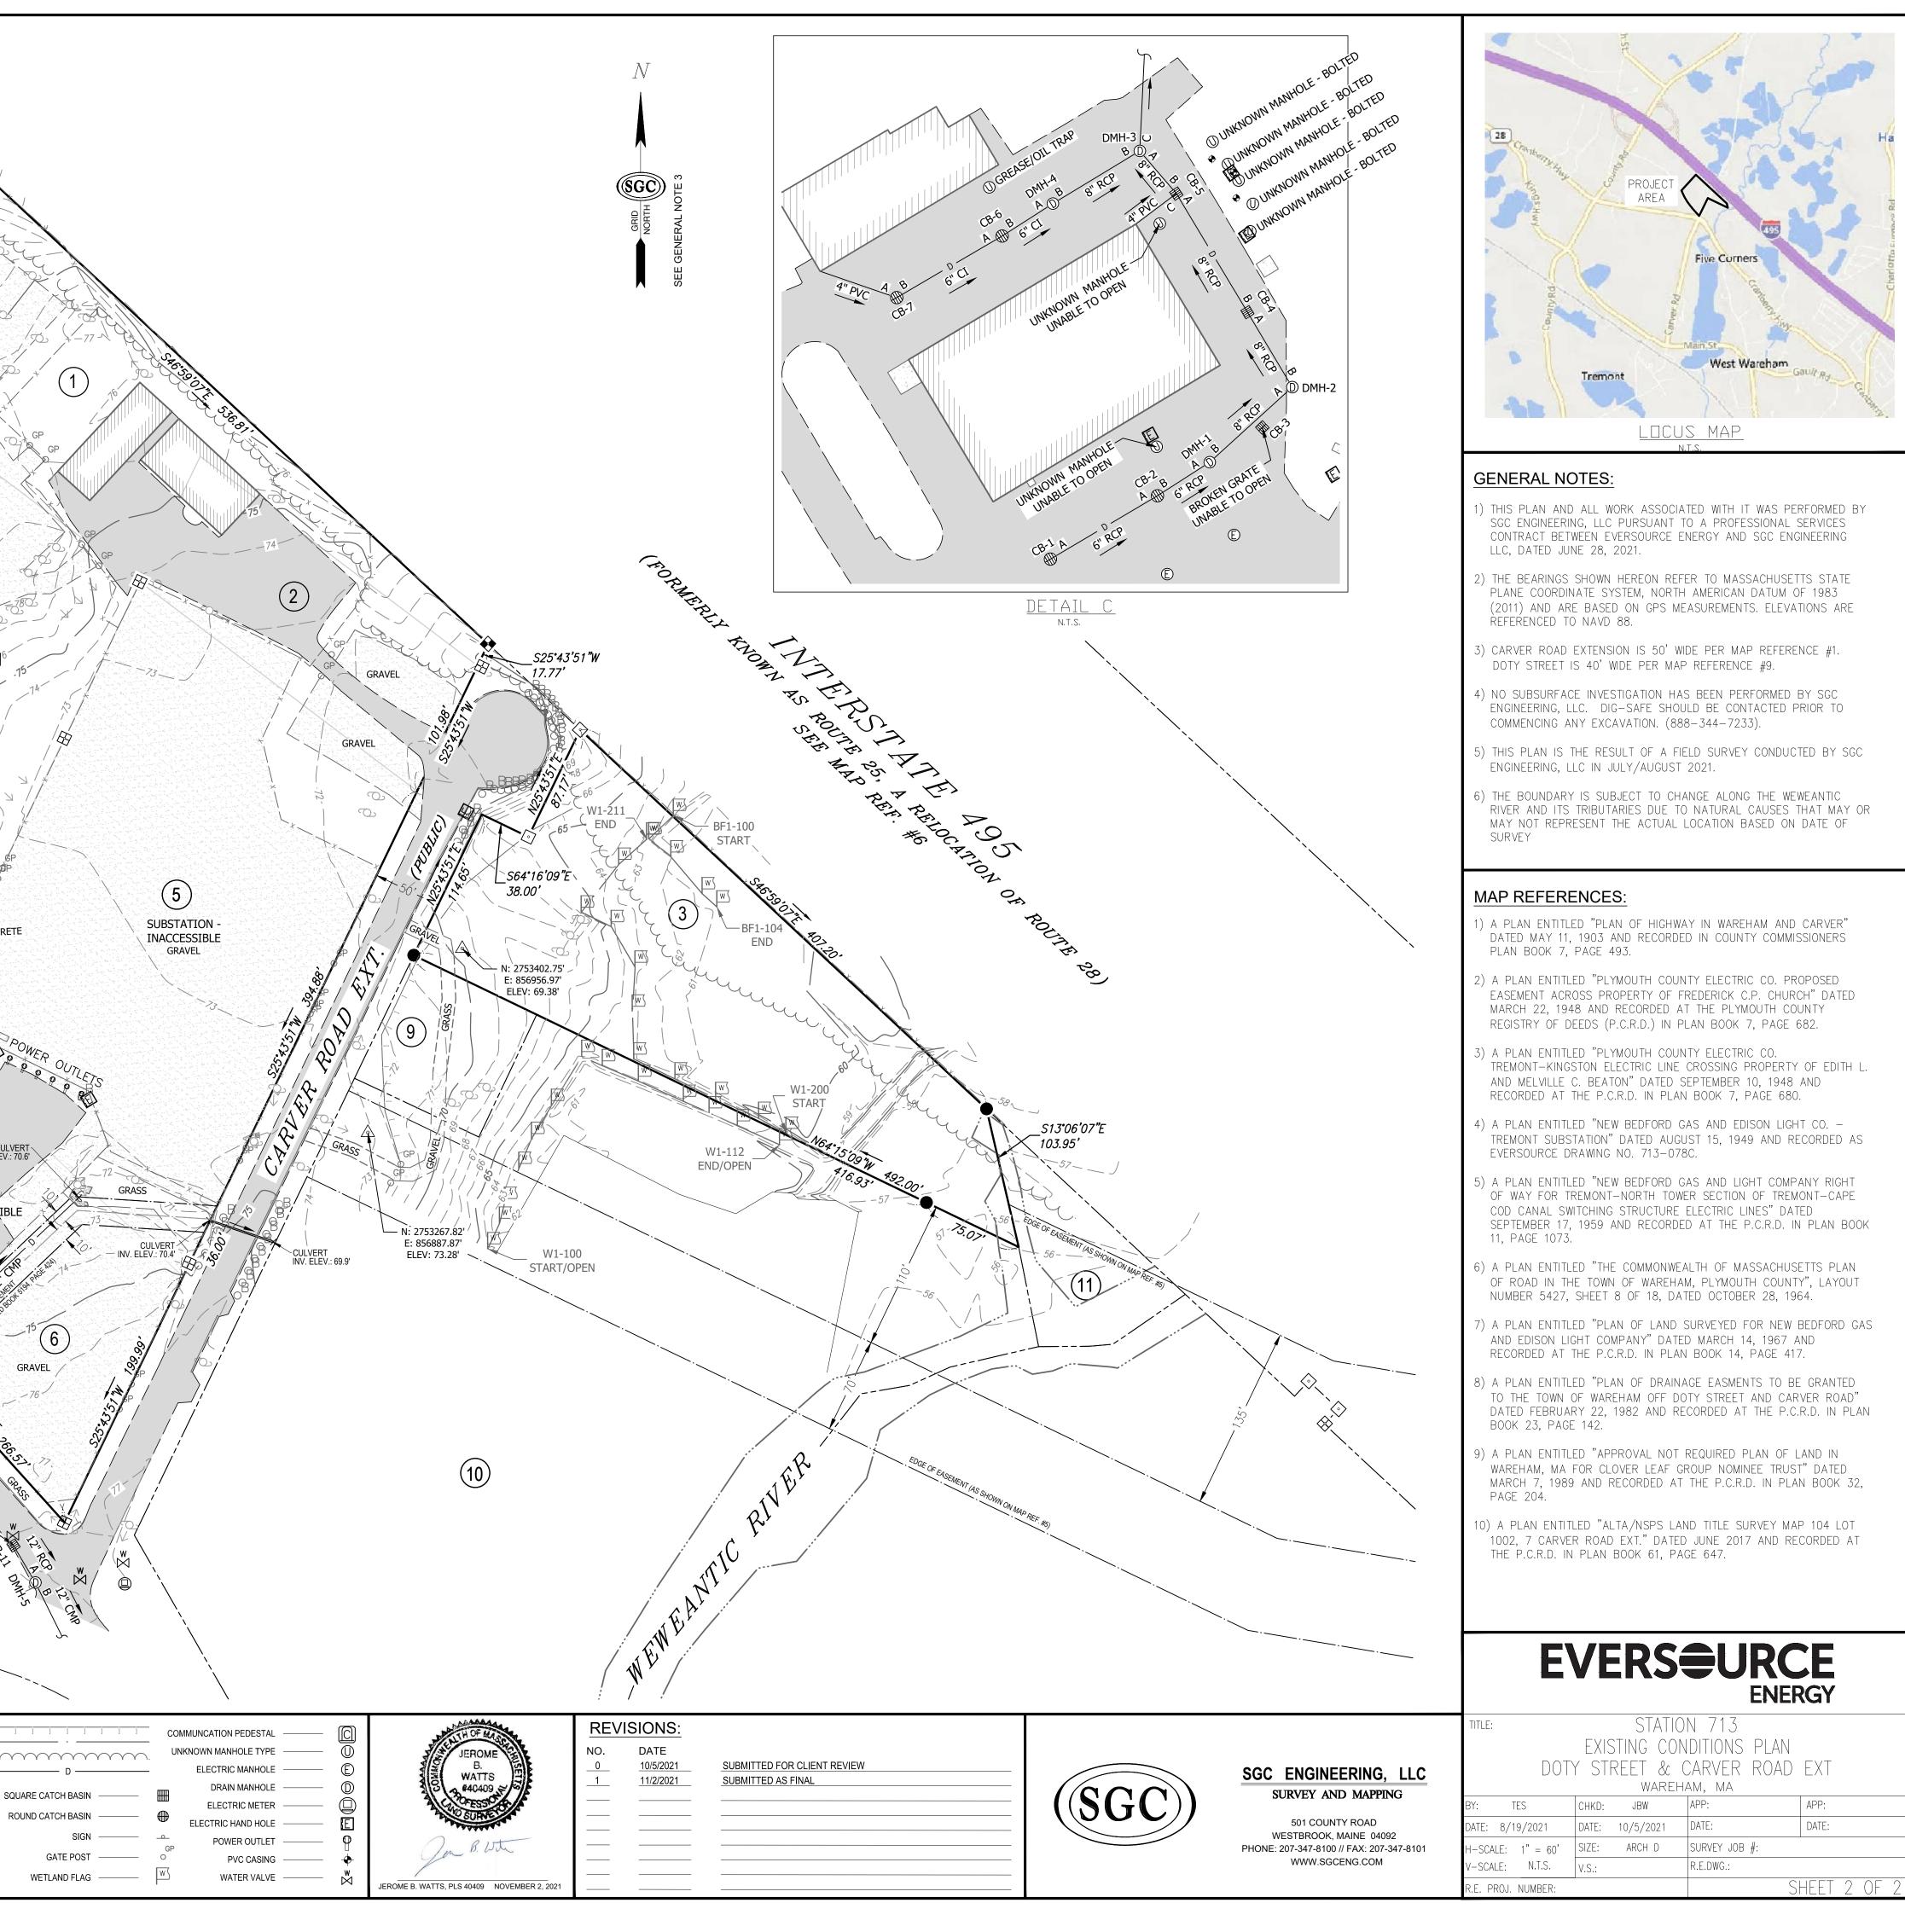


TITLE: STATION 713 EXISTING CONDITIONS PLAN									
		EXISTING CON	DITIONS PLAN						
C	DOTY STREET & CARVER ROAD EXT								
-		WAREHA	AM, MA						
	BY: TES	CHKD: JBW	APP:	APP:					
	DATE: 8/19/2021	DATE: 10/5/2021	DATE:	DATE:					
01	H-SCALE: 1" = 60'	SIZE: ARCH D	SURVEY JOB #:						
	V–SCALE: N.T.S.	V.S.:	R.E.DWG.:						
	R.E. PROJ. NUMBER:		S	HFFT 2 OF					



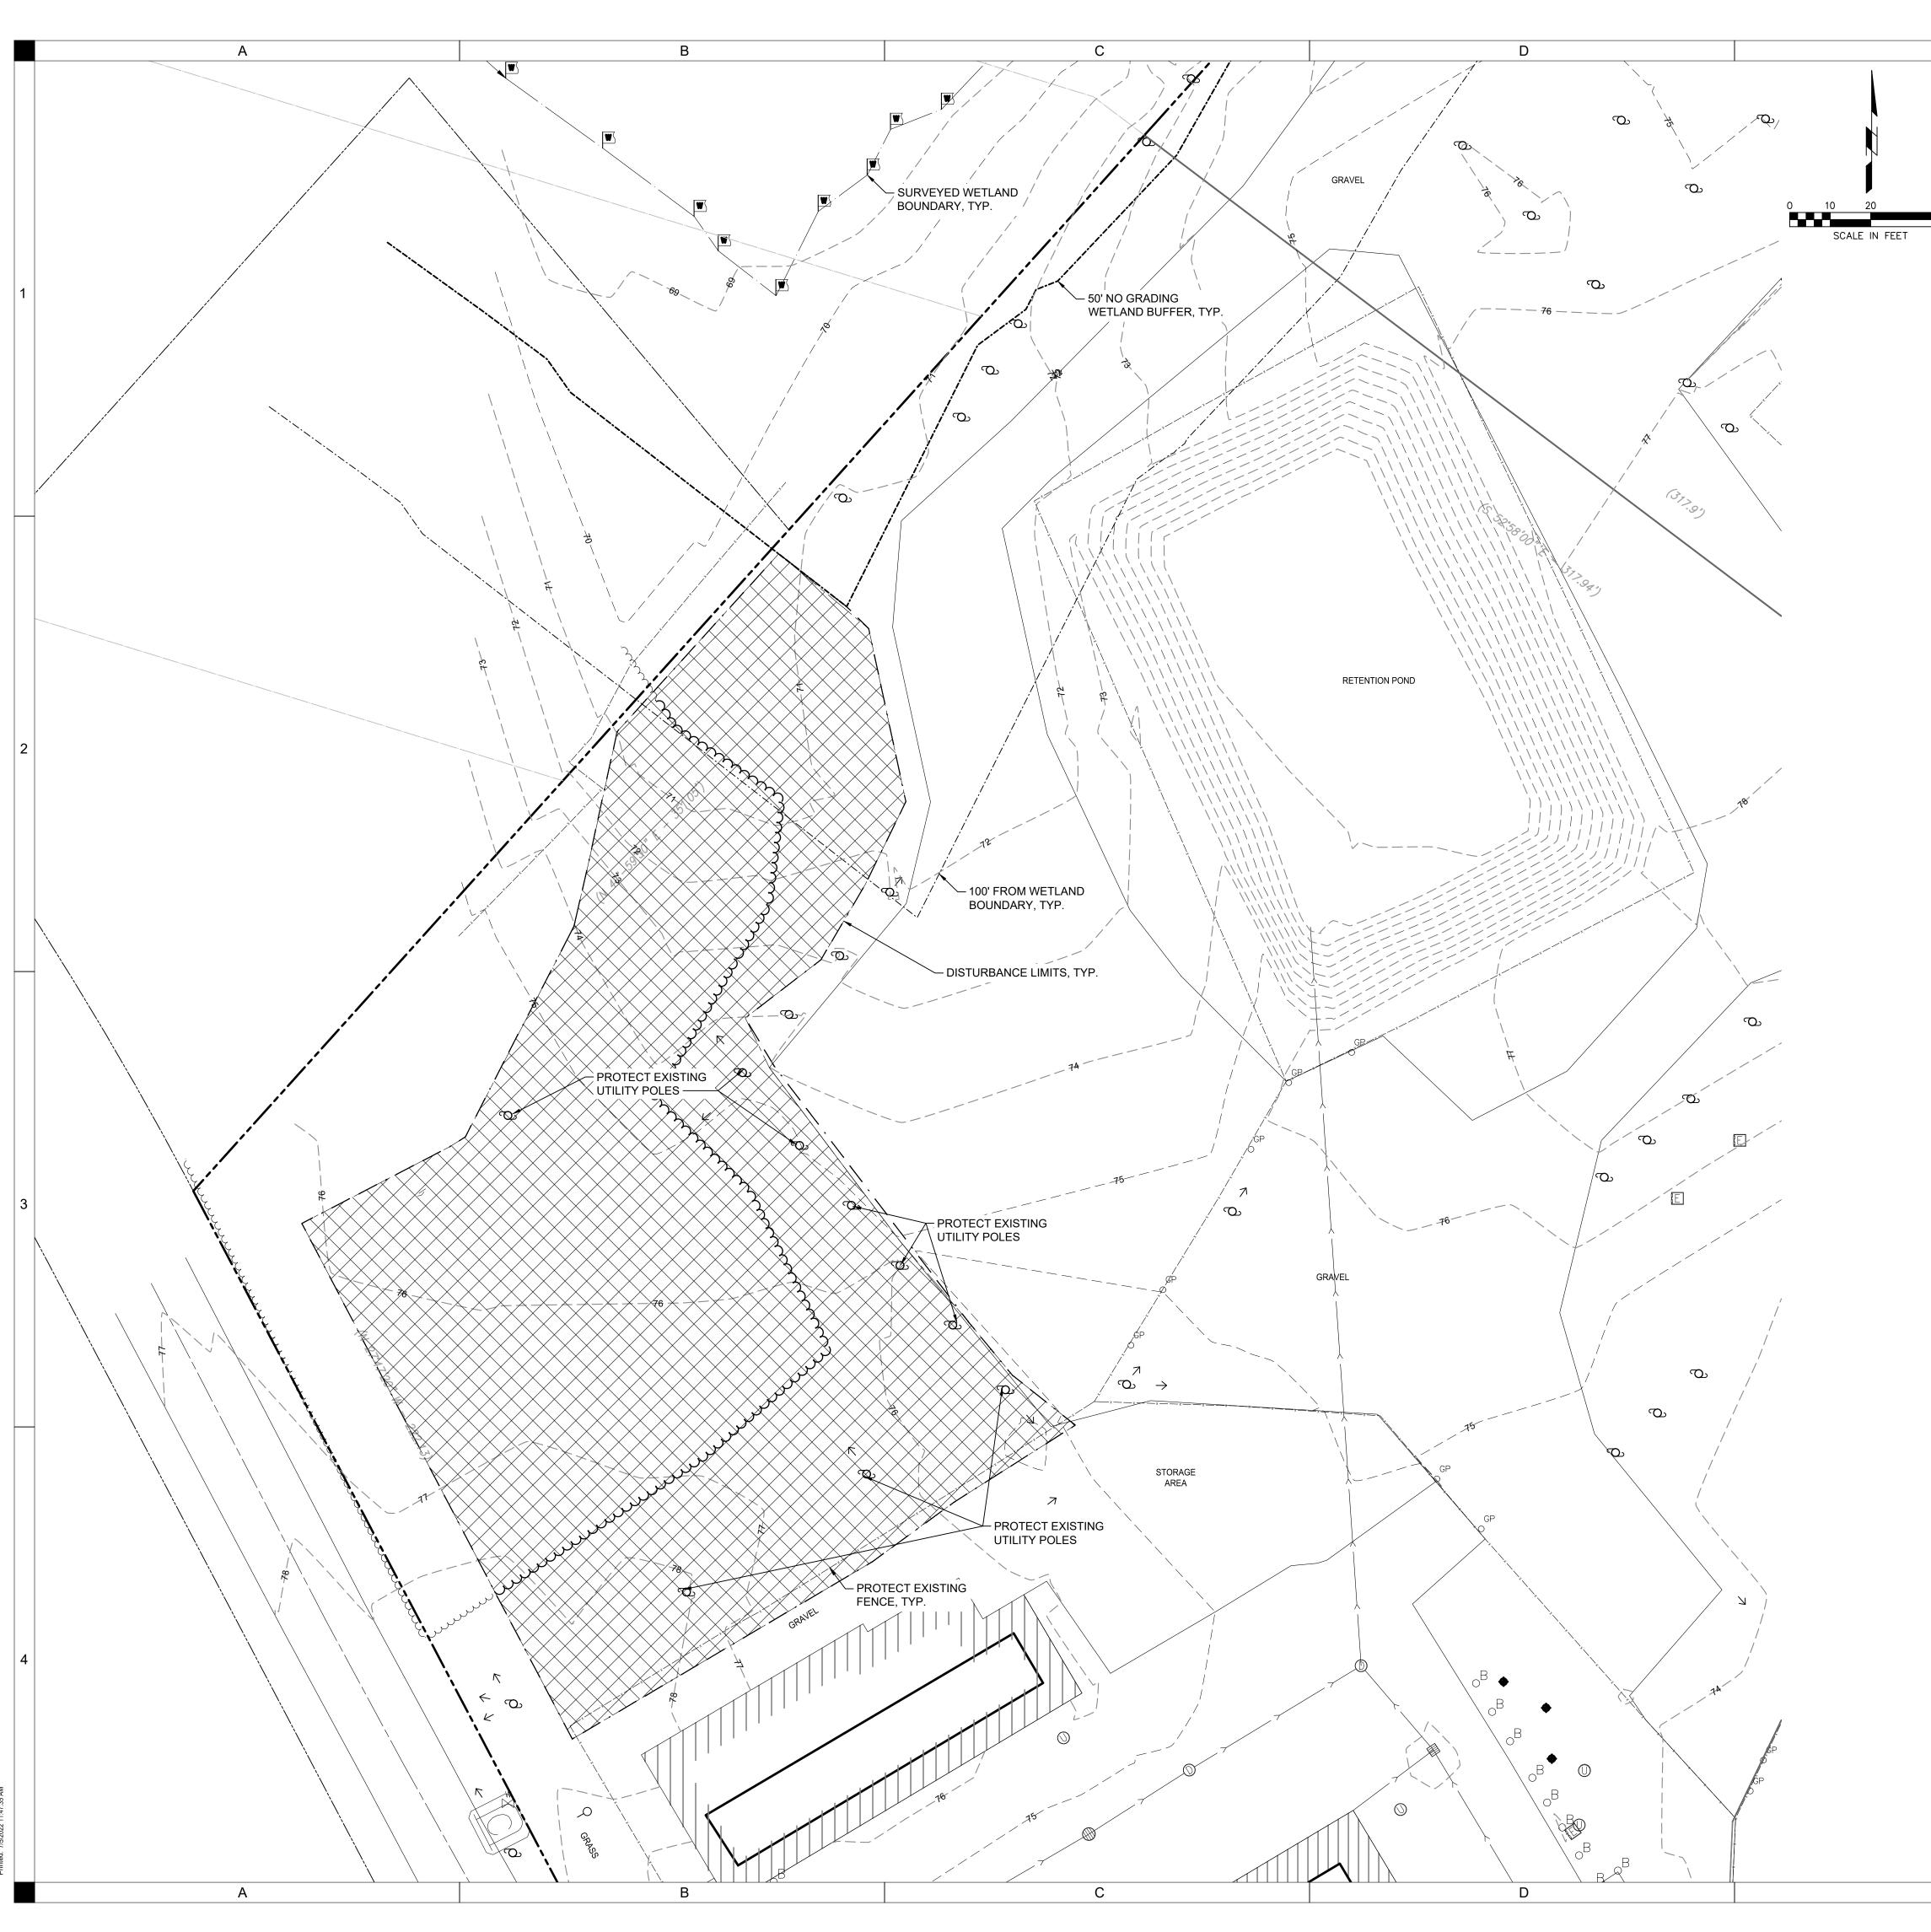

### LEGEND:

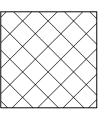


CLEAR AND GRUB REMOVAL APPROX. 0.58 ACRES

### GENERAL NOTES:


- 1. CONTRACTOR TO CONFIRM THE HORIZONTAL AND VERTICAL LOCATION OF ALL EXISTING UTILITIES AND INFORM THE ENGINEER OF ANY POTENTIAL CONFLICTS WITH PROPOSED UTILITIES PRIOR TO CONSTRUCTION.
- 2. ALL UTILITIES AND PAVEMENT NOT SHOWN TO BE REMOVED SHALL BE PROTECTED. IF DAMAGED, IT IS THE CONTRACTOR'S RESPONSIBILITY TO REPLACE AND REPAIR.
- 3. CONTRACTOR SHALL COORDINATE WITH OWNER, UTILITY PROVIDER, AND ANY AFFECTED ADJACENT PROPERTY OWNERS OR EXISTING TENANTS PRIOR TO ANY SERVICE OR ACCESS DISRUPTIONS.

F

1	CONTRACT       CONTRACT       CONTRACT         CONTRACT       CONTRACT       CONTRACT       CONTRACT
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3	DRAWN: EAW APPROVED: JMR ISUED FOR: PERMIT RESUBMITTAL ISUED FOR: PERMIT RESUBMITTAL DATE: 07/05/202 PROJECT NO: 7211970 FIELD BOOK:
4	EXISTING EXISTING CONDITIONS & CDD01 CDD01

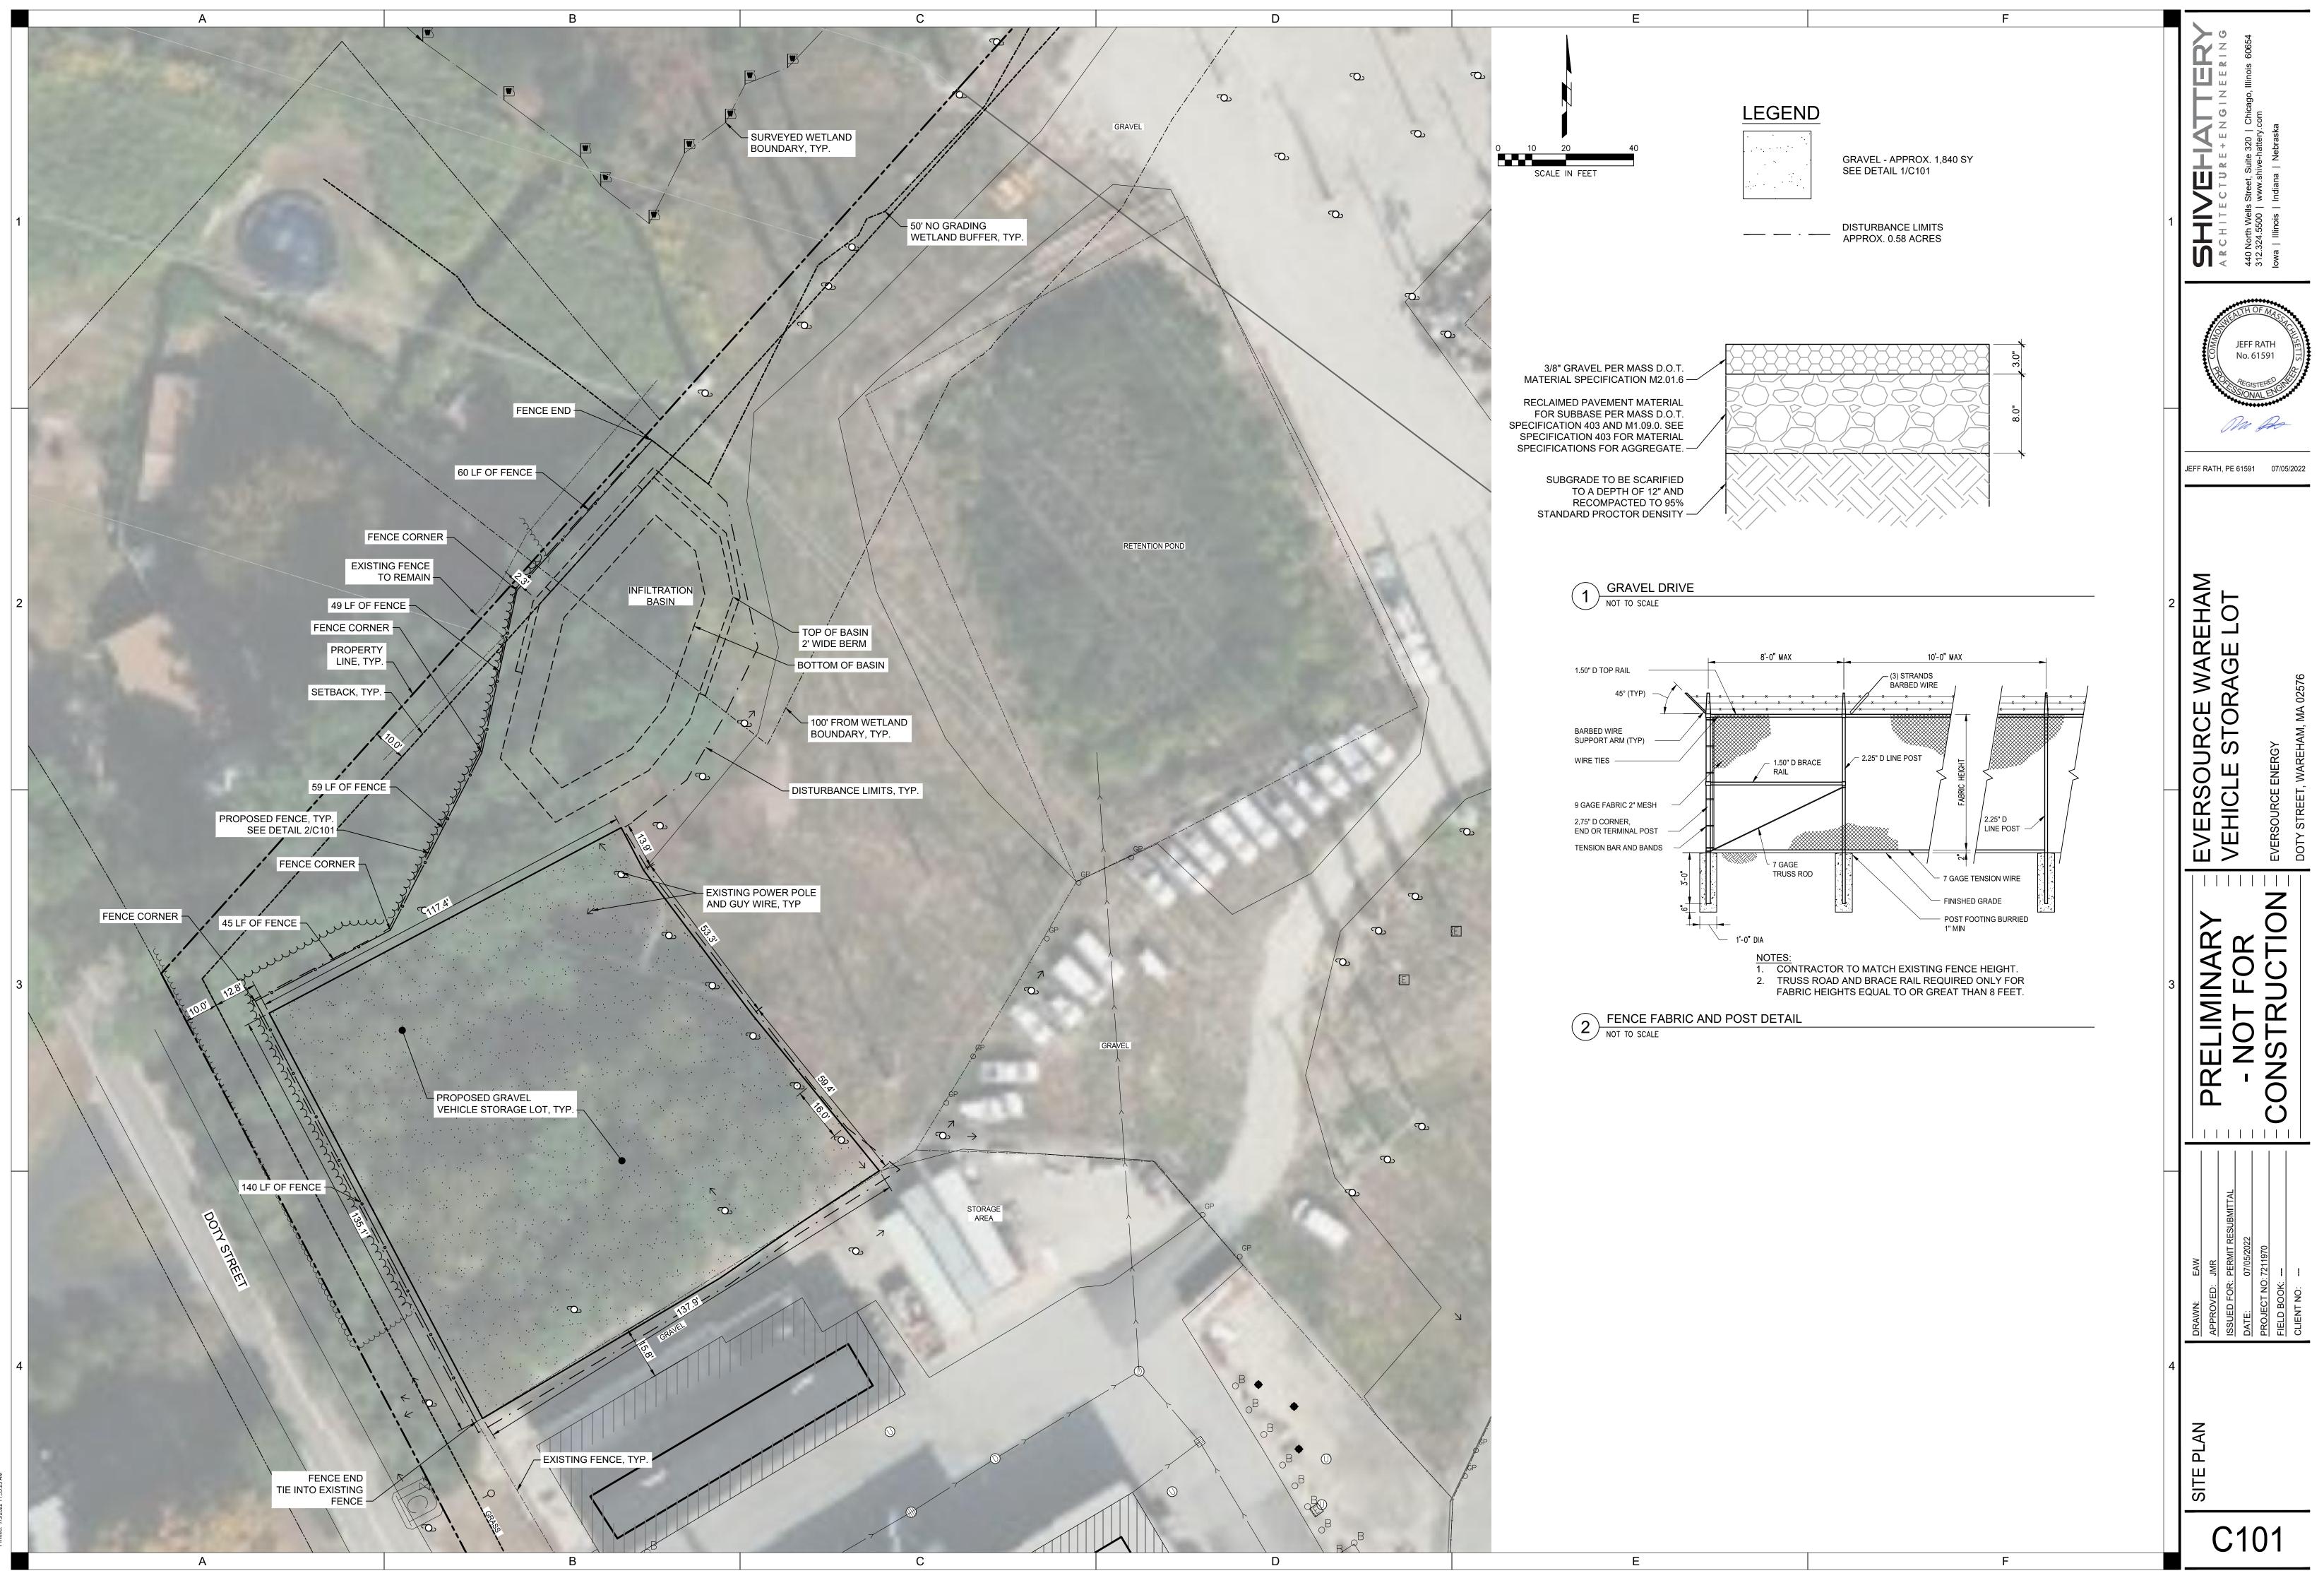


1	SHOREHARTER         OMPORT         O
	Mar Ba
	JEFF RATH, PE 61591 07/05/2022
2	<ul> <li>EVERSOURCE WAREHAM</li> <li>VEHICLE STORAGE LOT</li> <li>EVERSOURCE ENERGY</li> <li>DOTY STREET, WAREHAM, MA 02576</li> </ul>
	EVER VEHI( eversour doty stre
3	<ul> <li>PRELIMINARY</li> <li>PRELIMINARY</li> <li>- NOT FOR</li> <li>- CONSTRUCTION</li> </ul>
	DRAWN:EAWAPPROVED:JMRAPPROVED:JMRISSUED FOR:PEMIT RESUBMITTALDATE:07/05/2022DATE:07/05/2022PROJECT NO:7211970FIELD BOOK:CLIENT NO:
4	SITE PLAN
	C101

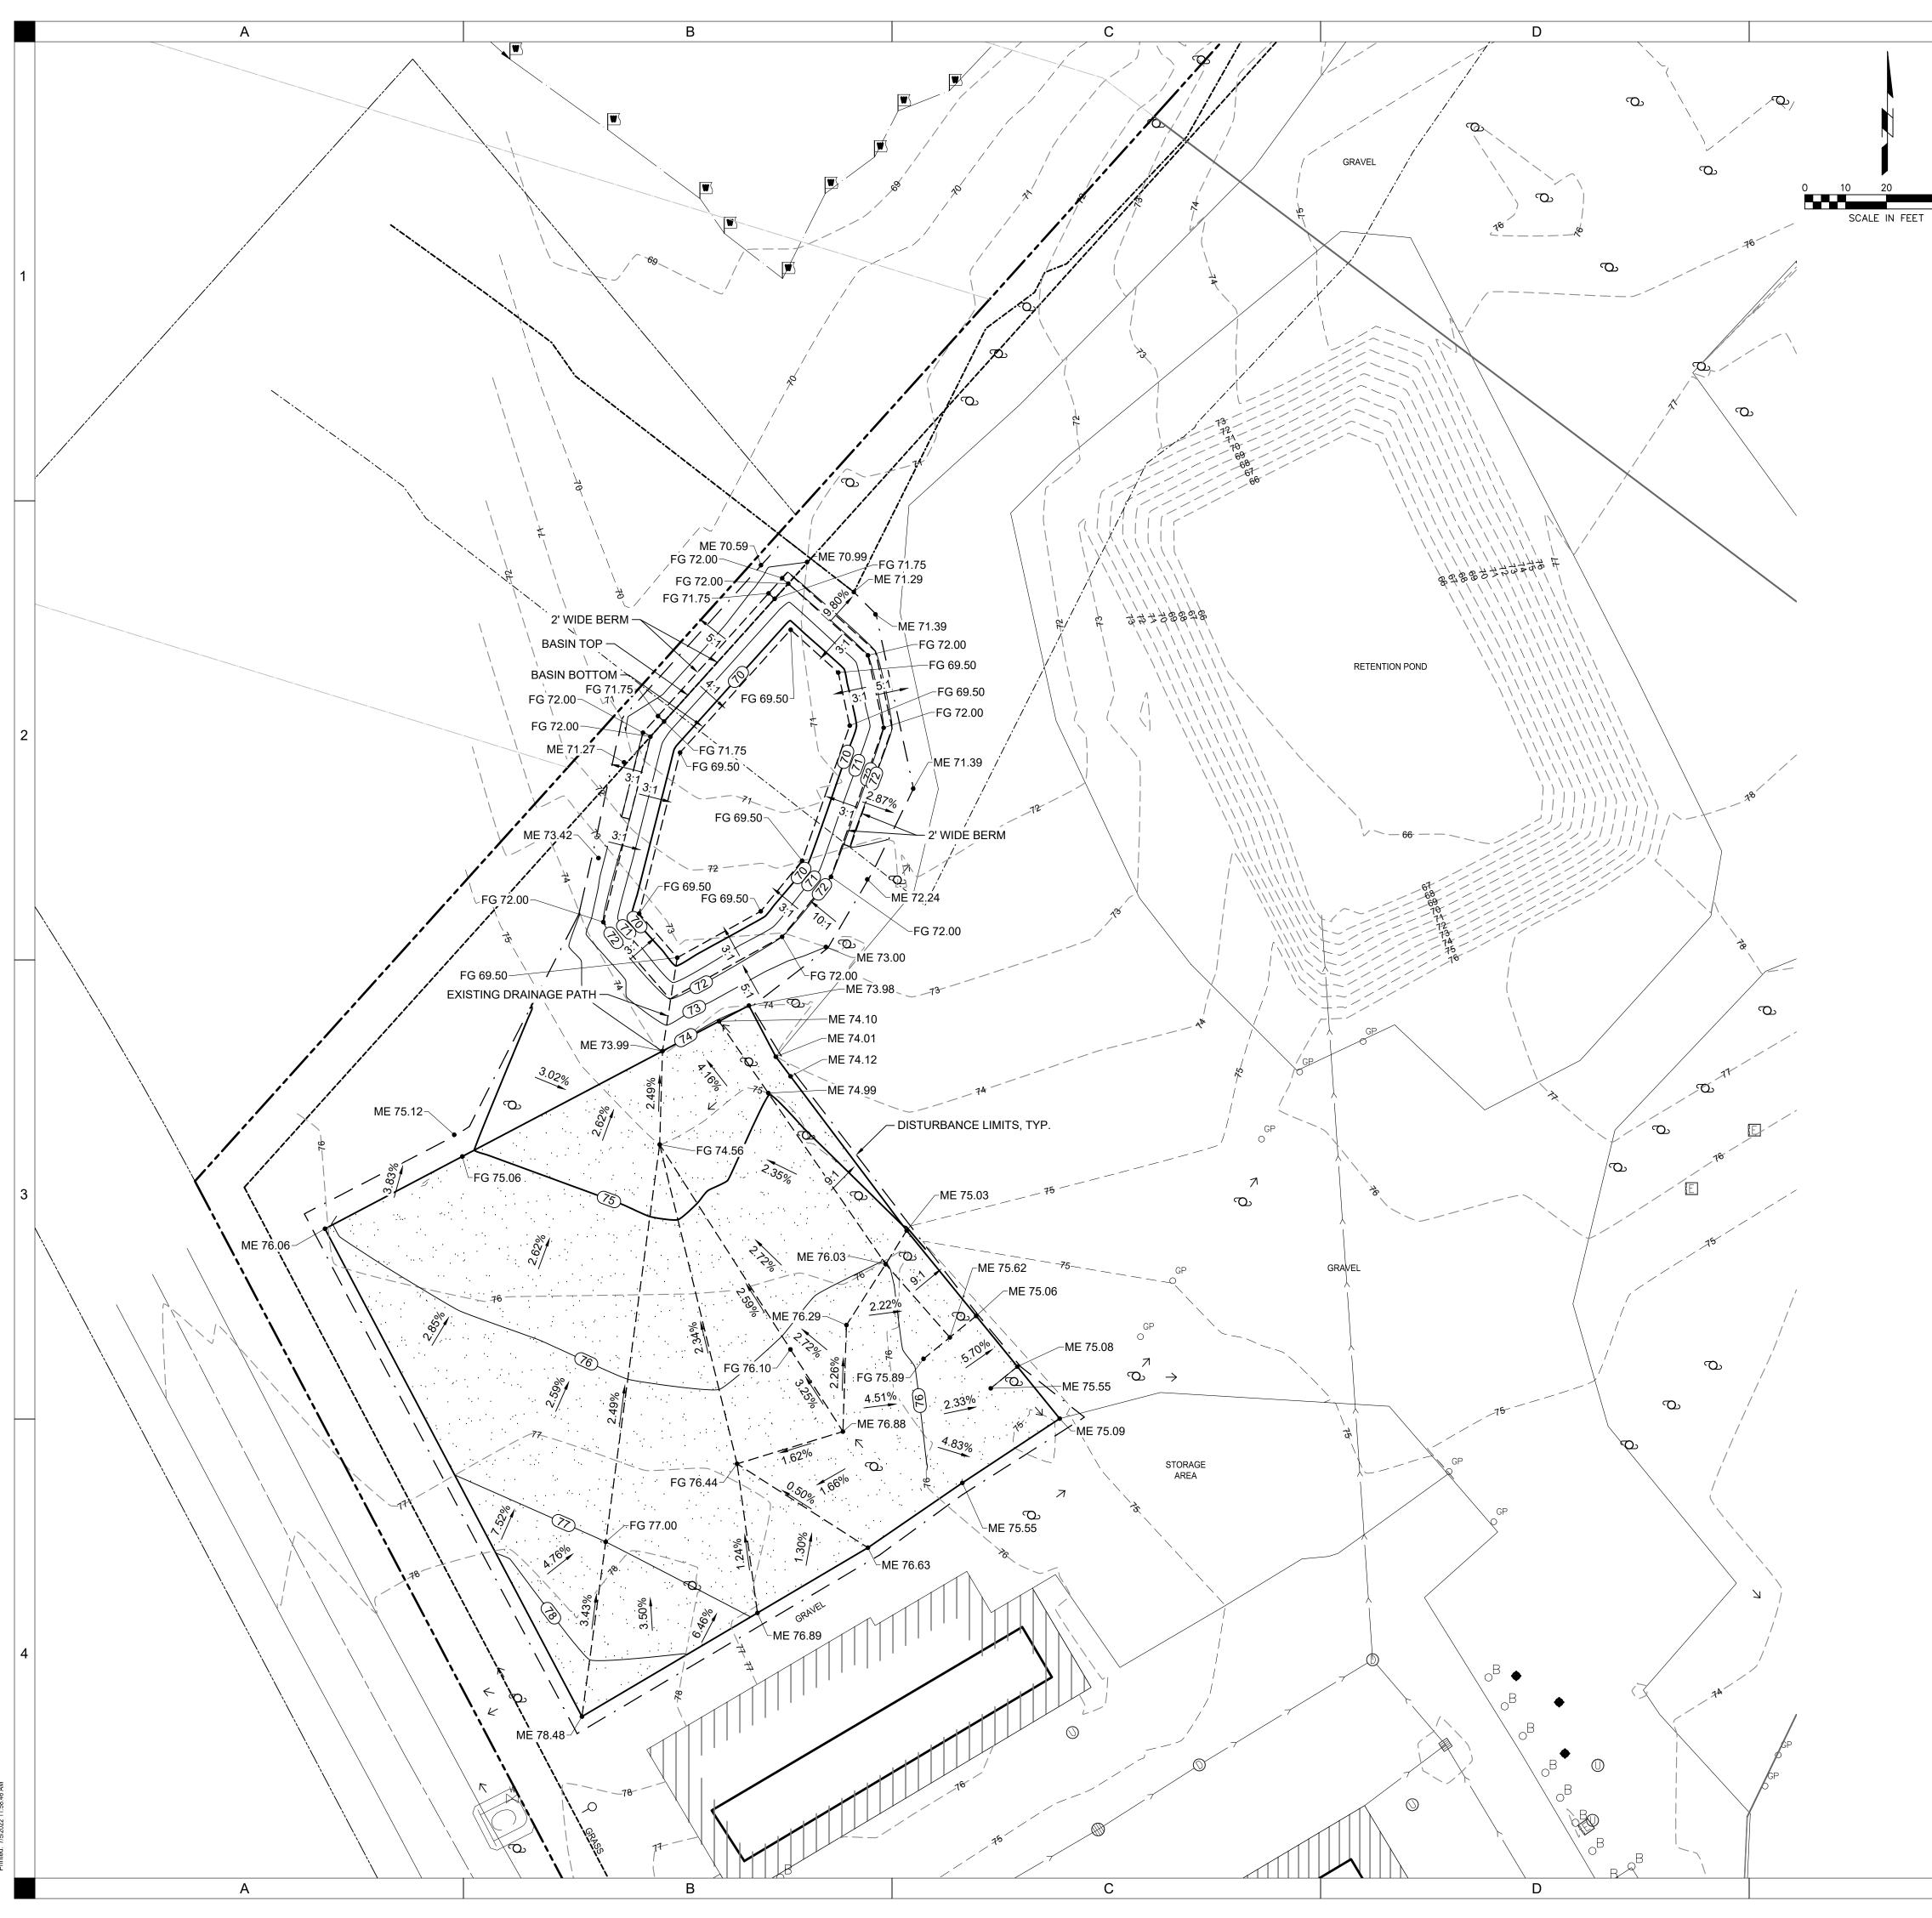

## LEGEND:

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GRAVEL SEE DETAIL 1/C101

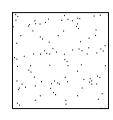F

## LEGEND:

_____

GRADE BREAK

## GRADING LEGEND:

ME - MATCH EXISTING GRADE TC - TOP OF CURB ELEVATION GU - GUTTER ELEVATION TS - TOP OF SLAB ELEVATION TW - ELEVATION AT TOP OF WALL BW - ELEVATION AT BOTTOM OF WALL EG - EXISTING GRADE ELEVATION FG - FINISHED GRADE ELEVATION FFE - FINISHED FLOOR ELEVATION LP - LOW POINT


GENERAL NOTES:

HP - HIGH POINT


- FINISHED GRADE CONTOURS ARE SHOWN AT 1' AND 5' INTERVALS.
- 2. EXISTING GRADE CONTOURS ARE SHOWN AT 1' AND 5' INTERVALS.
- FINISHED GRADE IS TO TOP OF PAVEMENT AND TOP OF GRAVEL, UNLESS OTHERWISE NOTED.
- CONTRACTOR SHALL COORDINATE WITH OWNER FOR ACCEPTABLE STAGING AREAS.

1	ARCHITECTURE+ENGINEERING ARCHITECTURE+ENGINEERING 440 North Wells Street, Suite 320   Chicago, Illinois 60654 312.324.5500   www.shive-hattery.com Iowa   Illinois   Indiana   Nebraska
	JEFF RATH, PE 61591 07/05/2022
2	EVERSOURCE WAREHAM VEHICLE STORAGE LOT EVERSOURCE ENERGY DOTY STREET, WAREHAM, MA 02576
3	- PRELIMINARY - NOT FOR CONSTRUCTION
4	DRAWN:     EAW       APPROVED:     JMR       APPROVED:     JMR       ISSUED FOR:     PERMIT RESUBMITTAL       DATE:     07/05/2022       PROJECT NO:     7211970       FIELD BOOK:        CLIENT NO:
	Egeret C201


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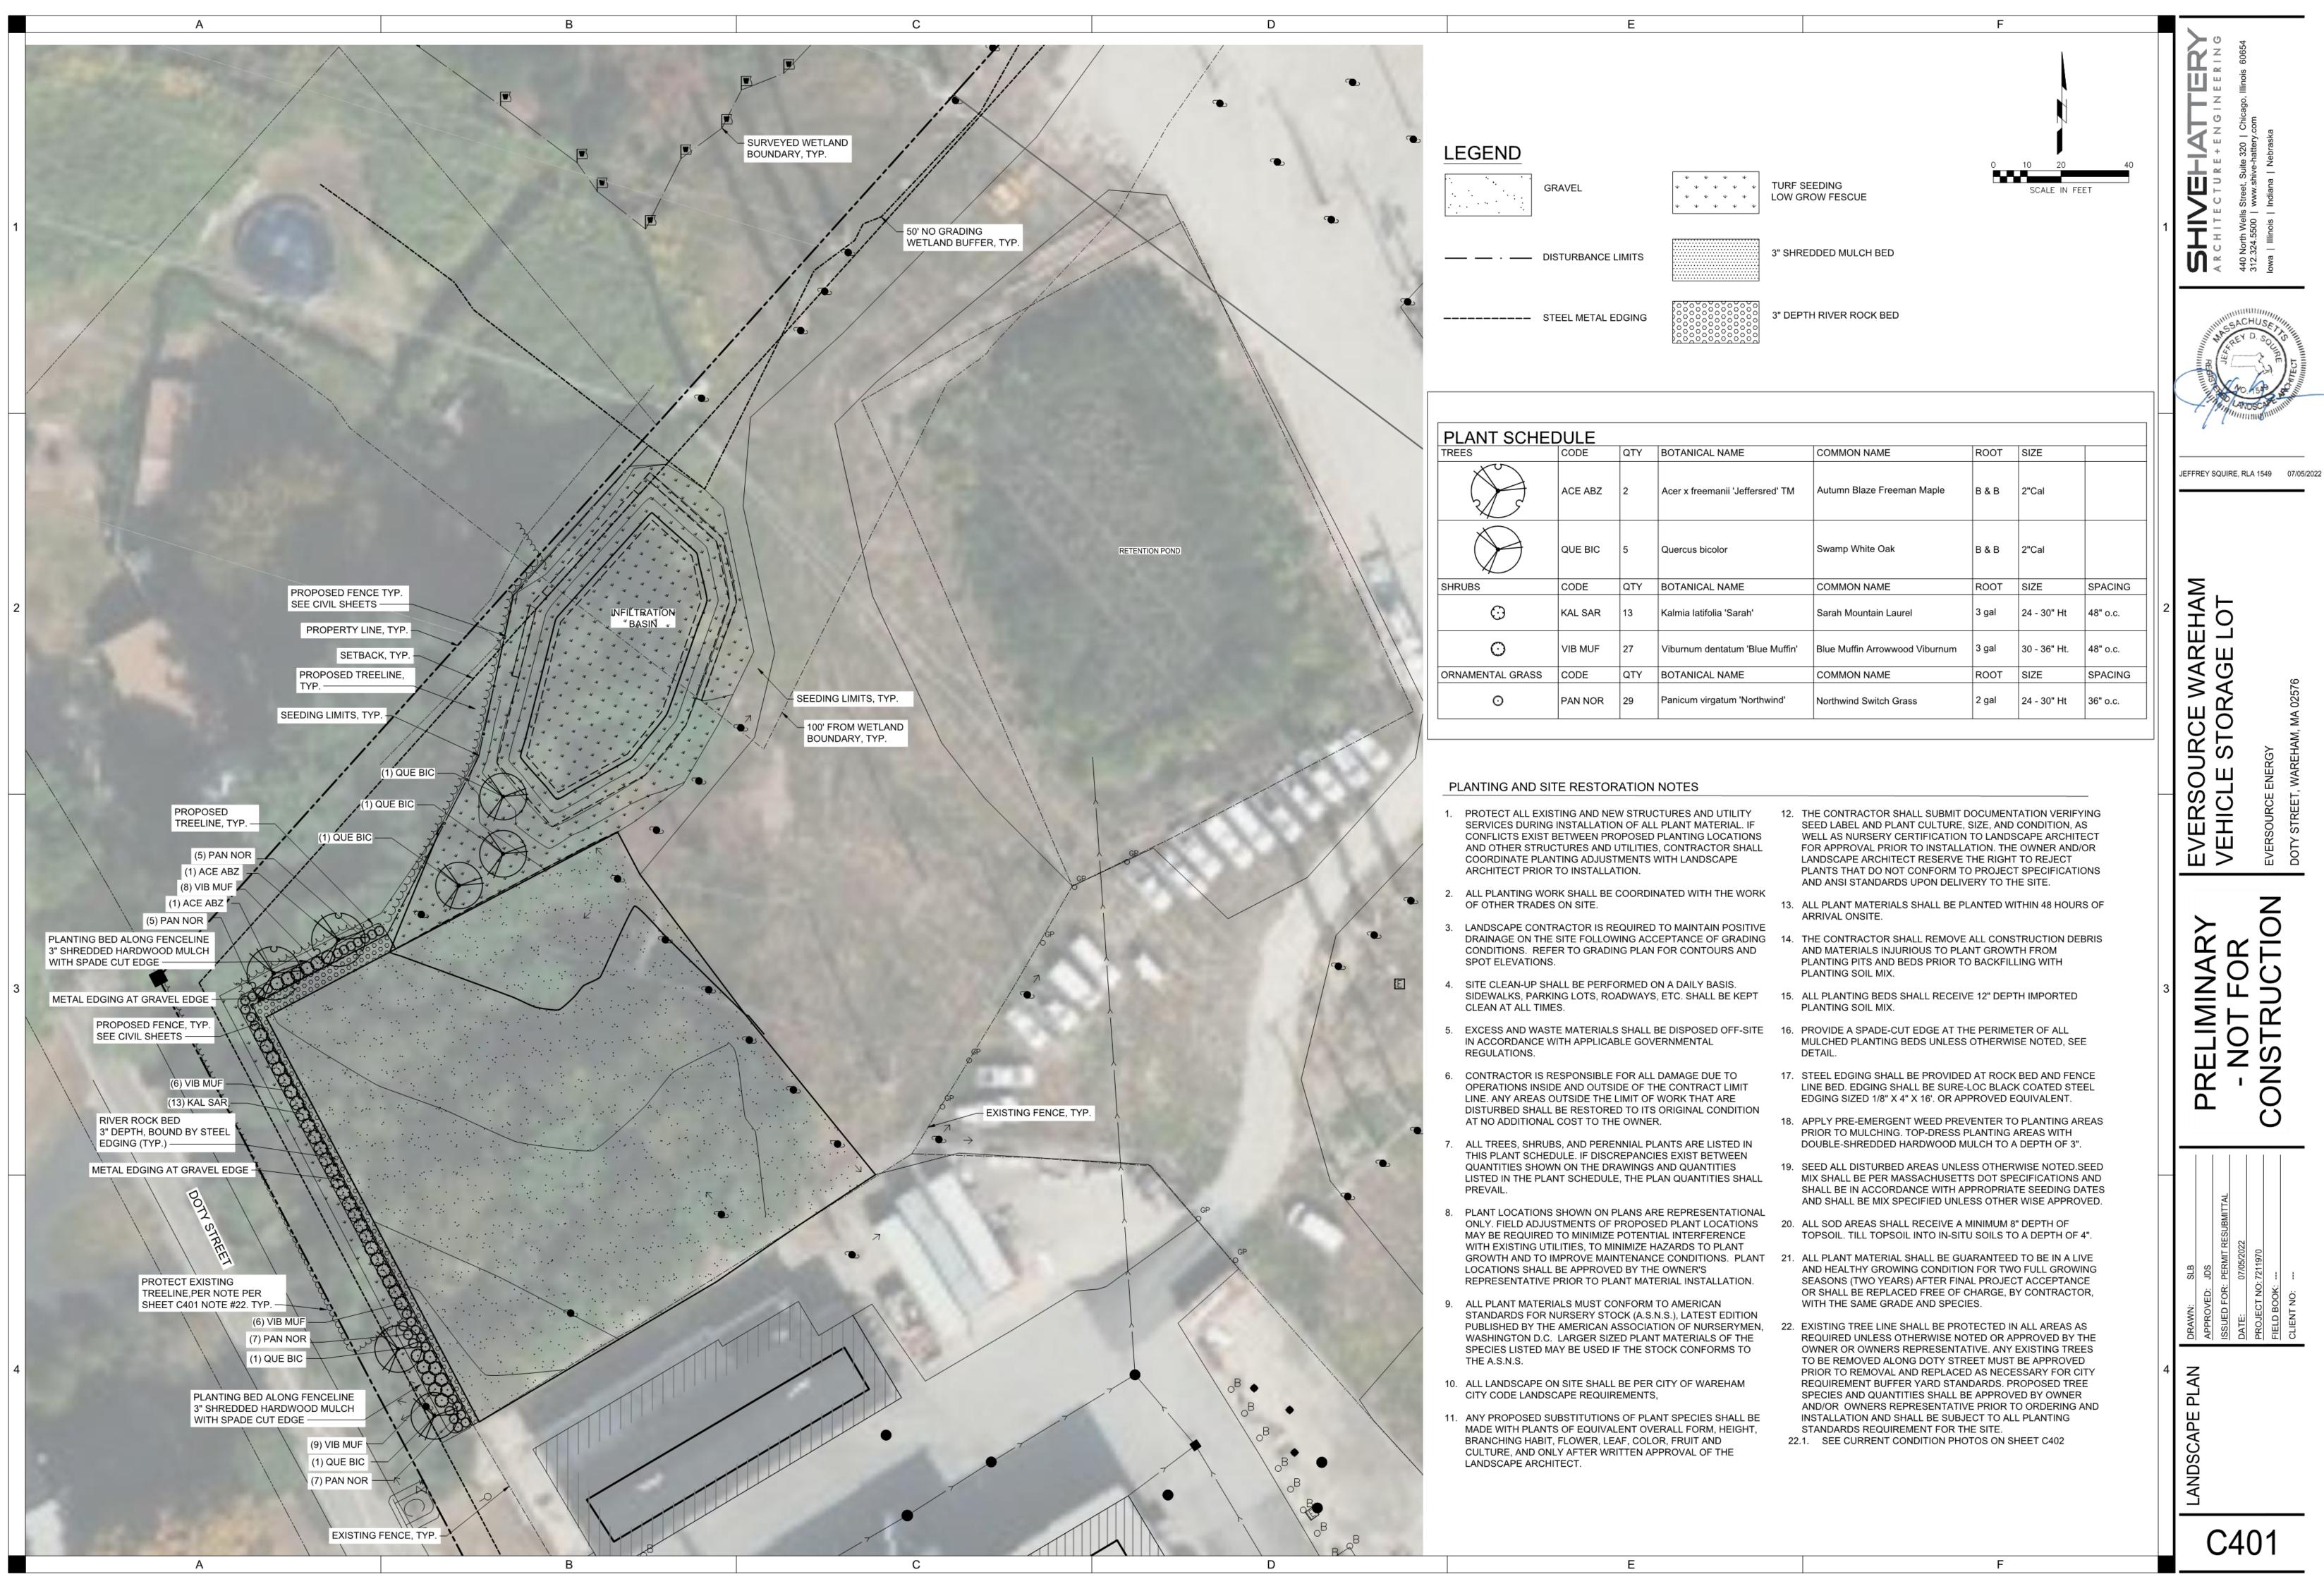


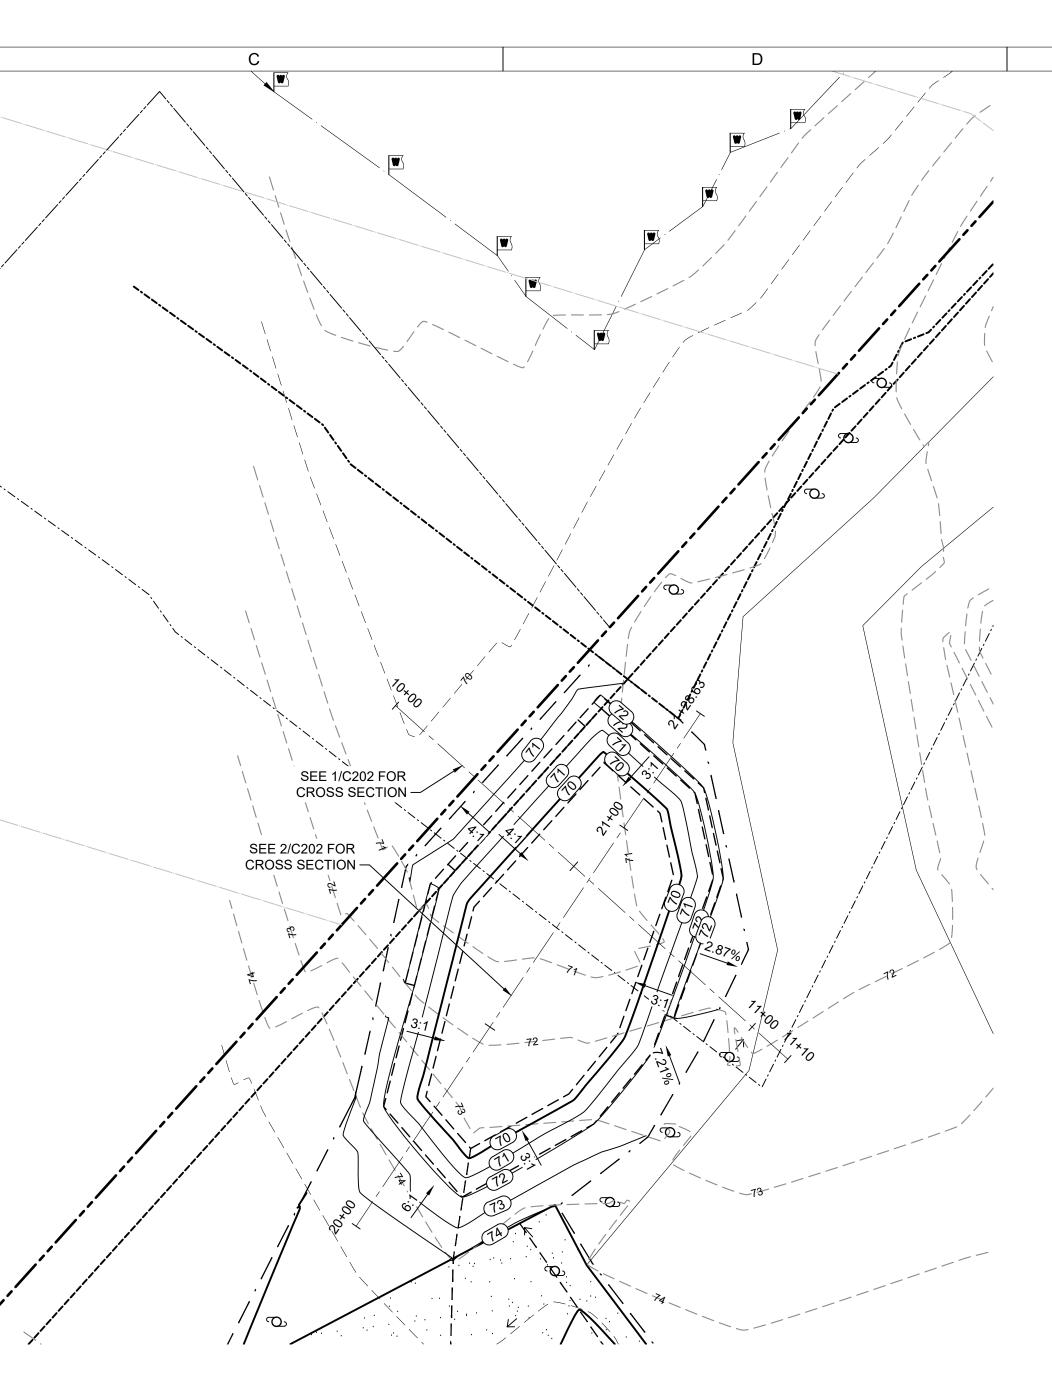
SCALE IN FEET

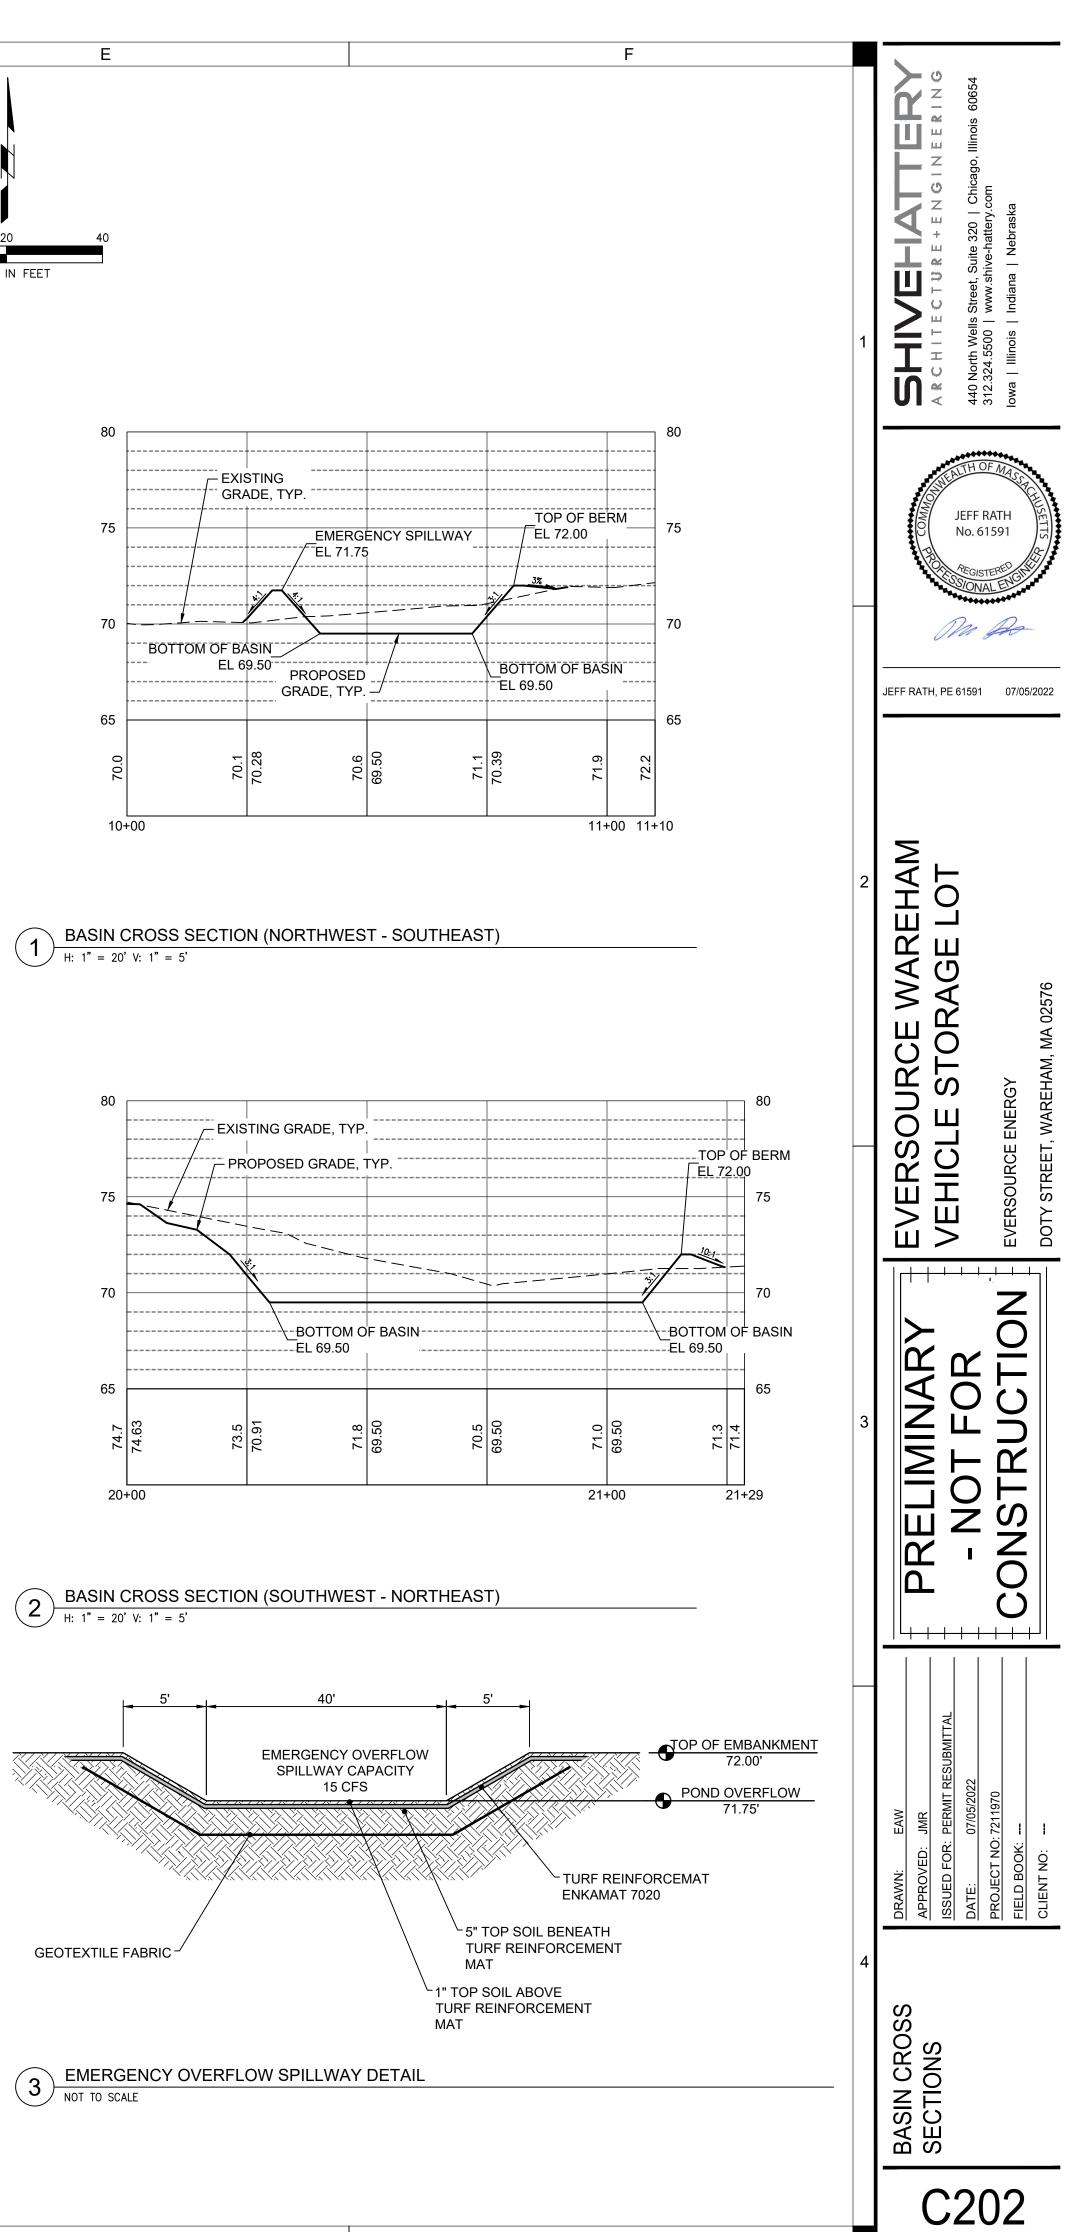


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NOTES:

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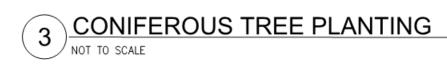
- 1. STEEL POSTS TO BE NOTCHED OR DRILLED TO RETAIN WIRES. PLACE OUTSIDE OF PLANTING HOLE. DRIVE PLUMB REGARDLESS OF GROUND SLOPE.
- 3. TREE STAKING IS REQUIRED FOR ALL DECIDUOUS TREES 2.0" CAL. OR LARGER. USE 3 STAKES.
- 4. TREE STAKING IS REQUIRED FOR ALL EVERGREEN TREES. USE 2 STAKES. 4. REMOVE AT THE END OF 1 YEAR.
- 2 TREE STAKING

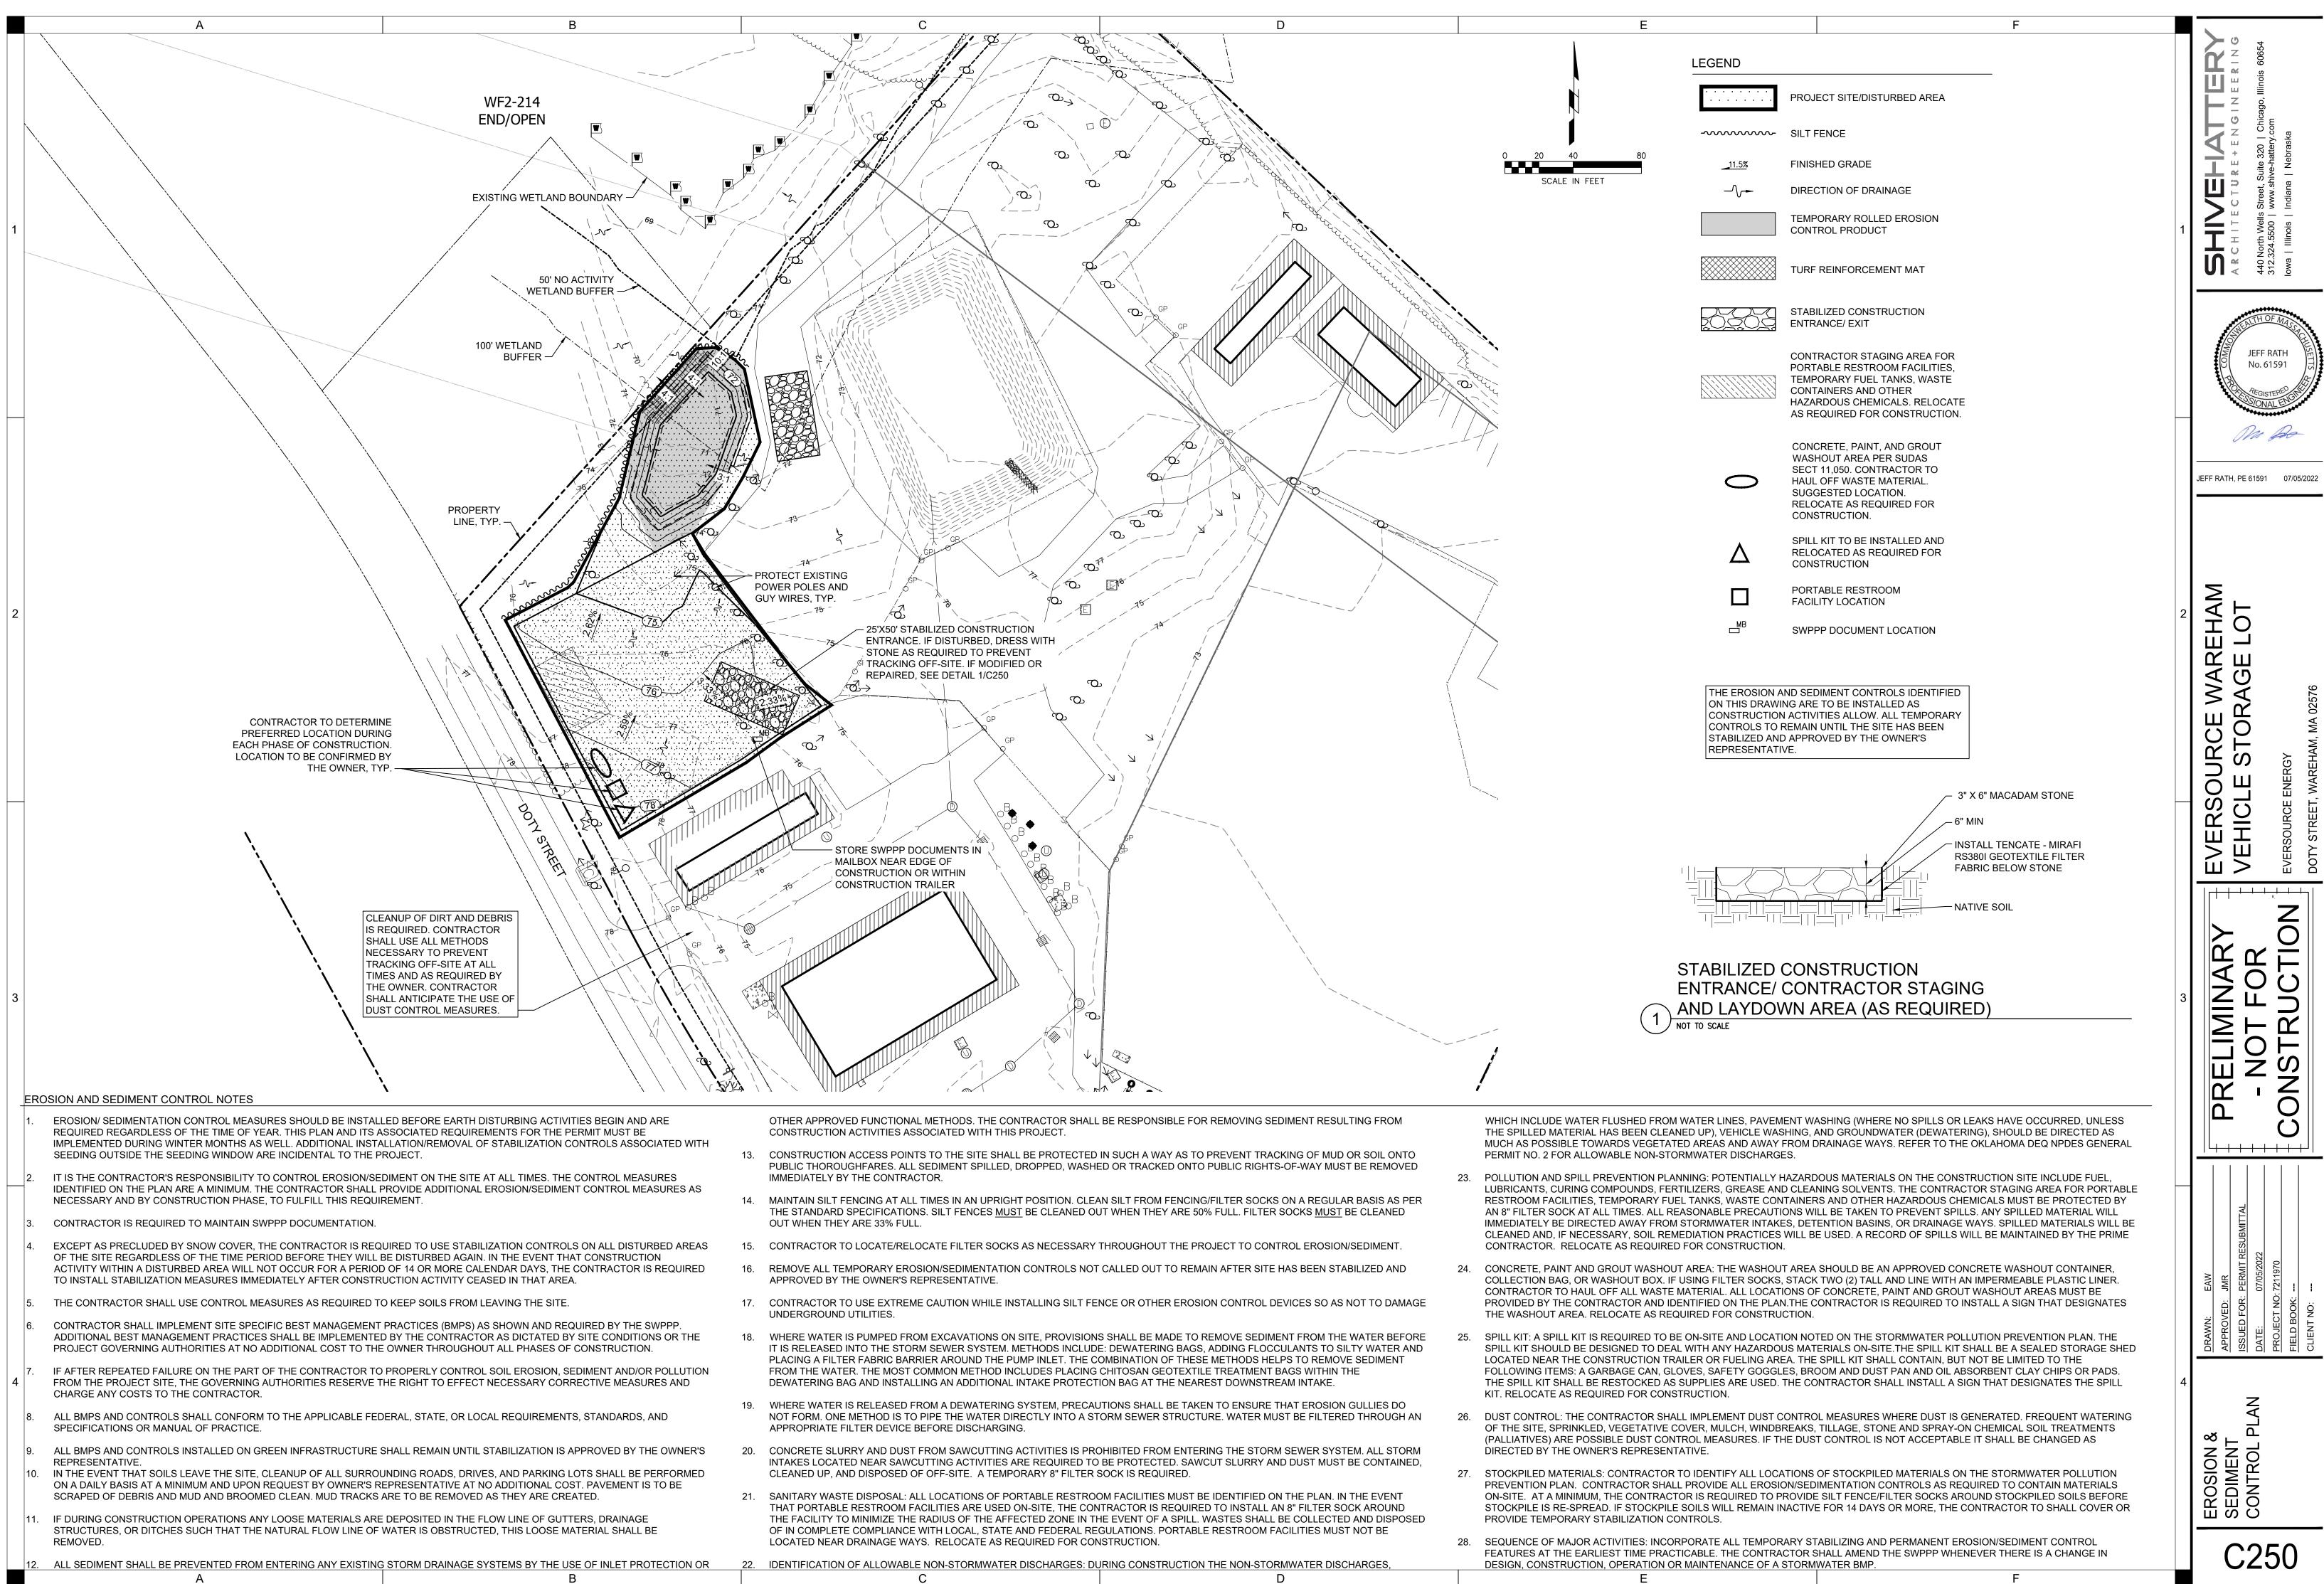SET ROOT BALL CROWN 2" HIGHER THAN GRADE. EACH TREE MUST BE PLANTED SUCH THAT THE TRUNK FLARE IS VISIBLE AT THE TOP OF THE ROOT BALL.
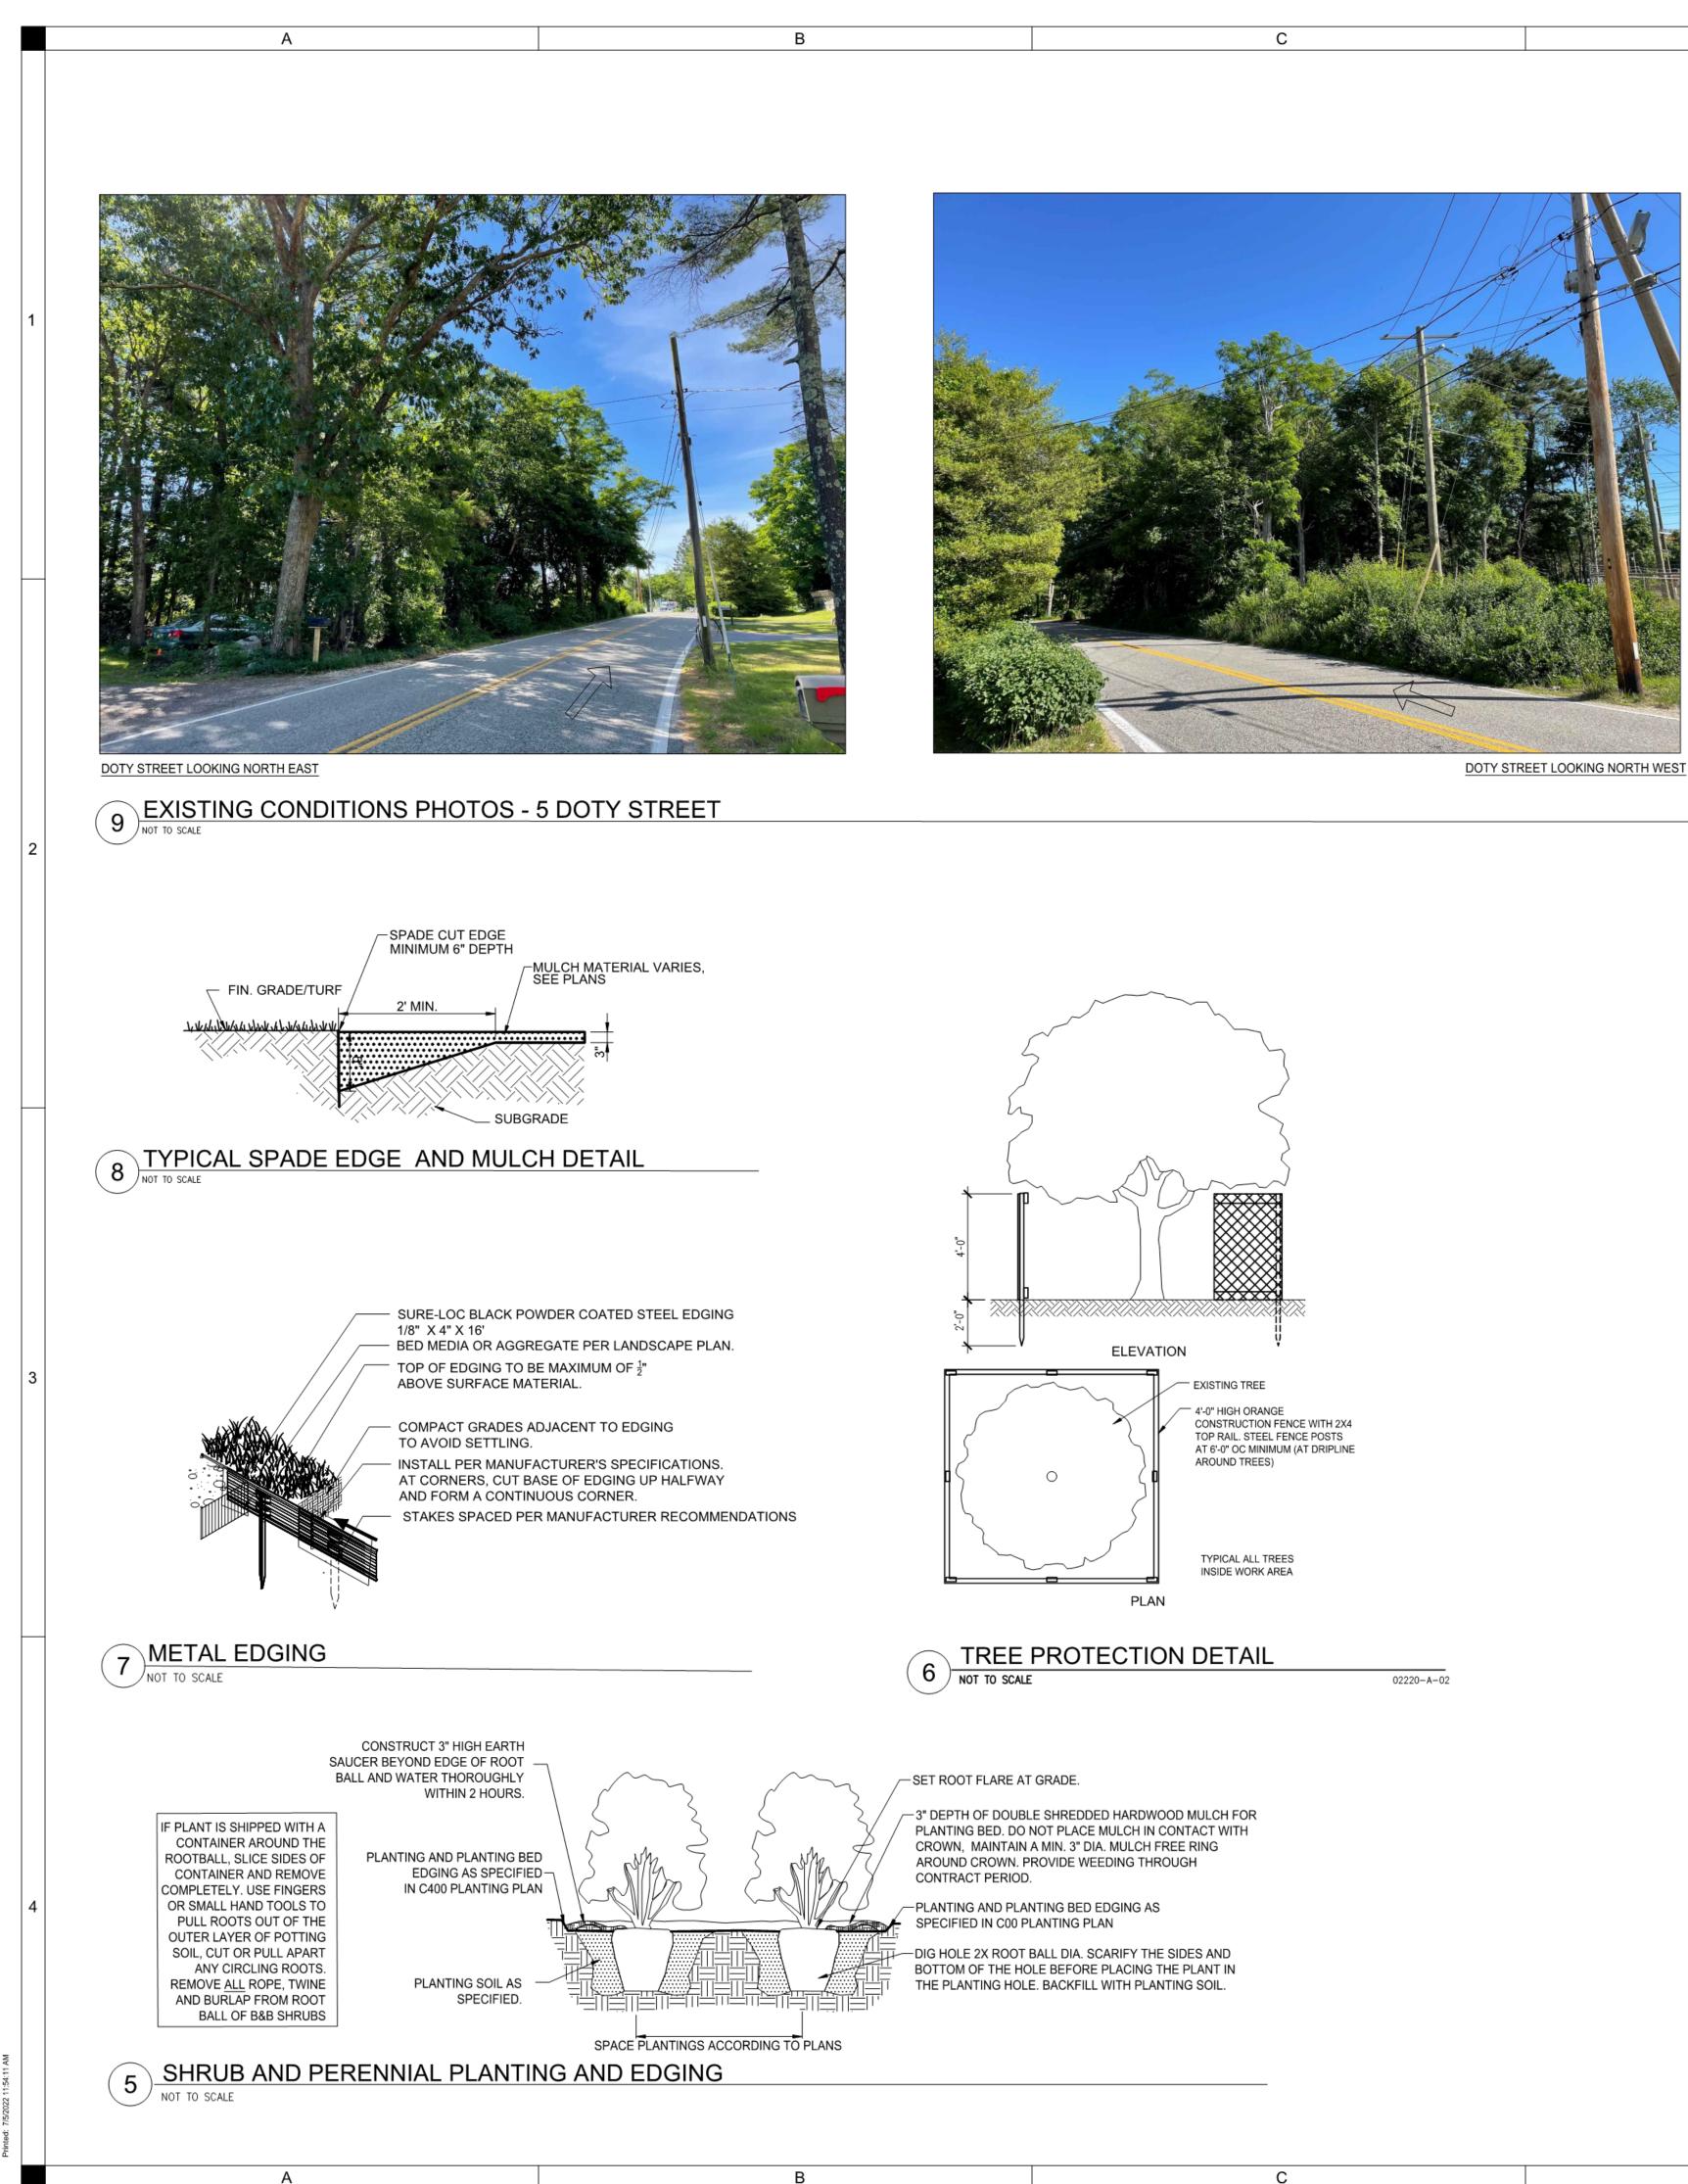
> TAMP SOIL AROUND ROOT BALL BASE FIRMLY WITH FOOT PRESSURE SO THAT -ROOT BALL DOES NOT SHIFT. 3" DEPTH DOUBLE SHREDDED HARDWOOD MULCH RING PULLED BACK 6" FROM TRUNK -BASE

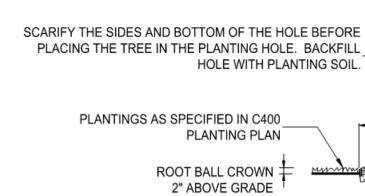SCARIFY THE SIDES AND BOTTOM OF THE HOLE BEFORE PLACING THE TREE IN THE PLANTING HOLE. BACKFILL HOLE-WITH PLANTING SOIL.


> ROOT BALL CROWN 🛨 2" ABOVE GRADE



PLANTING NOTE:

DURING ESTABLISHMENT PERIOD THE CONTRACTOR SHALL PROVIDE WEEDING, ADJUSTMENT OF STAKES, REPAIR OF WATER SAUCERS AND WORK NECESSARY TO MAINTAIN PLANTS. WORK SHALL BE INCIDENTAL TO COST OF PLANTS.



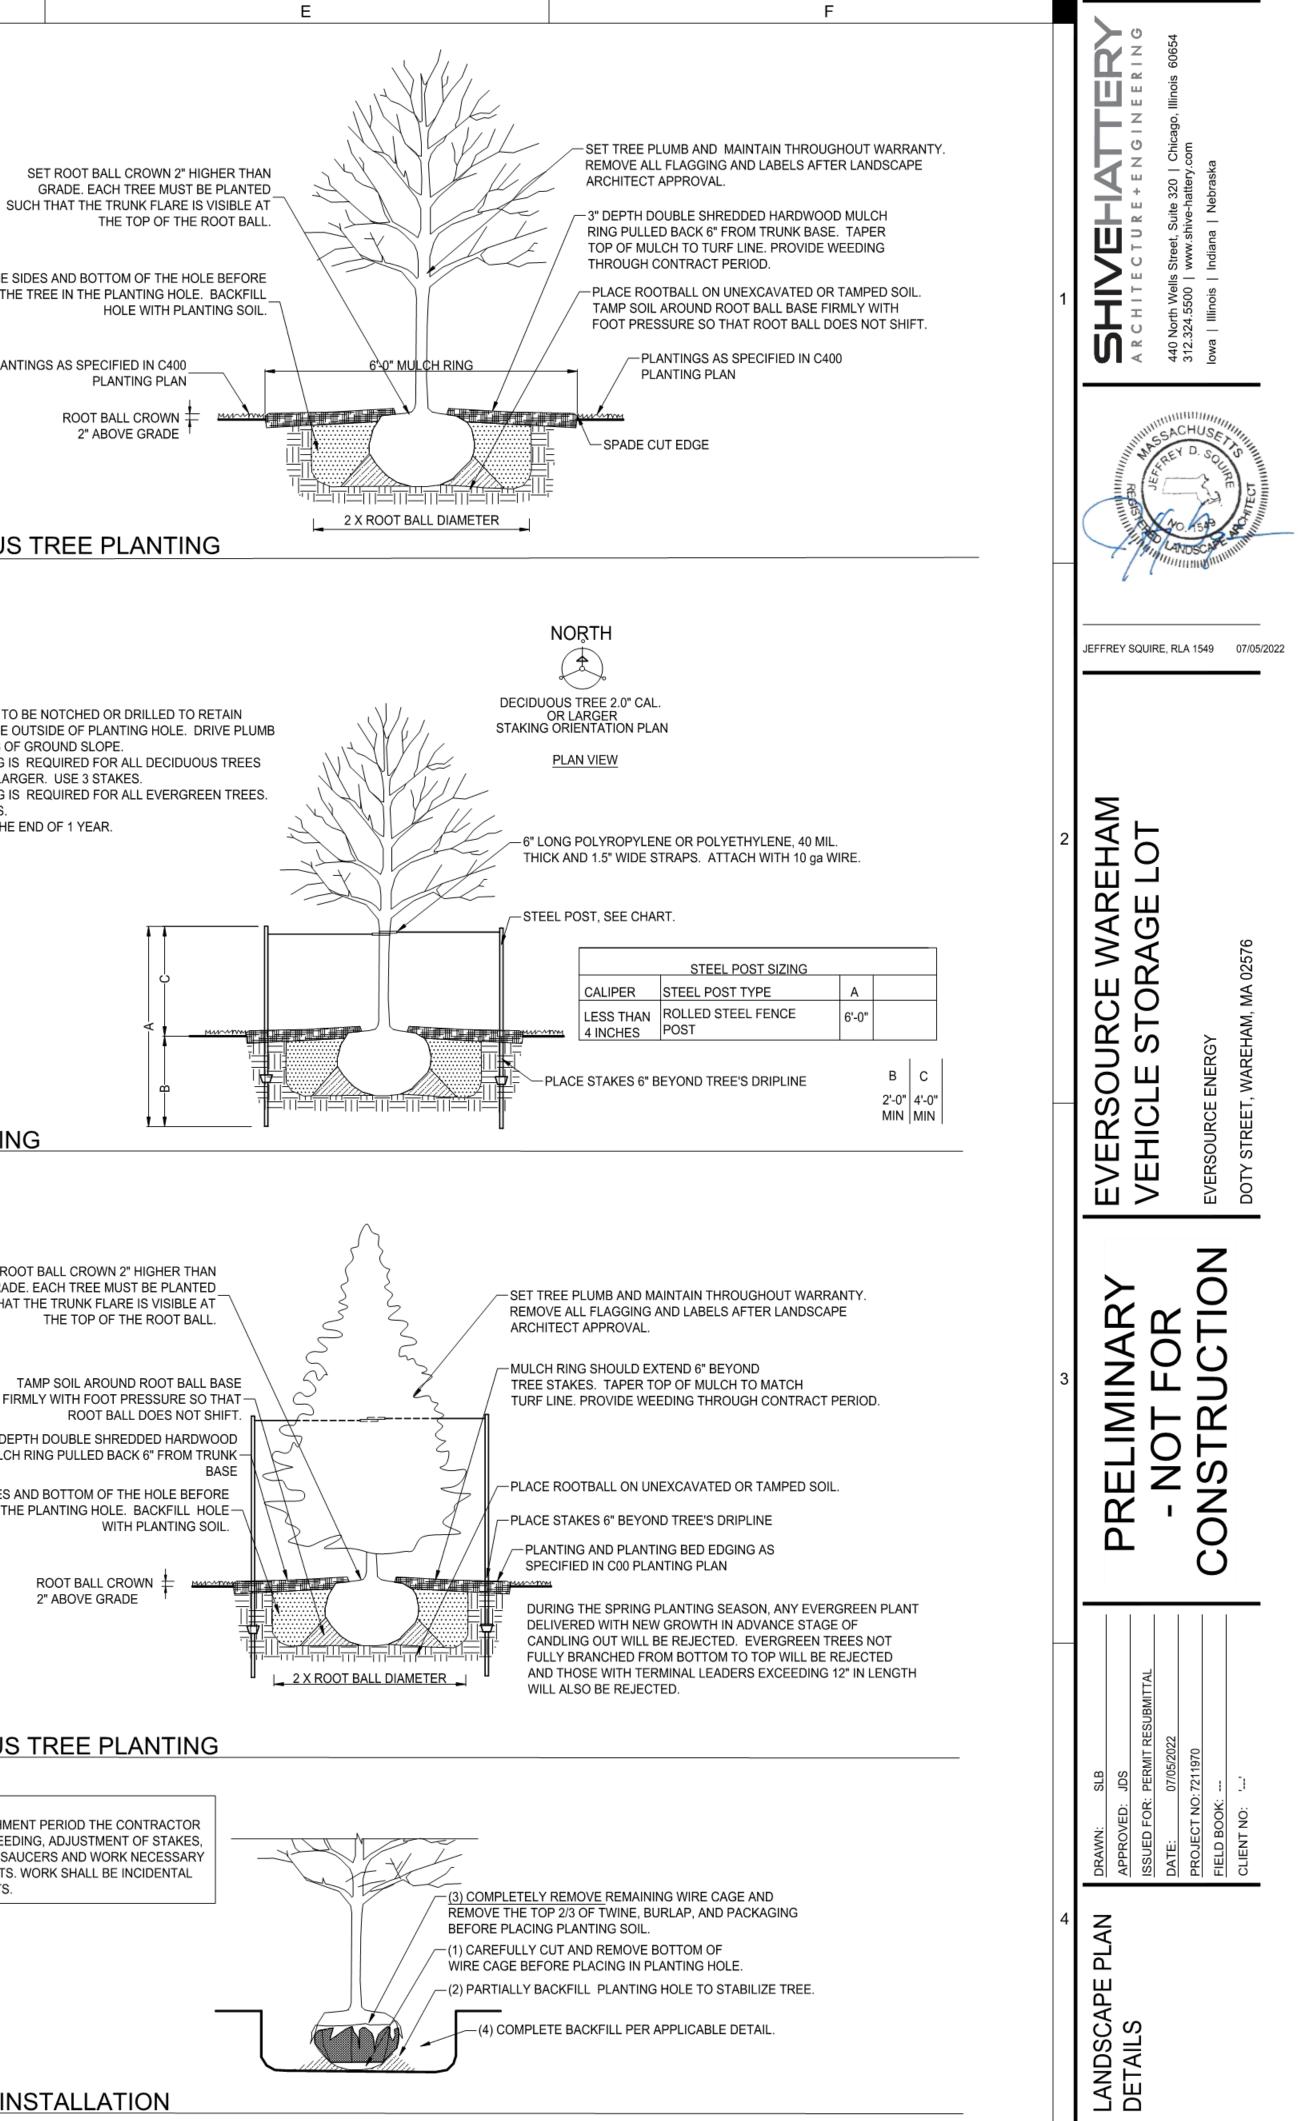

C402