

MODIFICATION TO SPECIAL USE PERMIT & SITE PLAN APPROVAL & DEFINITIVE SUBDIVISION PLAN APPROVAL

DEFINITIVE PLAN SUBMISSION

BAY POINTE CLUB MIXED USE DEVELOPMENT PHASE II & III in WAREHAM, MASSACHUSETTS

OWNER / APPLICANT:

BAY POINTE CLUB, LLC C/O STONESTREET, CORP. 501 WAMPANOAG TRAIL, SUITE 400 EAST PROVIDENCE, RHODE ISLAND 02915 401.433.6900



PREPARED BY:

PRINCIPE COMPANY, INC.

ENGINEERING DIVISION

APRIL 4, 2022

MAY 5, 2022

APRIL 22, 2022

PO BOX 298 TIVERTON, RHODE ISLAND 02878 401.816.5385 PRINCIPEENGINEERING@GMAIL.COM DATE: MAY 26, 2021 REVISED: JULY 14, 2021 JULY 29, 2021 AUGUST 5, 2021 JANUARY 14, 2022 FEBRUARY 28, 2022 MARCH 15, 2022

SECTION VI, K. FIRE ALARMS (PAGE 23 OF 26- SUBDIVISION REGULATIONS) A FIRE ALARM CIRCUIT TO BE INSTALLED INCLUDING AT LEAST ONE (1) FIRE ALARM BOX FOR EACH 500FT OF STREET PER THE FIRE CHIEF PER NFPA STANDARDS.

BAY POINT WAIVERS FROM THE TOWN OF WAREHAM SUBDIVISION RULES & REGULATIONS

- FROM SEC. VI. G., BIT. CONC. SIDEWALK ON ONE SIDE OF ROAD GRANITE OR CONCRETE CURBS
- FROM SEC. V. C. 3. a., ROW WIDTH 40' INSTEAD OF 50' FROM SEC. VI. C. 6., REDUCE ROAD BASE MATERIAL THICKNESS FROM TWO 6" COURSES TO ONE 8" COURSE WHERE RECLAIMED ASPHALT IS USED

SEE SUBDIVISION PLAN APPROVAL DECISION IN BOOK 48972, PAGE 137. WITHOUT LIMITING THE GENERALITY THEREOF, SEE MINIMUM BUILDING SEPERATION CONDITION (CONDITION 17). SEE SITE PLAN AND SPECIAL PERMIT APPROVAL DECISION IN BOOK 48972 PAGE 147.

1) TITLE SHEET

LIST OF DRAWINGS

- 2) LOCUS MAP AT 2000 SCALE
- 3) EXISTING CONDITIONS SURVEY SHEET -A
- 4) EXISTING CONDITIONS SURVEY SHEET -B
- 5) EXISTING CONDITIONS SURVEY SHEET -C
- 6) LOT LAYOUT SHEET
- 7) GRADING PLAN KEY SHEET
- 8-9) GRADING PLANS
- 10) UTILITY PLAN KEY SHEET
- 11-12) UTILITY PLANS
- 13-15) ROADWAY PLAN & PROFILES
- 16-21) CONSTRUCTION DETAIL SHEETS
- R1-R3) REGISTRY PLANS (SUPPLEMENTAL PLAN SET)

NOTE:

ALL PROPOSED LOTS WITHIN THIS SUBDIVISION SHALL BE SERVED BY PUBLIC WATER AND SEWER SERVICES.

PHASING OF PROJECT:

PHASE II - STARBOARD DRIVE CONSTRUCTION AND 43 UNITS.


PHASE III - BEACON STREET CONSTRUCTION AND 13 UNITS.

FIRE DEPARTMENT NOTE:

THE FOLLOWING WAIVERS ARE REQUESTED, BASED ON A ROAD CLASSIFICATION UNDER V.C.1. AS "RESIDENTIAL STANDARD" OR "RESIDENTIAL COLLECTOR"

FROM SEC. VI. H., CAPE COD BERMS ON EACH SIDE INSTEAD OF VERTICAL

RECORDED DECISION REFERENCE:

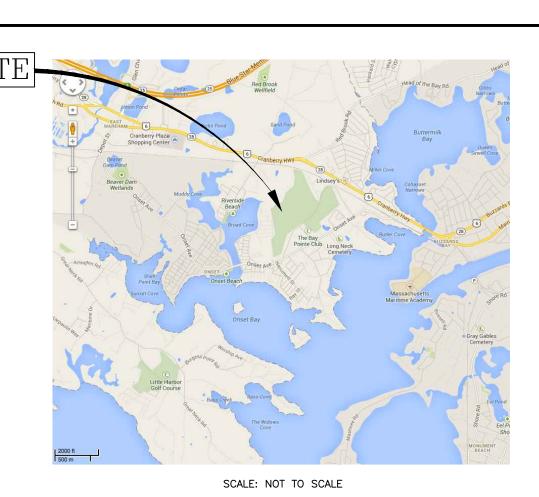

PLATS: 2, 8, 9 & 10 LOT: 1004A

PROJECT DATA:

NUMBER OF SINGLE FAMILY BUILDINGS: 16 (16 UNITS) NUMBER OF DUPLEX BUILDINGS: 16 (32 UNITS) NUMBER OF 8-UNIT BUILDINGS: 1 (8 UNITS)

NUMBER OF TOTAL DWELLING UNITS:

(REFER TO REGISTRY PLANS FOR LOT AREAS)

RESIDENTIAL "STANDARD" STREET REQUIREMENTS:

PHASE II & III: TOTAL LENGTH OF PROPOSED NEW ROADS

1,609 L.F. STARBOARD DRIVE 751 L.F. BEACON STREET

PAVEMENT WIDTH 22 FEET (STARBOARD) 22 FEET (BEACON)

WAIVERS REQUESTED

**BIT. CONC. SIDEWALK PROPOSED (ONE SIDE OF ROADS) **NEW STREETS TO HAVE CAPE COD BERMS **PRIVATE RIGHT OF WAY WIDTH TO BE 40 FT **ROAD GRADES LESS THAN MINIMUM OTHERWISE REQUIRED EXCEPT WHERE DEFINED ON APPROVED PLANS REDUCE BASE MATERIAL THICKNESS TO 8 INCHES WHERE RECLAIMED ASPHALT IS UTILIZED

ZONING CLASSIFICATION:

"CR" CONFERENCE RECREATIONAL & "MR-30" MULTIPLE RESIDENCE DISTRICT

PROPOSED BUILDING SETBACKS: FRONT: 12FT REAR: 10FT SIDE: 18FT *REFER TO THE AMENDED ZONING

BY-LAWS AS REVISED OCTOBER, 2018.

BY: V	VAREHAI	M PLANI	NING BO	ARD	
DATE	APPRO	VED: _			

DATE SIGNED:

HEREBY CERTIFY THAT THERE HAS BEEN NO APPEAL TAKEN TO THIS PLANNING BOARD ACTION DURING THE 20-DAY STATUTORY APPEAL PERIOD

TOWN CLERK - WAREHAM MASSACHUSETTS



FAX: 401.438.5773


PHONE: 401.333.2382


46 Sutton Avenue East Providence, RI Phone: (401) - 438 - 5775 Fax: (401) - 438 - 5773 www.watermanengineering.net

EXISTING CONDITIONS AND PROPERTY LINE SURVEY BY: RICHARD LIPSITZ, PLS WARTERMAN ENGINEERING COMPANY 46 SUTTON AVENUE EAST PROVIDENCE, RHODE ISLAND 02914 PHONE: 401.438.5775


LANDSCAPE ARCHITECURE BY: DONALD LEIGHTON, ASLA BETA GROUP: GLA LANDSCAPE DIVISION 6 BALCKSTONE PLACE LINCOLN, RI 02865

GOLF COURSE ARCHITECURE BY: TIM GERRISH GARDNER & GERRISH LANDSCAPE ARCHITECTS, LLC 192 WENTWORTH AVENUE EDGEWOOD, RI 02905 PHONE: 401.263.7106

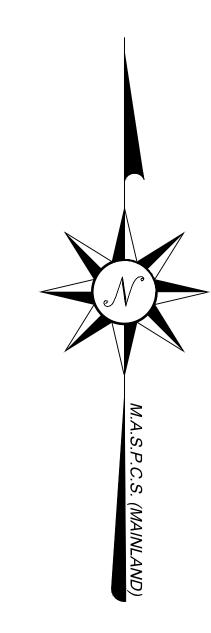


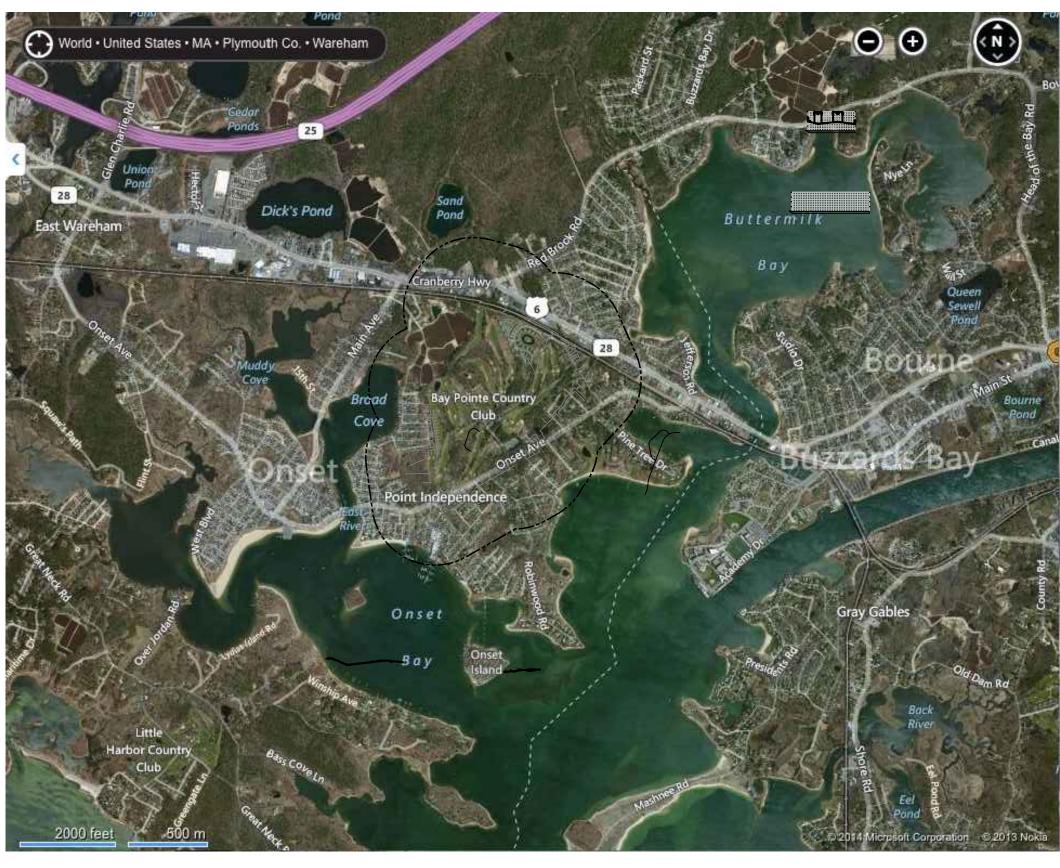


QUARTER MILE RADIUS

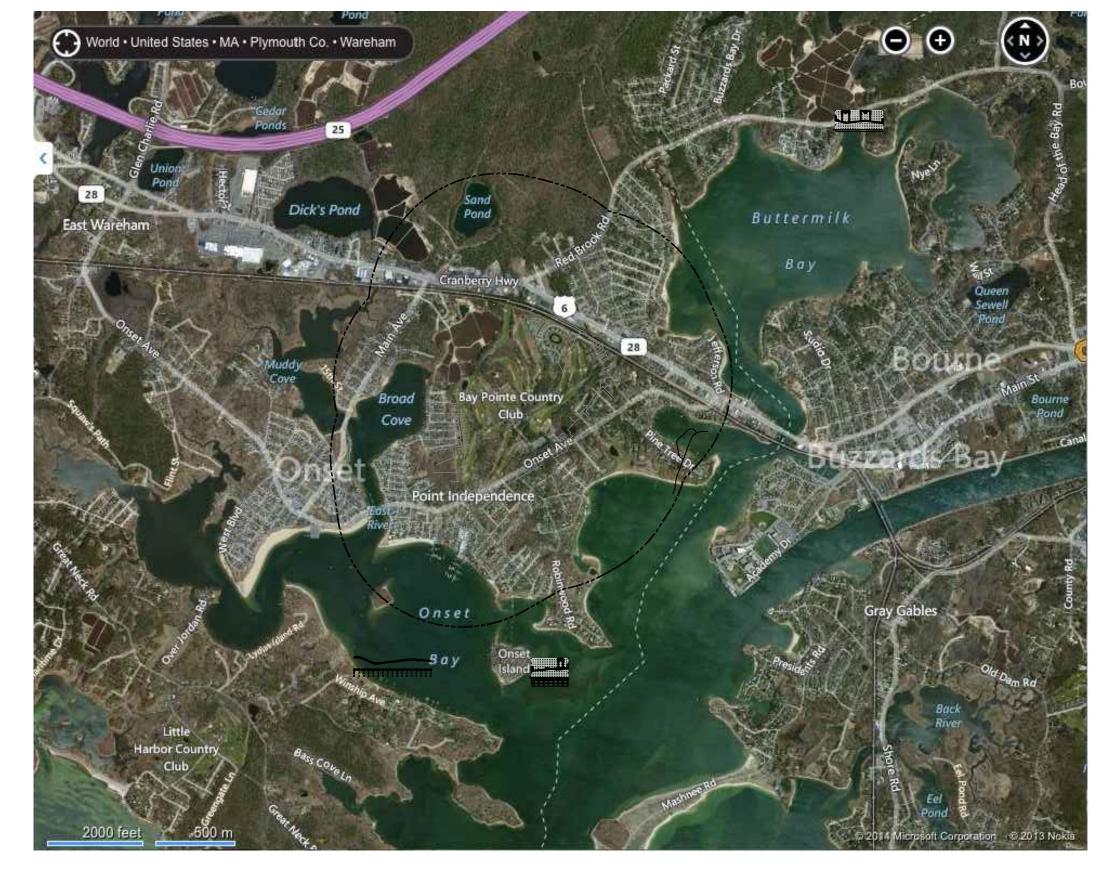

HALF MILE RADIUS

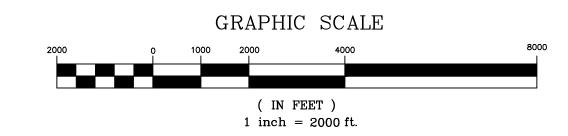

AERIAL OVERLAY RADIUS LOCUS

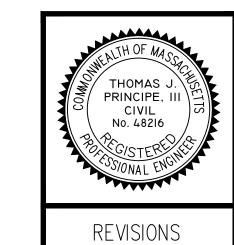

3. 8-5-21 MNG TJP


PRINCIPE COMPANY, INC. ENGINEERING DIVISION

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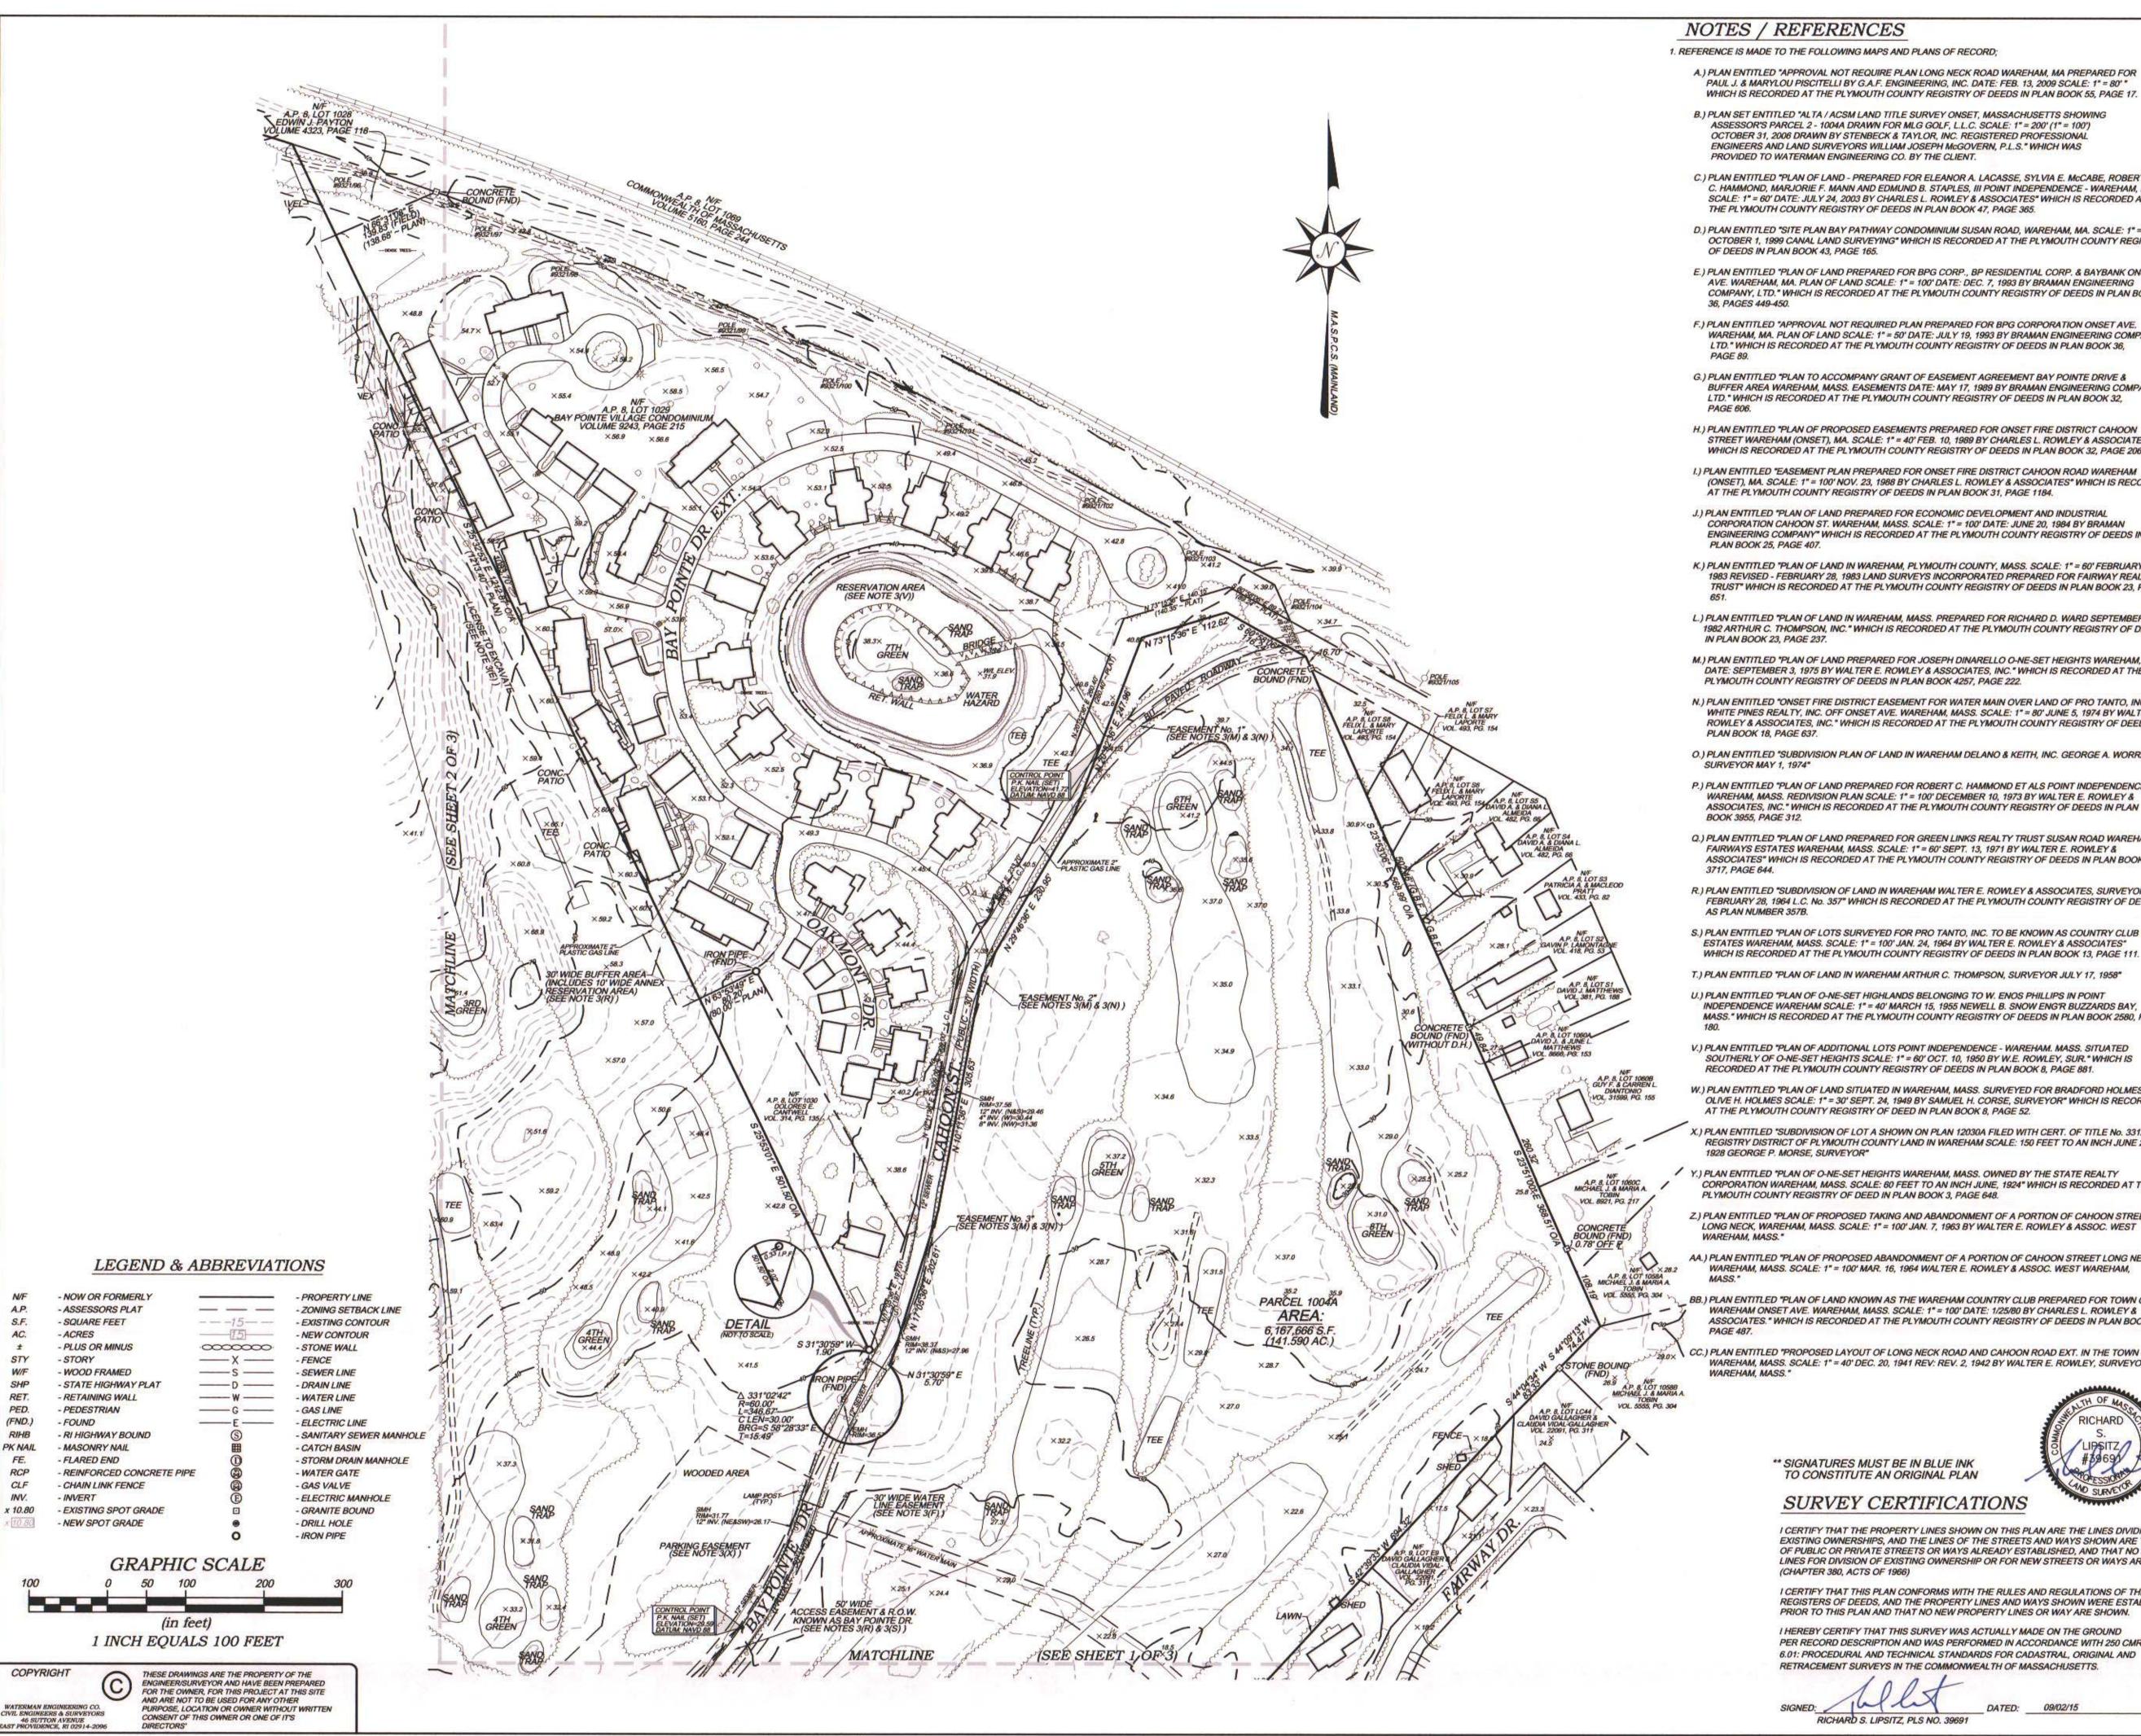
MODIFICATION TO SPECIAL USE PERMIT & SITE PLAN APPROVAL & DEFINITIVE SUBDIVISION PLAN APPROVAL DEFINITIVE PLAN SUBMISSION

BAY POINTE CLUB MIXED USE DEVELOPMENT PHASE II & III in WAREHAM, MASSACHUSETTS

	SCALE: 1"=2,000'		SHEET NO	o: 2 OF 21
	DRAWN BY: TJP	DESIGN I	BY: TJP	CHECKED BY: TJP
T	DATE: 5/26/21		PROJECT	NO.: LD13-1 PH II/III



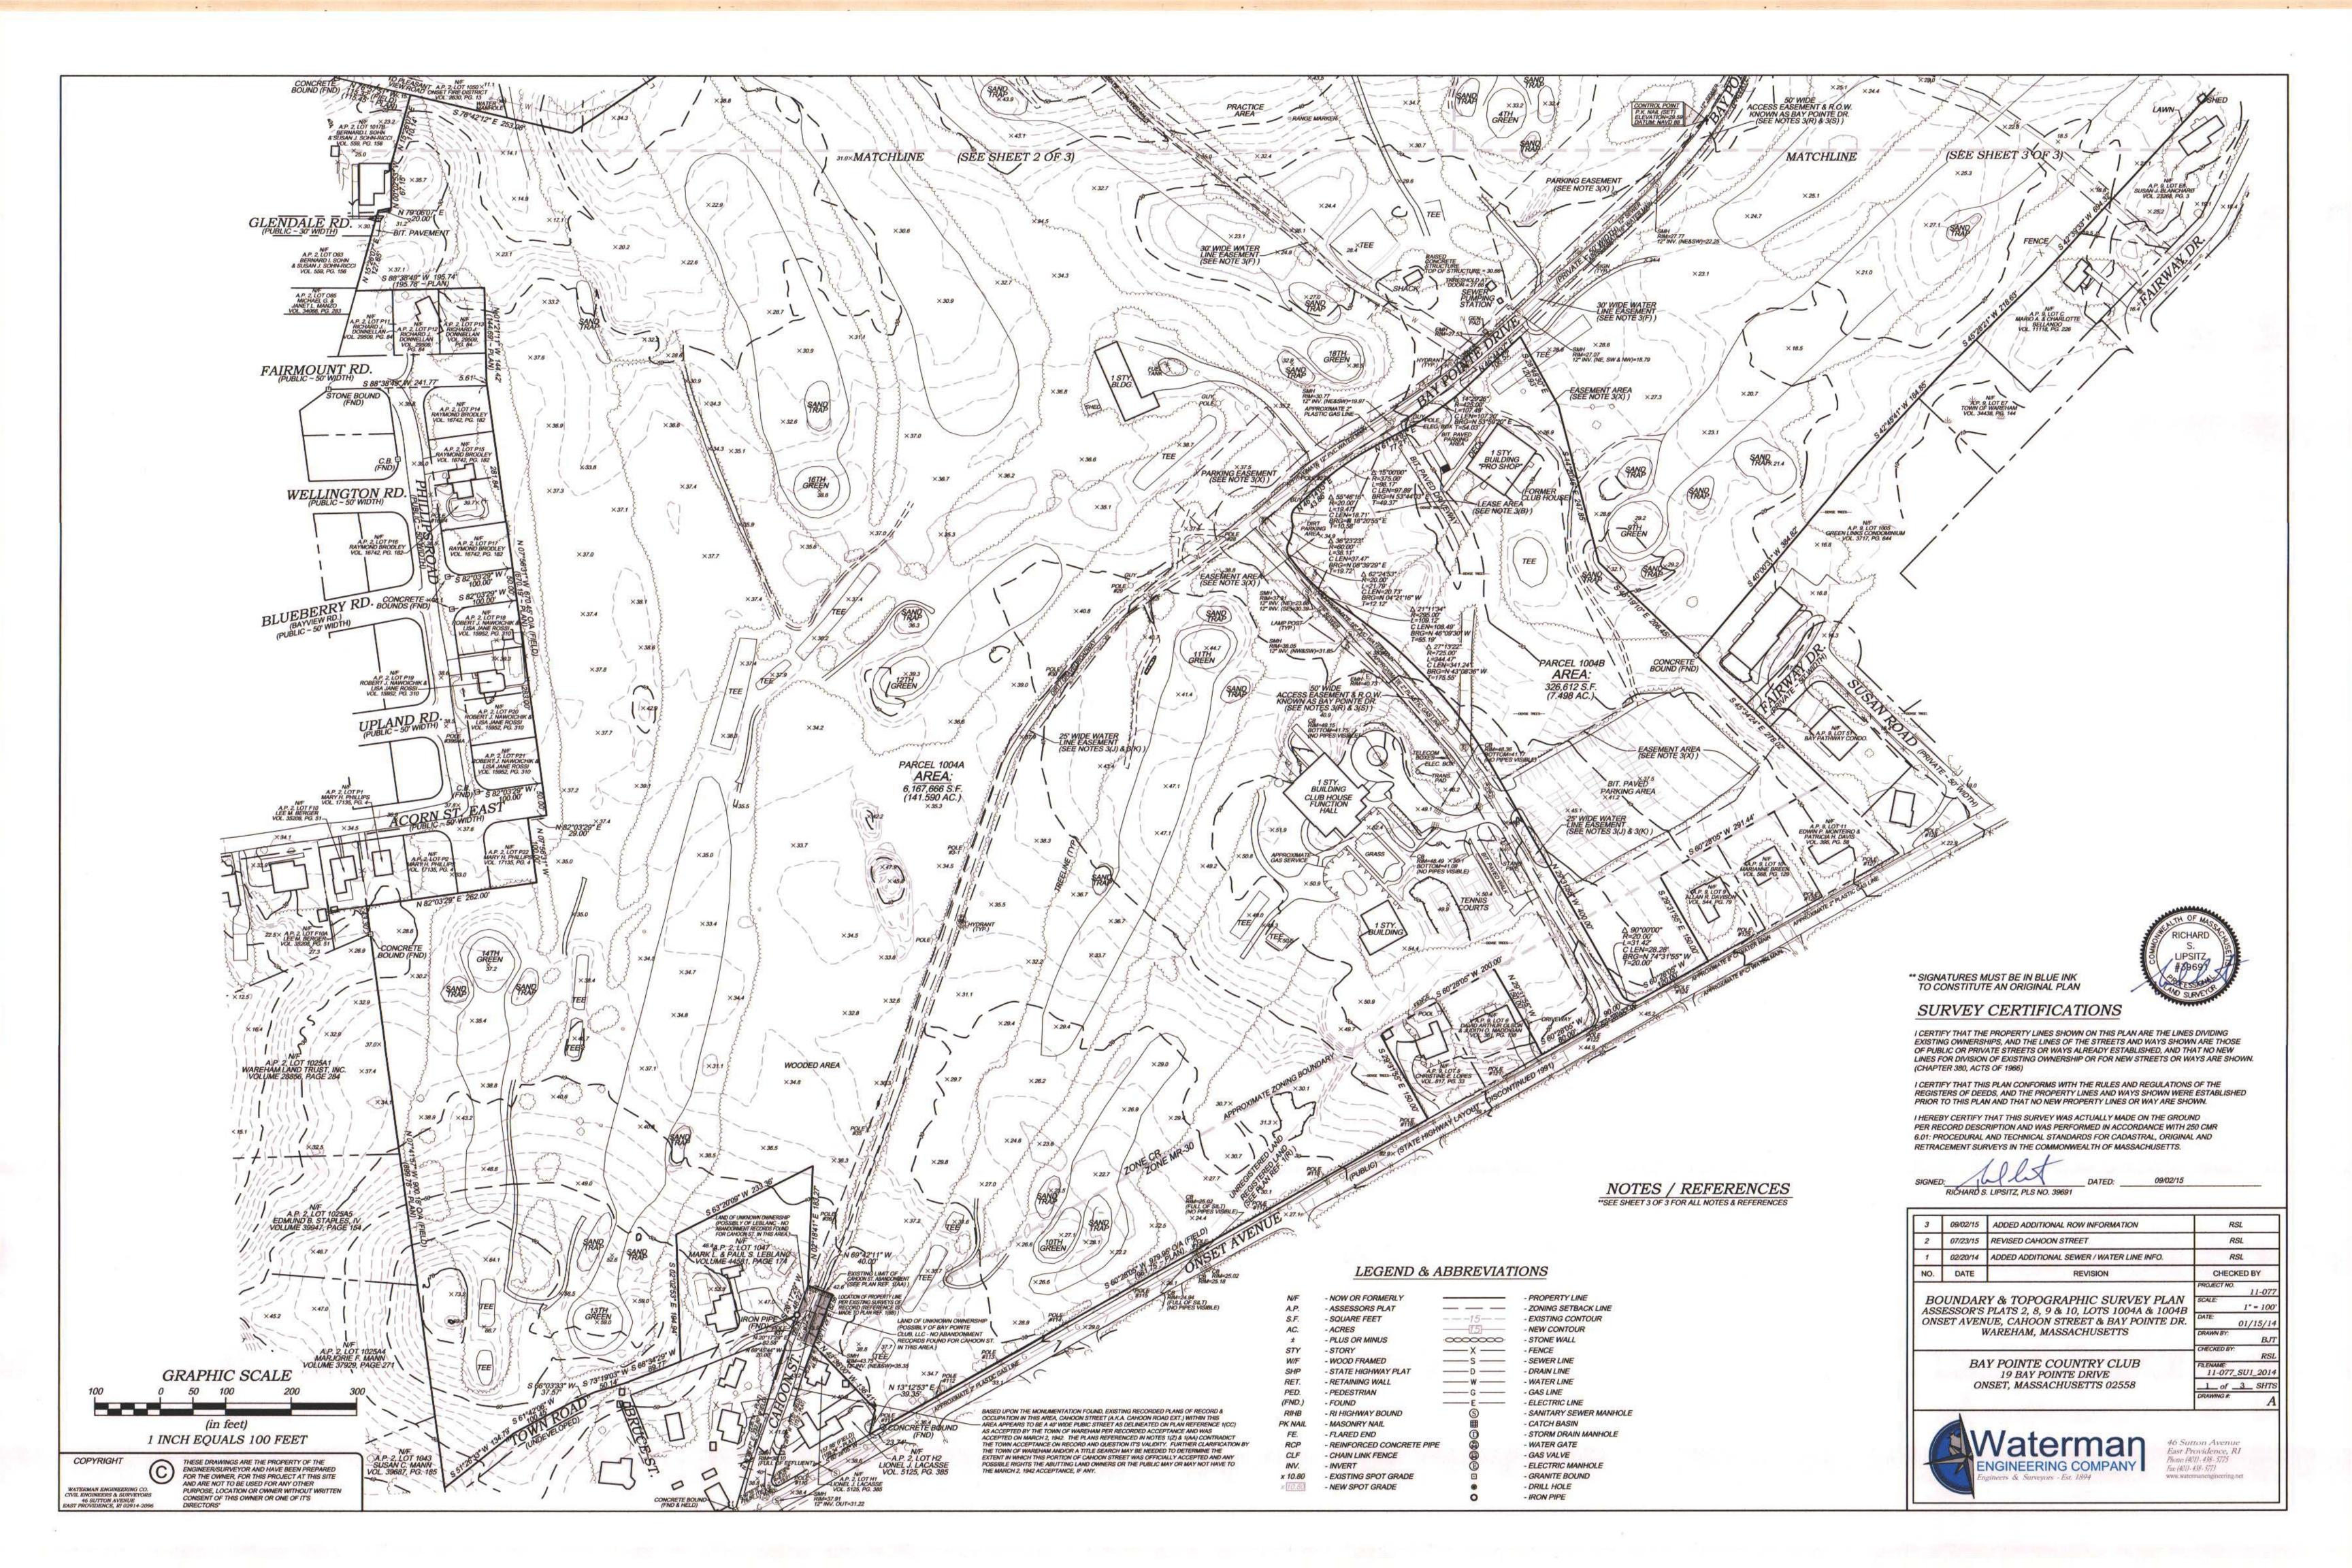



NOTES / REFERENCES

- 1. REFERENCE IS MADE TO THE FOLLOWING MAPS AND PLANS OF RECORD;
- A.) PLAN ENTITLED "APPROVAL NOT REQUIRE PLAN LONG NECK ROAD WAREHAM, MA PREPARED FOR PAUL J. & MARYLOU PISCITELLI BY G.A.F. ENGINEERING, INC. DATE: FEB. 13, 2009 SCALE: 1" = 80" WHICH IS RECORDED AT THE PLYMOUTH COUNTY REGISTRY OF DEEDS IN PLAN BOOK 55, PAGE 17.
- B.) PLAN SET ENTITLED "ALTA / ACSM LAND TITLE SURVEY ONSET, MASSACHUSETTS SHOWING ASSESSOR'S PARCEL 2 - 1004A DRAWN FOR MLG GOLF, L.L.C. SCALE: 1" = 200' (1" = 100') OCTOBER 31, 2006 DRAWN BY STENBECK & TAYLOR, INC. REGISTERED PROFESSIONAL ENGINEERS AND LAND SURVEYORS WILLIAM JOSEPH McGOVERN, P.L.S." WHICH WAS PROVIDED TO WATERMAN ENGINEERING CO. BY THE CLIENT.
- C.) PLAN ENTITLED "PLAN OF LAND PREPARED FOR ELEANOR A. LACASSE, SYLVIA E. McCABE, ROBERT C. HAMMOND, MARJORIE F. MANN AND EDMUND B. STAPLES, III POINT INDEPENDENCE - WAREHAM, MA. SCALE: 1" = 60' DATE: JULY 24, 2003 BY CHARLES L. ROWLEY & ASSOCIATES" WHICH IS RECORDED AT
- THE PLYMOUTH COUNTY REGISTRY OF DEEDS IN PLAN BOOK 47, PAGE 365. D.) PLAN ENTITLED "SITE PLAN BAY PATHWAY CONDOMINIUM SUSAN ROAD, WAREHAM, MA. SCALE: 1" = 20" OCTOBER 1, 1999 CANAL LAND SURVEYING" WHICH IS RECORDED AT THE PLYMOUTH COUNTY REGISTRY
- E.) PLAN ENTITLED "PLAN OF LAND PREPARED FOR BPG CORP., BP RESIDENTIAL CORP. & BAYBANK ONSET AVE. WAREHAM, MA. PLAN OF LAND SCALE: 1" = 100" DATE: DEC. 7, 1993 BY BRAMAN ENGINEERING COMPANY, LTD." WHICH IS RECORDED AT THE PLYMOUTH COUNTY REGISTRY OF DEEDS IN PLAN BOOK 36, PAGES 449-450.
- F.) PLAN ENTITLED "APPROVAL NOT REQUIRED PLAN PREPARED FOR BPG CORPORATION ONSET AVE. WAREHAM. MA. PLAN OF LAND SCALE: 1" = 50' DATE: JULY 19, 1993 BY BRAMAN ENGINEERING COMPANY, LTD." WHICH IS RECORDED AT THE PLYMOUTH COUNTY REGISTRY OF DEEDS IN PLAN BOOK 36,
- G.) PLAN ENTITLED "PLAN TO ACCOMPANY GRANT OF EASEMENT AGREEMENT BAY POINTE DRIVE & BUFFER AREA WAREHAM, MASS. EASEMENTS DATE: MAY 17, 1989 BY BRAMAN ENGINEERING COMPANY, LTD." WHICH IS RECORDED AT THE PLYMOUTH COUNTY REGISTRY OF DEEDS IN PLAN BOOK 32,
- H.) PLAN ENTITLED "PLAN OF PROPOSED EASEMENTS PREPARED FOR ONSET FIRE DISTRICT CAHOON STREET WAREHAM (ONSET), MA. SCALE: 1" = 40' FEB. 10, 1989 BY CHARLES L. ROWLEY & ASSOCIATES" WHICH IS RECORDED AT THE PLYMOUTH COUNTY REGISTRY OF DEEDS IN PLAN BOOK 32, PAGE 206.
- I.) PLAN ENTITLED "EASEMENT PLAN PREPARED FOR ONSET FIRE DISTRICT CAHOON ROAD WAREHAM (ONSET), MA. SCALE: 1" = 100' NOV. 23, 1988 BY CHARLES L. ROWLEY & ASSOCIATES" WHICH IS RECORDED
- J.) PLAN ENTITLED "PLAN OF LAND PREPARED FOR ECONOMIC DEVELOPMENT AND INDUSTRIAL CORPORATION CAHOON ST. WAREHAM, MASS. SCALE: 1" = 100' DATE: JUNE 20, 1984 BY BRAMAN ENGINEERING COMPANY" WHICH IS RECORDED AT THE PLYMOUTH COUNTY REGISTRY OF DEEDS IN
- K.) PLAN ENTITLED "PLAN OF LAND IN WAREHAM, PLYMOUTH COUNTY, MASS. SCALE: 1" = 60' FEBRUARY 12, 1983 REVISED - FEBRUARY 28, 1983 LAND SURVEYS INCORPORATED PREPARED FOR FAIRWAY REALTY TRUST" WHICH IS RECORDED AT THE PLYMOUTH COUNTY REGISTRY OF DEEDS IN PLAN BOOK 23, PAGE
- L.) PLAN ENTITLED "PLAN OF LAND IN WAREHAM, MASS. PREPARED FOR RICHARD D. WARD SEPTEMBER 21, 1982 ARTHUR C. THOMPSON, INC." WHICH IS RECORDED AT THE PLYMOUTH COUNTY REGISTRY OF DEEDS IN PLAN BOOK 23, PAGE 237.
- M.) PLAN ENTITLED "PLAN OF LAND PREPARED FOR JOSEPH DINARELLO O-NE-SET HEIGHTS WAREHAM, MASS. DATE: SEPTEMBER 3, 1975 BY WALTER E. ROWLEY & ASSOCIATES, INC." WHICH IS RECORDED AT THE PLYMOUTH COUNTY REGISTRY OF DEEDS IN PLAN BOOK 4257, PAGE 222.
- N.) PLAN ENTITLED "ONSET FIRE DISTRICT EASEMENT FOR WATER MAIN OVER LAND OF PRO TANTO, INC. & WHITE PINES REALTY, INC. OFF ONSET AVE. WAREHAM, MASS. SCALE: 1" = 80" JUNE 5, 1974 BY WALTER E. ROWLEY & ASSOCIATES, INC." WHICH IS RECORDED AT THE PLYMOUTH COUNTY REGISTRY OF DEEDS IN PLAN BOOK 18, PAGE 637.
- O.) PLAN ENTITLED "SUBDIVISION PLAN OF LAND IN WAREHAM DELANO & KEITH, INC. GEORGE A. WORRALL, SURVEYOR MAY 1, 1974"
- P.) PLAN ENTITLED "PLAN OF LAND PREPARED FOR ROBERT C. HAMMOND ET ALS POINT INDEPENDENCE WAREHAM, MASS. REDIVISION PLAN SCALE: 1" = 100' DECEMBER 10, 1973 BY WALTER E. ROWLEY & ASSOCIATES, INC." WHICH IS RECORDED AT THE PLYMOUTH COUNTY REGISTRY OF DEEDS IN PLAN BOOK 3955, PAGE 312.
- Q.) PLAN ENTITLED "PLAN OF LAND PREPARED FOR GREEN LINKS REALTY TRUST SUSAN ROAD WAREHAM FAIRWAYS ESTATES WAREHAM, MASS. SCALE: 1" = 60' SEPT. 13, 1971 BY WALTER E. ROWLEY & ASSOCIATES" WHICH IS RECORDED AT THE PLYMOUTH COUNTY REGISTRY OF DEEDS IN PLAN BOOK
- R.) PLAN ENTITLED "SUBDIVISION OF LAND IN WAREHAM WALTER E. ROWLEY & ASSOCIATES, SURVEYORS FEBRUARY 28, 1964 L.C. No. 357" WHICH IS RECORDED AT THE PLYMOUTH COUNTY REGISTRY OF DEEDS AS PLAN NUMBER 357B
- S.) PLAN ENTITLED "PLAN OF LOTS SURVEYED FOR PRO TANTO, INC. TO BE KNOWN AS COUNTRY CLUB ESTATES WAREHAM, MASS. SCALE: 1" = 100' JAN. 24, 1964 BY WALTER E. ROWLEY & ASSOCIATES"
- T.) PLAN ENTITLED "PLAN OF LAND IN WAREHAM ARTHUR C. THOMPSON, SURVEYOR JULY 17, 1958"
- U.) PLAN ENTITLED "PLAN OF O-NE-SET HIGHLANDS BELONGING TO W. ENOS PHILLIPS IN POINT INDEPENDENCE WAREHAM SCALE: 1" = 40' MARCH 15, 1955 NEWELL B. SNOW ENG'R BUZZARDS BAY, MASS." WHICH IS RECORDED AT THE PLYMOUTH COUNTY REGISTRY OF DEEDS IN PLAN BOOK 2580, PAGE
- V.) PLAN ENTITLED "PLAN OF ADDITIONAL LOTS POINT INDEPENDENCE WAREHAM. MASS, SITUATED SOUTHERLY OF O-NE-SET HEIGHTS SCALE: 1" = 60' OCT. 10. 1950 BY W.E. ROWLEY, SUR. "WHICH IS RECORDED AT THE PLYMOUTH COUNTY REGISTRY OF DEEDS IN PLAN BOOK 8, PAGE 881.
- W.) PLAN ENTITLED "PLAN OF LAND SITUATED IN WAREHAM, MASS. SURVEYED FOR BRADFORD HOLMES AND OLIVE H. HOLMES SCALE: 1" = 30' SEPT. 24, 1949 BY SAMUEL H. CORSE, SURVEYOR" WHICH IS RECORDED AT THE PLYMOUTH COUNTY REGISTRY OF DEED IN PLAN BOOK 8, PAGE 52.
- X.) PLAN ENTITLED "SUBDIVISION OF LOT A SHOWN ON PLAN 12030A FILED WITH CERT. OF TITLE No. 3312 REGISTRY DISTRICT OF PLYMOUTH COUNTY LAND IN WAREHAM SCALE: 150 FEET TO AN INCH JUNE 20, 1928 GEORGE P. MORSE, SURVEYOR"
- Y.) PLAN ENTITLED "PLAN OF O-NE-SET HEIGHTS WAREHAM, MASS. OWNED BY THE STATE REALTY CORPORATION WAREHAM, MASS. SCALE: 60 FEET TO AN INCH JUNE, 1924" WHICH IS RECORDED AT THE PLYMOUTH COUNTY REGISTRY OF DEED IN PLAN BOOK 3. PAGE 648
- Z.) PLAN ENTITLED "PLAN OF PROPOSED TAKING AND ABANDONMENT OF A PORTION OF CAHOON STREET LONG NECK, WAREHAM, MASS. SCALE: 1" = 100' JAN. 7, 1963 BY WALTER E. ROWLEY & ASSOC. WEST
- AA.) PLAN ENTITLED "PLAN OF PROPOSED ABANDONMENT OF A PORTION OF CAHOON STREET LONG NECK, WAREHAM, MASS. SCALE: 1" = 100' MAR. 16, 1964 WALTER E. ROWLEY & ASSOC. WEST WAREHAM,
- BB.) PLAN ENTITLED "PLAN OF LAND KNOWN AS THE WAREHAM COUNTRY CLUB PREPARED FOR TOWN OF WAREHAM ONSET AVE. WAREHAM, MASS. SCALE: 1" = 100" DATE: 1/25/80 BY CHARLES L. ROWLEY & ASSOCIATES." WHICH IS RECORDED AT THE PLYMOUTH COUNTY REGISTRY OF DEEDS IN PLAN BOOK 21,
- CC.) PLAN ENTITLED "PROPOSED LAYOUT OF LONG NECK ROAD AND CAHOON ROAD EXT. IN THE TOWN OF WAREHAM, MASS. SCALE: 1" = 40' DEC. 20, 1941 REV: REV. 2, 1942 BY WALTER E. ROWLEY, SURVEYOR

** SIGNATURES MUST BE IN BLUE INK TO CONSTITUTE AN ORIGINAL PLAN

SURVEY CERTIFICATIONS

I CERTIFY THAT THE PROPERTY LINES SHOWN ON THIS PLAN ARE THE LINES DIVIDING EXISTING OWNERSHIPS, AND THE LINES OF THE STREETS AND WAYS SHOWN ARE THOSE OF PUBLIC OR PRIVATE STREETS OR WAYS ALREADY ESTABLISHED. AND THAT NO NEW LINES FOR DIVISION OF EXISTING OWNERSHIP OR FOR NEW STREETS OR WAYS ARE SHOWN.

I CERTIFY THAT THIS PLAN CONFORMS WITH THE RULES AND REGULATIONS OF THE REGISTERS OF DEEDS, AND THE PROPERTY LINES AND WAYS SHOWN WERE ESTABLISHED PRIOR TO THIS PLAN AND THAT NO NEW PROPERTY LINES OR WAY ARE SHOWN.

I HEREBY CERTIFY THAT THIS SURVEY WAS ACTUALLY MADE ON THE GROUND PER RECORD DESCRIPTION AND WAS PERFORMED IN ACCORDANCE WITH 250 CMR 6.01: PROCEDURAL AND TECHNICAL STANDARDS FOR CADASTRAL, ORIGINAL AND RETRACEMENT SURVEYS IN THE COMMONWEALTH OF MASSACHUSETTS.

NOTES / REFERENCES (cont.)

- 2. REFERENCE IS MADE TO THE FOLLOWING PLYMOUTH COUNTY REGISTRY OF DEEDS LAND EVIDENCE RECORDS REGARDING RECORDED TITLE TO THE PREMISES SURVEYED:
- A.) A.P. 2, 8, 9 & 10 ~ LOT 1004A ~ BAY POINTE CLUB, LLC ~ VOLUME 40976, PAGE 207
- B.) A.P. 2, 8, 9 & 10 ~ LOT 1004B ~ WAREHAM ECONOMIC DEVELOPMENT AND INDUSTRIAL CORPORATION ~ VOLUME 12524, PAGE 32
- 3. THESE PREMISES MAY BE SUBJECT TO / BENEFITED BY THE FOLLOWING EASEMENTS, RIGHTS OF WAY OR AGREEMENTS OF RECORD AS REFERENCED IN UNITED GENERAL TITLE INSURANCE COMPANY'S COMMITMENT FOR TITLE INSURANCE POLICY NUMBER 63675203 DATED: NOVEMBER 3, 2006 AND POLICY NUMBER 63675204 DATED: DECEMBER 1, 2006 REGARDING THE SUBJECT PROPERTY::
- A.) NOTICE OF LEASE REGARDING LEASE BETWEEN BUZZARDS BAY GOLF, INC. AND BAY POINTE COUNTRY CLUB, INC. AS RECORDED IN VOLUME 24409, PAGE 129. (NOT PLOTTABLE)
- B.) ASSIGNMENT OF LEASE AND RIGHTS IN AND TO THE LEASEHOLD PREMISES AS DESCRIBED IN VOLUME 22075, PAGE 246 AND VOLUME 22075, PAGE 243, AS AMENDED BY VOLUME 33358, PAGE
- C.) RIGHTS OF ONSET FIRE DISTRICT TO PROTECT AND MAINTAIN A 18" WATER MAIN FROM THE STORAGE TANK TO PLEASANT VIEW ROAD AS DESCRIBED IN VOLUME 2630, PAGE 13
- D.) RIGHT OF WAY OVER "EXISTING ROADWAY FROM CAHOON ROAD TO STANDPIPE..." AND AGREEMENTS AS DESCRIBED IN VOLUME 2988, PAGE 415 (NOT PLOTTABLE)
- E.) LICENSE TO EXCAVATE GRANTED TO WHITEHEAD BROTHERS COMPANY AS DESCRIBED IN VOLUME 3006, PAGE 290.
- F.) ORDER OF TAKING OF WATER LINE EASEMENT BY ONSET FIRE DISTRICT AS DESCRIBED IN VOLUME 4102, PAGE 692 AND DELINEATED ON PLAN REF. 1(N).
- G.) RIGHTS, RESTRICTIONS AND AGREEMENTS AS DESCRIBED IN VOLUME 5091, PAGE 489 (NOT PLOTTABLE)
- H.) ORDER OF TAKING BY THE TOWN OF WAREHAM AS DESCRIBED IN VOLUME 4798, PAGE 362 (NOT PLOTTABLE)
- I.) RIGHTS, RESTRICTIONS AND AGREEMENTS AS DESCRIBED IN VOLUME 7919, PAGE 125 AS AFFECTED BY THE RATIFICATION AND ACKNOWLEDGMENT REGARDING PROTECTIVE RESTRICTIONS (NOT PLOTTABLE).
- J.) ORDER OR TAKING OF RIGHT OF WAY AND WATER LINE EASEMENTS BY THE ONSET FIRE DISTRICT AS DESCRIBED IN VOLUME 9008, PAGE 161 AND DELINEATED ON PLAN REF. 1(I).
- K.) GRANT OF EASEMENT GRANTED TO ONSET FIRE DISTRICT AS DESCRIBED IN VOLUME 9008, PAGE 168 AND DELINEATED ON PLAN REF. 1(I).
- L.) UTILITY EASEMENTS GRANTED TO CAPE AND VINEYARD ELECTRIC COMPANY AS DESCRIBED IN VOLUME 1423, PAGE 470, VOLUME 1449, PAGE 395, VOLUME 1452, PAGE 342 & VOLUME 1447, PAGE 591 AND DELINEATED ON PLAN REF.'s 1(B), 1(E) AND 1(X).
- M.) ORDER OR TAKING OF RIGHT OF WAY AND WATER LINE EASEMENTS BY THE ONSET FIRE DISTRICT AS DESCRIBED IN VOLUME 9091, PAGE 14 AND DELINEATED AS EASEMENTS No. 1, No. 2 & No. 3 ON PLAN REF. 1(H).
- N.) GRANT OF EASEMENT GRANTED TO ONSET FIRE DISTRICT AS DESCRIBED IN VOLUME 9091, PAGE 19 AND DELINEATED AS EASEMENTS No. 1, No. 2 & No. 3 ON PLAN REF. 1(H).
- O.) GRANT OF EASEMENT GRANTED TO THE BAY POINTE CORPORATION FROM THE ONSET FIRE DISTRICT AS DESCRIBED IN VOLUME 9175, PAGE 45.
- P.) RECOGNITION AGREEMENT AS DESCRIBED IN VOLUME 9175, PAGE 50 (NOT PLOTTABLE)
- Q.) RECOGNITION AGREEMENT AS DESCRIBED IN VOLUME 9175, PAGE 53 (NOT PLOTTABLE) R.) GRANT OF EASEMENT AGREEMENT AS DESCRIBED IN VOLUME 9243, PAGE 185 WITH SAID
- S.) RIGHT OF WAY OVER "LOT 14" AS SHOWN ON PLAN REF. 1(R) AND THAT ROADWAY KNOWN AS "BAY POINTE DRIVE" AS DESCRIBED IN VOLUME 12524, PAGE 32.
- T.) AGREEMENT BETWEEN BPG CORP., BR RESIDENTIAL CORP., THE WAREHAM ECONOMIC DEVELOPMENT AND INDUSTRIAL CORPORATION, THE TOWN OF WAREHAM & BAYBANK AS DESCRIBED IN VOLUME 13912, PAGE 34 (NOT PLOTTABLE)
- U.) CONDITIONS AS SHOWN ON PLAN REF. 1(R).

EASEMENTS BEING DELINEATED ON PLAN REF. 1(G).

- V.) CONDITIONS AS SHOWN ON PLAN REF. 1(E).
- W.) CONDITIONS AS SHOWN ON PLAN REF. 1(B) **NOTE: TITLE COMMITMENT REFERENCES PLAN BY STENBECK & TAYLOR, INC. DATED: MARCH, 2006. THE PLAN THAT WAS OBTAINED WAS BY STENBECK & TAYLOR, INC. DATED: OCTOBER, 2006.
- X.) RECIPROCAL EASEMENT AGREEMENT AS DESCRIBED IN VOLUME 12524, PAGE 35
- Y.) EASEMENT GRANTED TO COMMONWEALTH ELECTRIC COMPANY AND NEW ENGLAND TELEPHONE
- 4. THESE PREMISES ARE SITUATED IN A 'CONFERENCE RECREATION' ZONE' (CR) & A 'MULTIPLE RESIDENCE' DISTRICT (MR-30)

DIMENSIONAL REQUIREMENTS MIN. LOT AREA	"CR" ZONE (NON-RESIDENTIAL) = 30,000 SQ.FT.	"MR-30" ZONE (SINGLE FAMILY) = 30,000 SQ.FT.
MIN. FRONTAGE	= 50 FT.	= 150 FT.
MIN. S/B FRONT YARD	= 10 FT.	= 20 FT.
MIN. S/B REAR YARD	= 10 FT.	= 10 FT.
MIN. S/B SIDE YARD	= 10 FT.	= 10 FT.
MAX. STRUCTURE HEIGHT	= 60 FT.	= 35 FT.
MAX. BUILDING COVERAGE	= (NO REGULATION)	= 25%

- NOTE ZONING INFORMATION IS FROM CURRENT ZONING AND MAY NOT REFLECT THE CONDITIONS AT THE TIME OF CONSTRUCTION OR ANY VARIANCES GRANTED. 5. PORTIONS OF THESE PREMISES ARE SITUATED IN A ZONE 'AE' (EL.'s 14 &15), ZONE 'X' (AREA OF 0.2%
- ANNUAL CHANCE FLOOD...) AND ZONE 'X' (AREAS DETERMINED TO BE OUTSIDE THE 0.2% ANNUAL CHANCE FLOODPLAIN) AS DESIGNATED ON THE "NATIONAL FLOOD INSURANCE PROGRAM, FIRM FLOOD INSURANCE RATE MAP PLYMOUTH COUNTY, MASSACHUSETTS (ALL JURISDICTIONS), PANEL 582 OF 650 TOWN OF WAREHAM MAP NUMBER 25023C0582J MAP REVISED: JULY 17, 2012, FEDERAL EMERGENCY MANAGEMENT
- 6. ANY UTILITIES SHOWN ON THIS PLAN HAVE BEEN LOCATED FROM FIELD SURVEY INFORMATION AND EXISTING PLANS. THE SURVEYOR MAKES NO GUARANTEE THAT THE UTILITIES SHOWN COMPRISE ALL SUCH OR ABANDONED. THE SURVEYOR DOES NOT WARRANT THAT THE UTILITIES SHOWN ARE IN THE EXACT LOCATION INDICATED ALTHOUGH THEY ARE LOCATED AS ACCURATELY AS POSSIBLE FROM ALL AVAILABLE INFORMATION. (PLEASE CONTACT DIG SAFE 72 HOURS PRIOR TO CONSTRUCTION AT
- PHONE NO. 1-888-DIG-SAFE AND/OR ALL LOCAL UTILITY COMPANIES.) 7. THE LOCATION OF THE RAILROAD RIGHT OF WAY WAS REPRODUCED FROM EXISTING PLANS / DEEDS OF RECORD. NO RAILROAD MONUMENTATION COULD BE FOUND NOR WAS LOCATED AS PART OF
- 8. REFERENCE IS MADE TO THE TAKING OF LONG NECK ROAD AS LAID OUT PER ORDER OF TAKING FEB. 4,
- 1942 WHICH IS DELINEATED ON PLAN REF. 1(B). 9. PLANIMETRICS & TOPOGRAPHY SHOWN FROM AERIAL MAPPING COMPILED BY EASTERN TOPOGRAPHICS. P.O. BOX 970 ~ 495 CENTER STREET, WOLFEBORO, NH. 03894-0970 SUPPLEMENTED BY FIELD EDITS.

AERIAL PHOTOGRAPHS EXPOSED APRIL 5, 1994 & NOVEMBER 20, 2013. GROUND CONTROL BY WATERMAN ENGINEERING CO. BUILDING LINES REPRESENT ROOF LINES AS SEEN IN AERIAL PHOTOGRAPHY.

- 10. THE SUBJECT PROPERTY LIES WITHIN "PRIORITY HABITAT 1396" PER THE MASSACHUSETTS NATURAL HERITAGE & ENDANGERED SPECIES PROGRAM GIS DATABASE.
- 11. A PORTION OF THE SUBJECT PROPERTY LIES WITHIN A D.E.P. ZONE II WELLHEAD PROTECTION AREA PER THE


3	09/02/15	ADDED ADDITIONAL ROW INFORMATION	RSL
2	07/23/15	REVISED CAHOON STREET	RSL
1	02/20/14	ADDED ADDITIONAL SEWER / WATER LINE INFO.	RSL
NO.	DATE	REVISION	CHECKED BY
BOUNDARY & TOPOGRAPHIC SURVEY PLAN ASSESSOR'S PLATS 2, 8, 9 & 10, LOTS 1004A & 1004B ONSET AVENUE, CAHOON STREET & BAY POINTE DR. WAREHAM, MASSACHUSETTS		11-077 SCALE: I* = 100 DATE: 01/15/14 DRAWN BY: BJT CHECKED BY:	
		AY POINTE COUNTRY CLUB 19 BAY POINTE DRIVE NSET, MASSACHUSETTS 02558	RSI FILENAME: 11-077_SU1_2014 3 of 3 SHTS


East Providence, RI


Phone: (401) - 438 - 5775


Fax: (401) - 438 - 5773




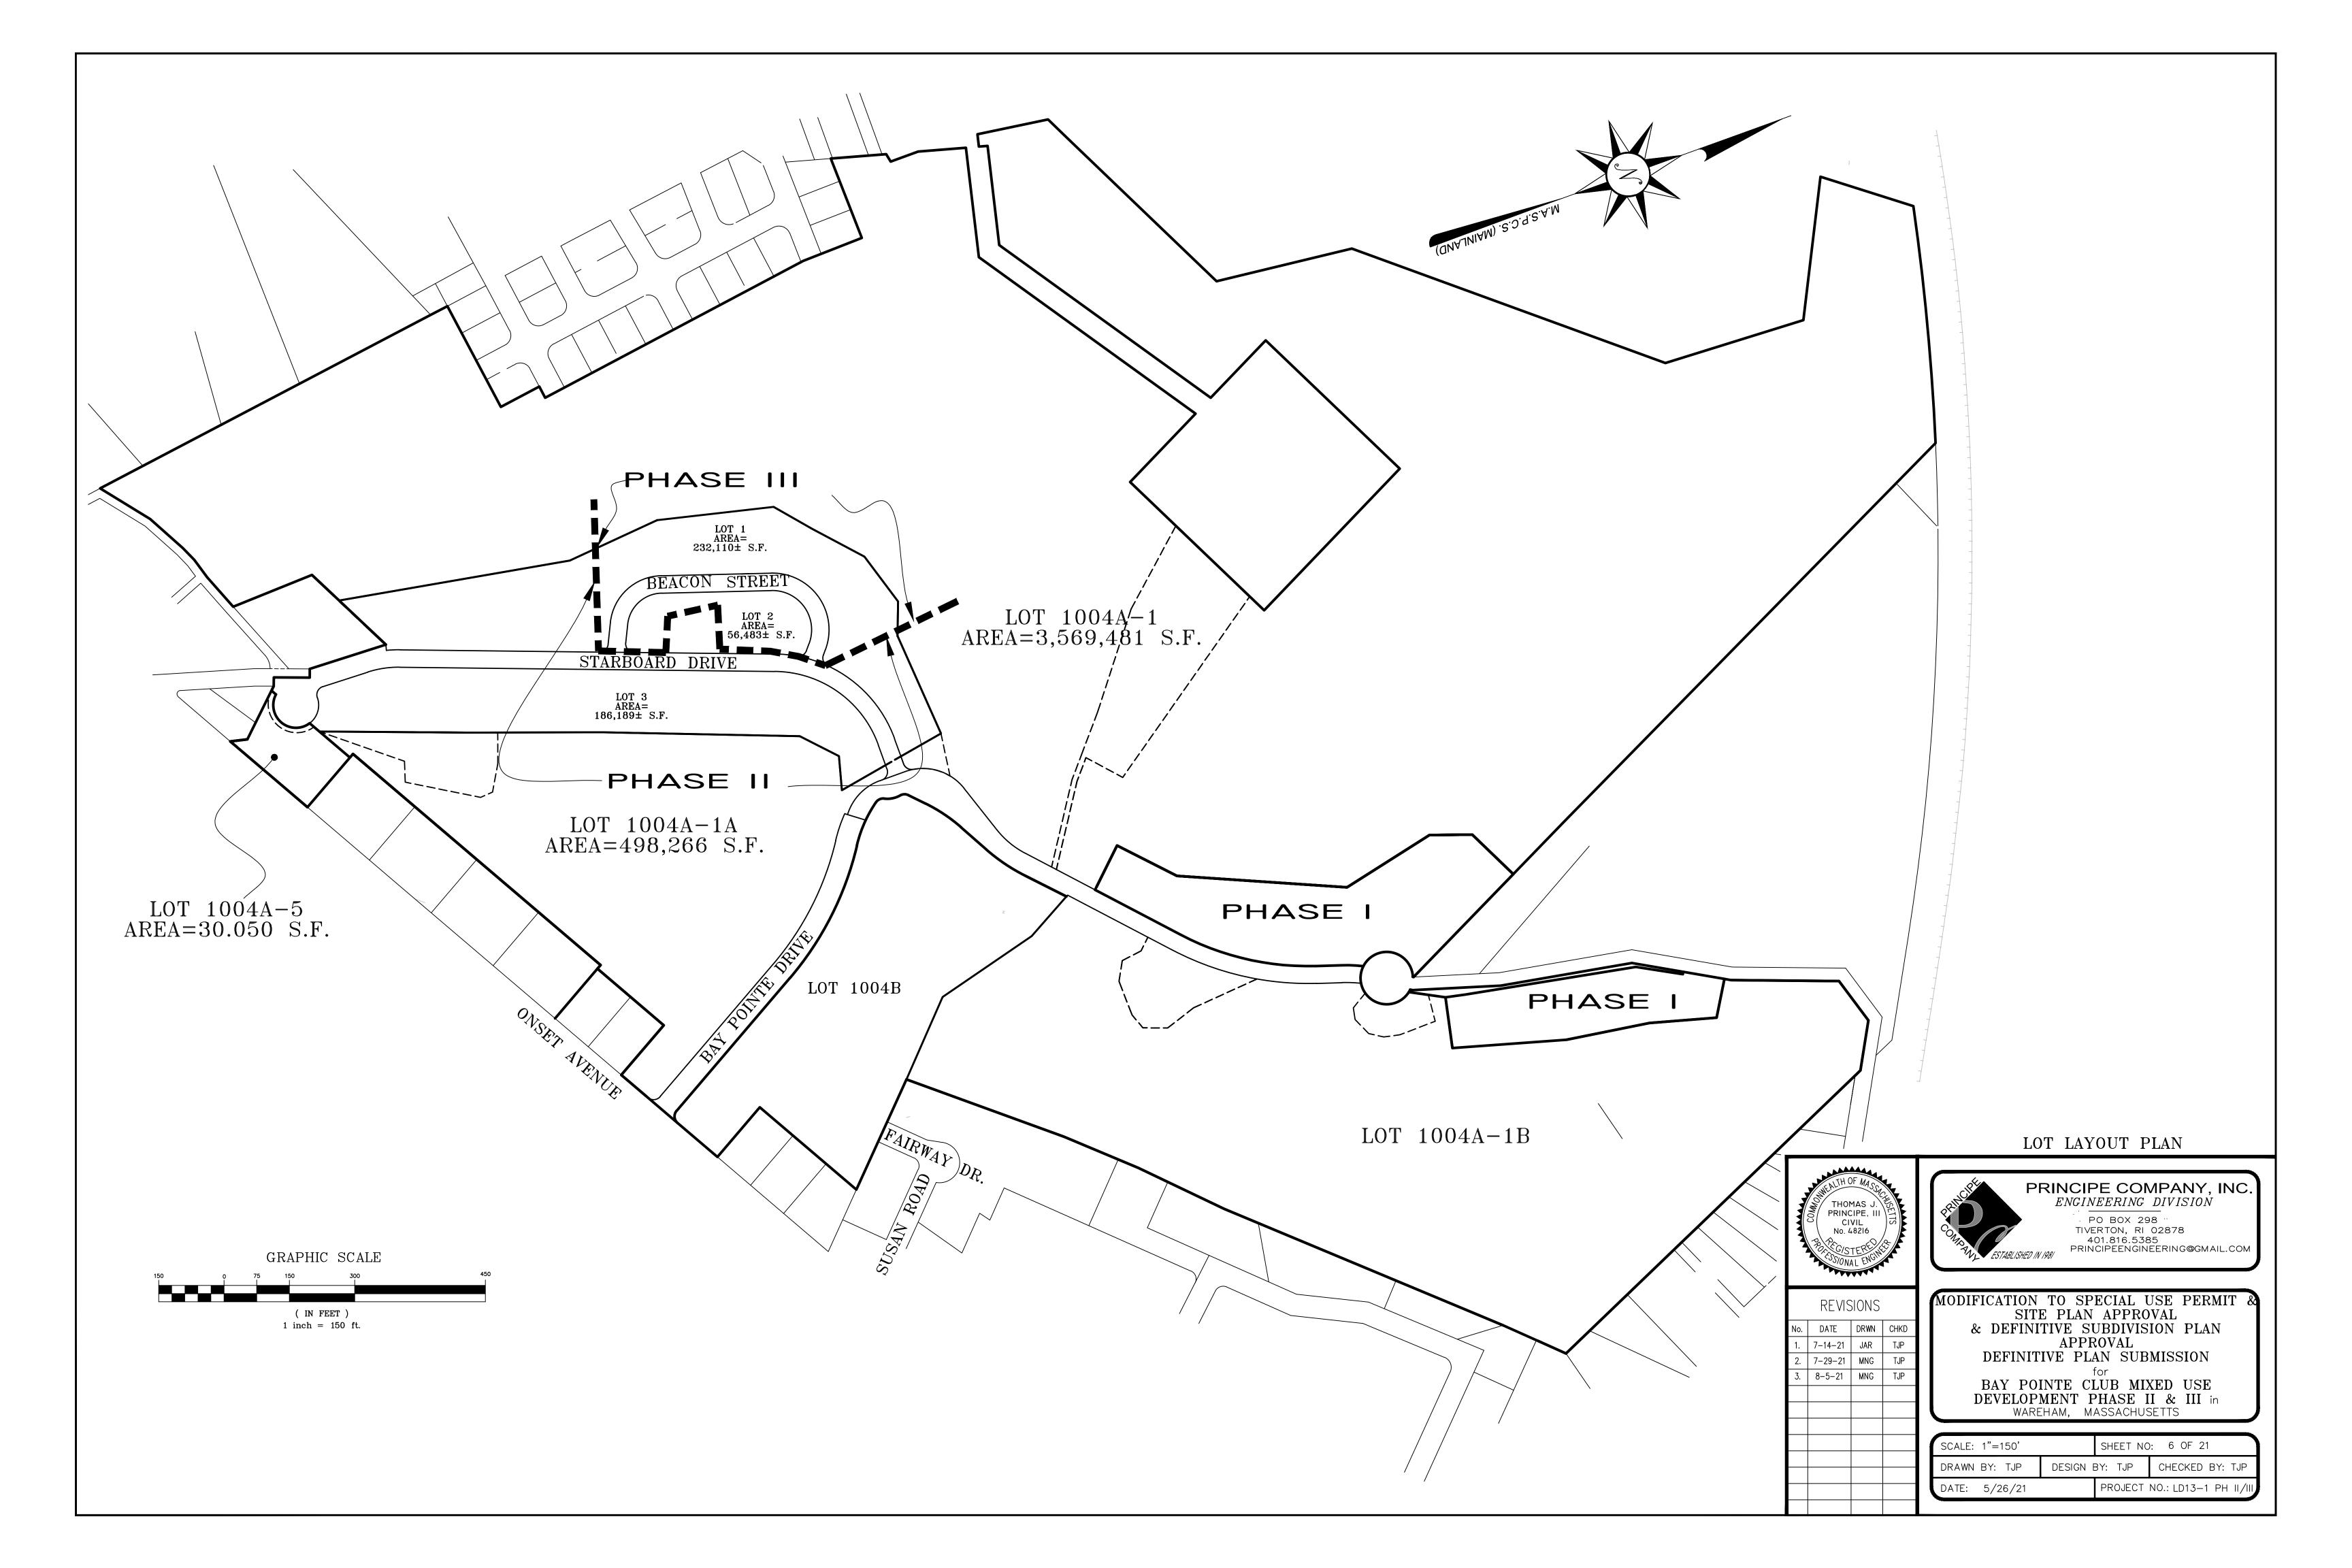


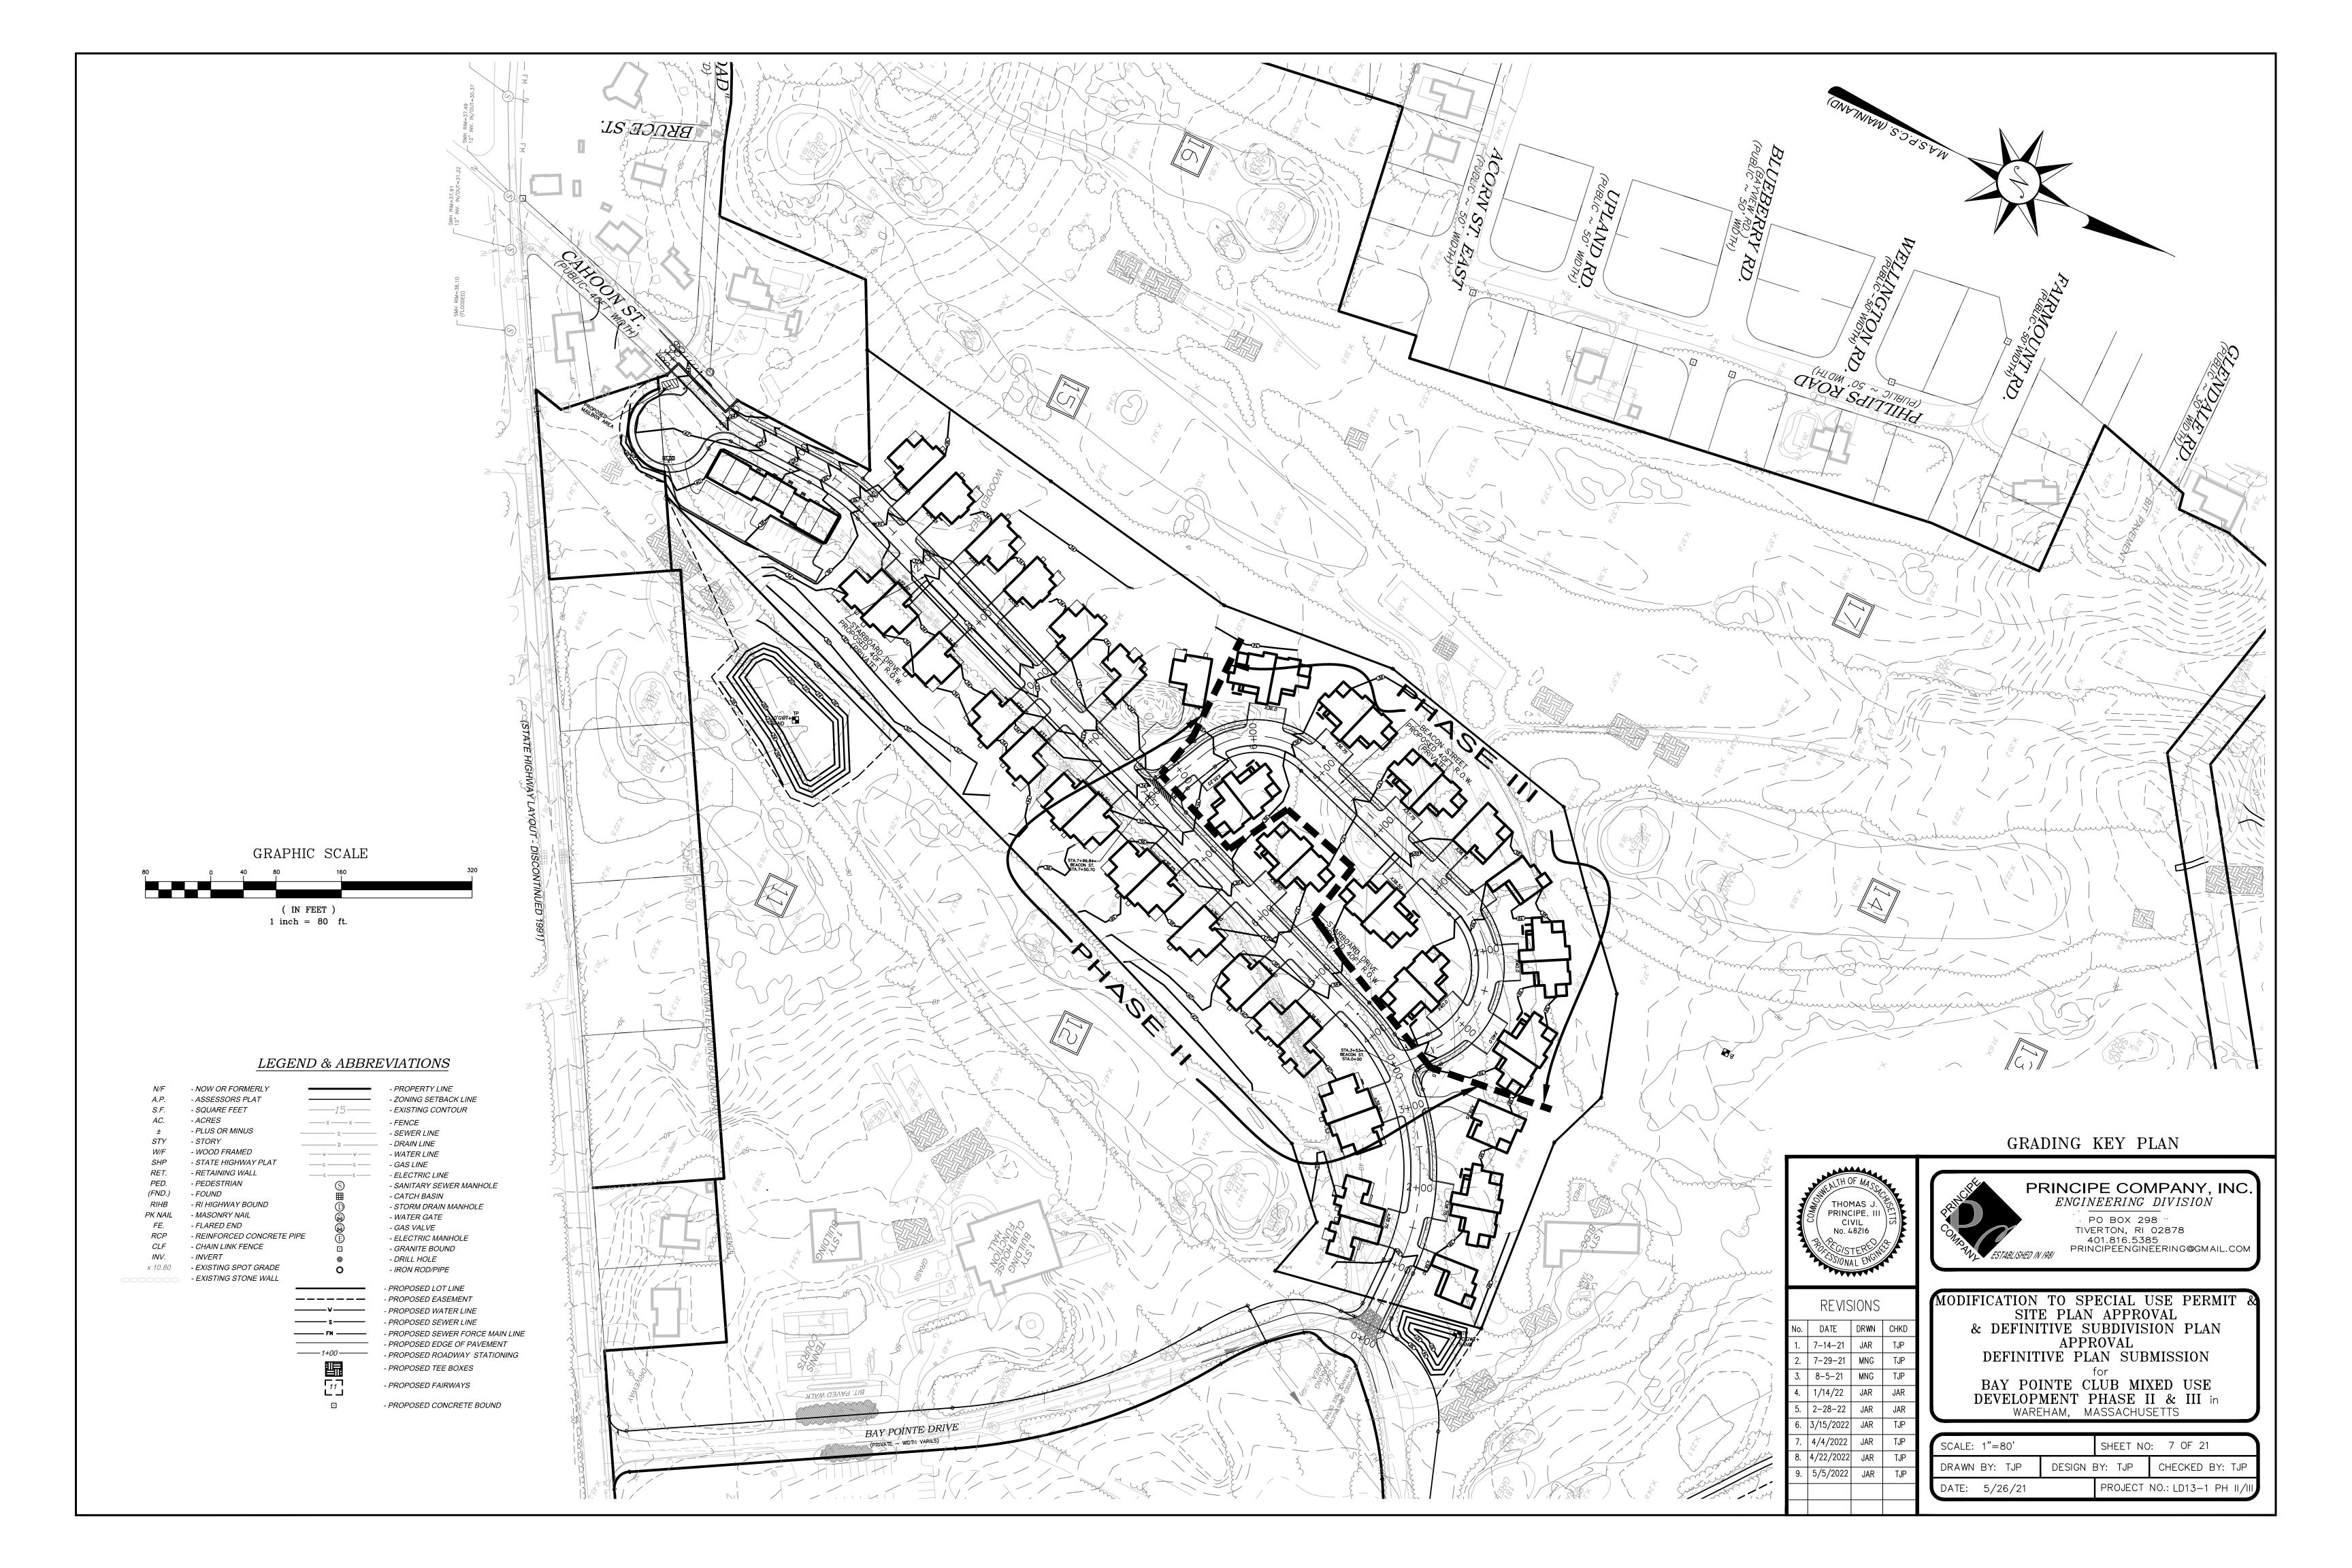


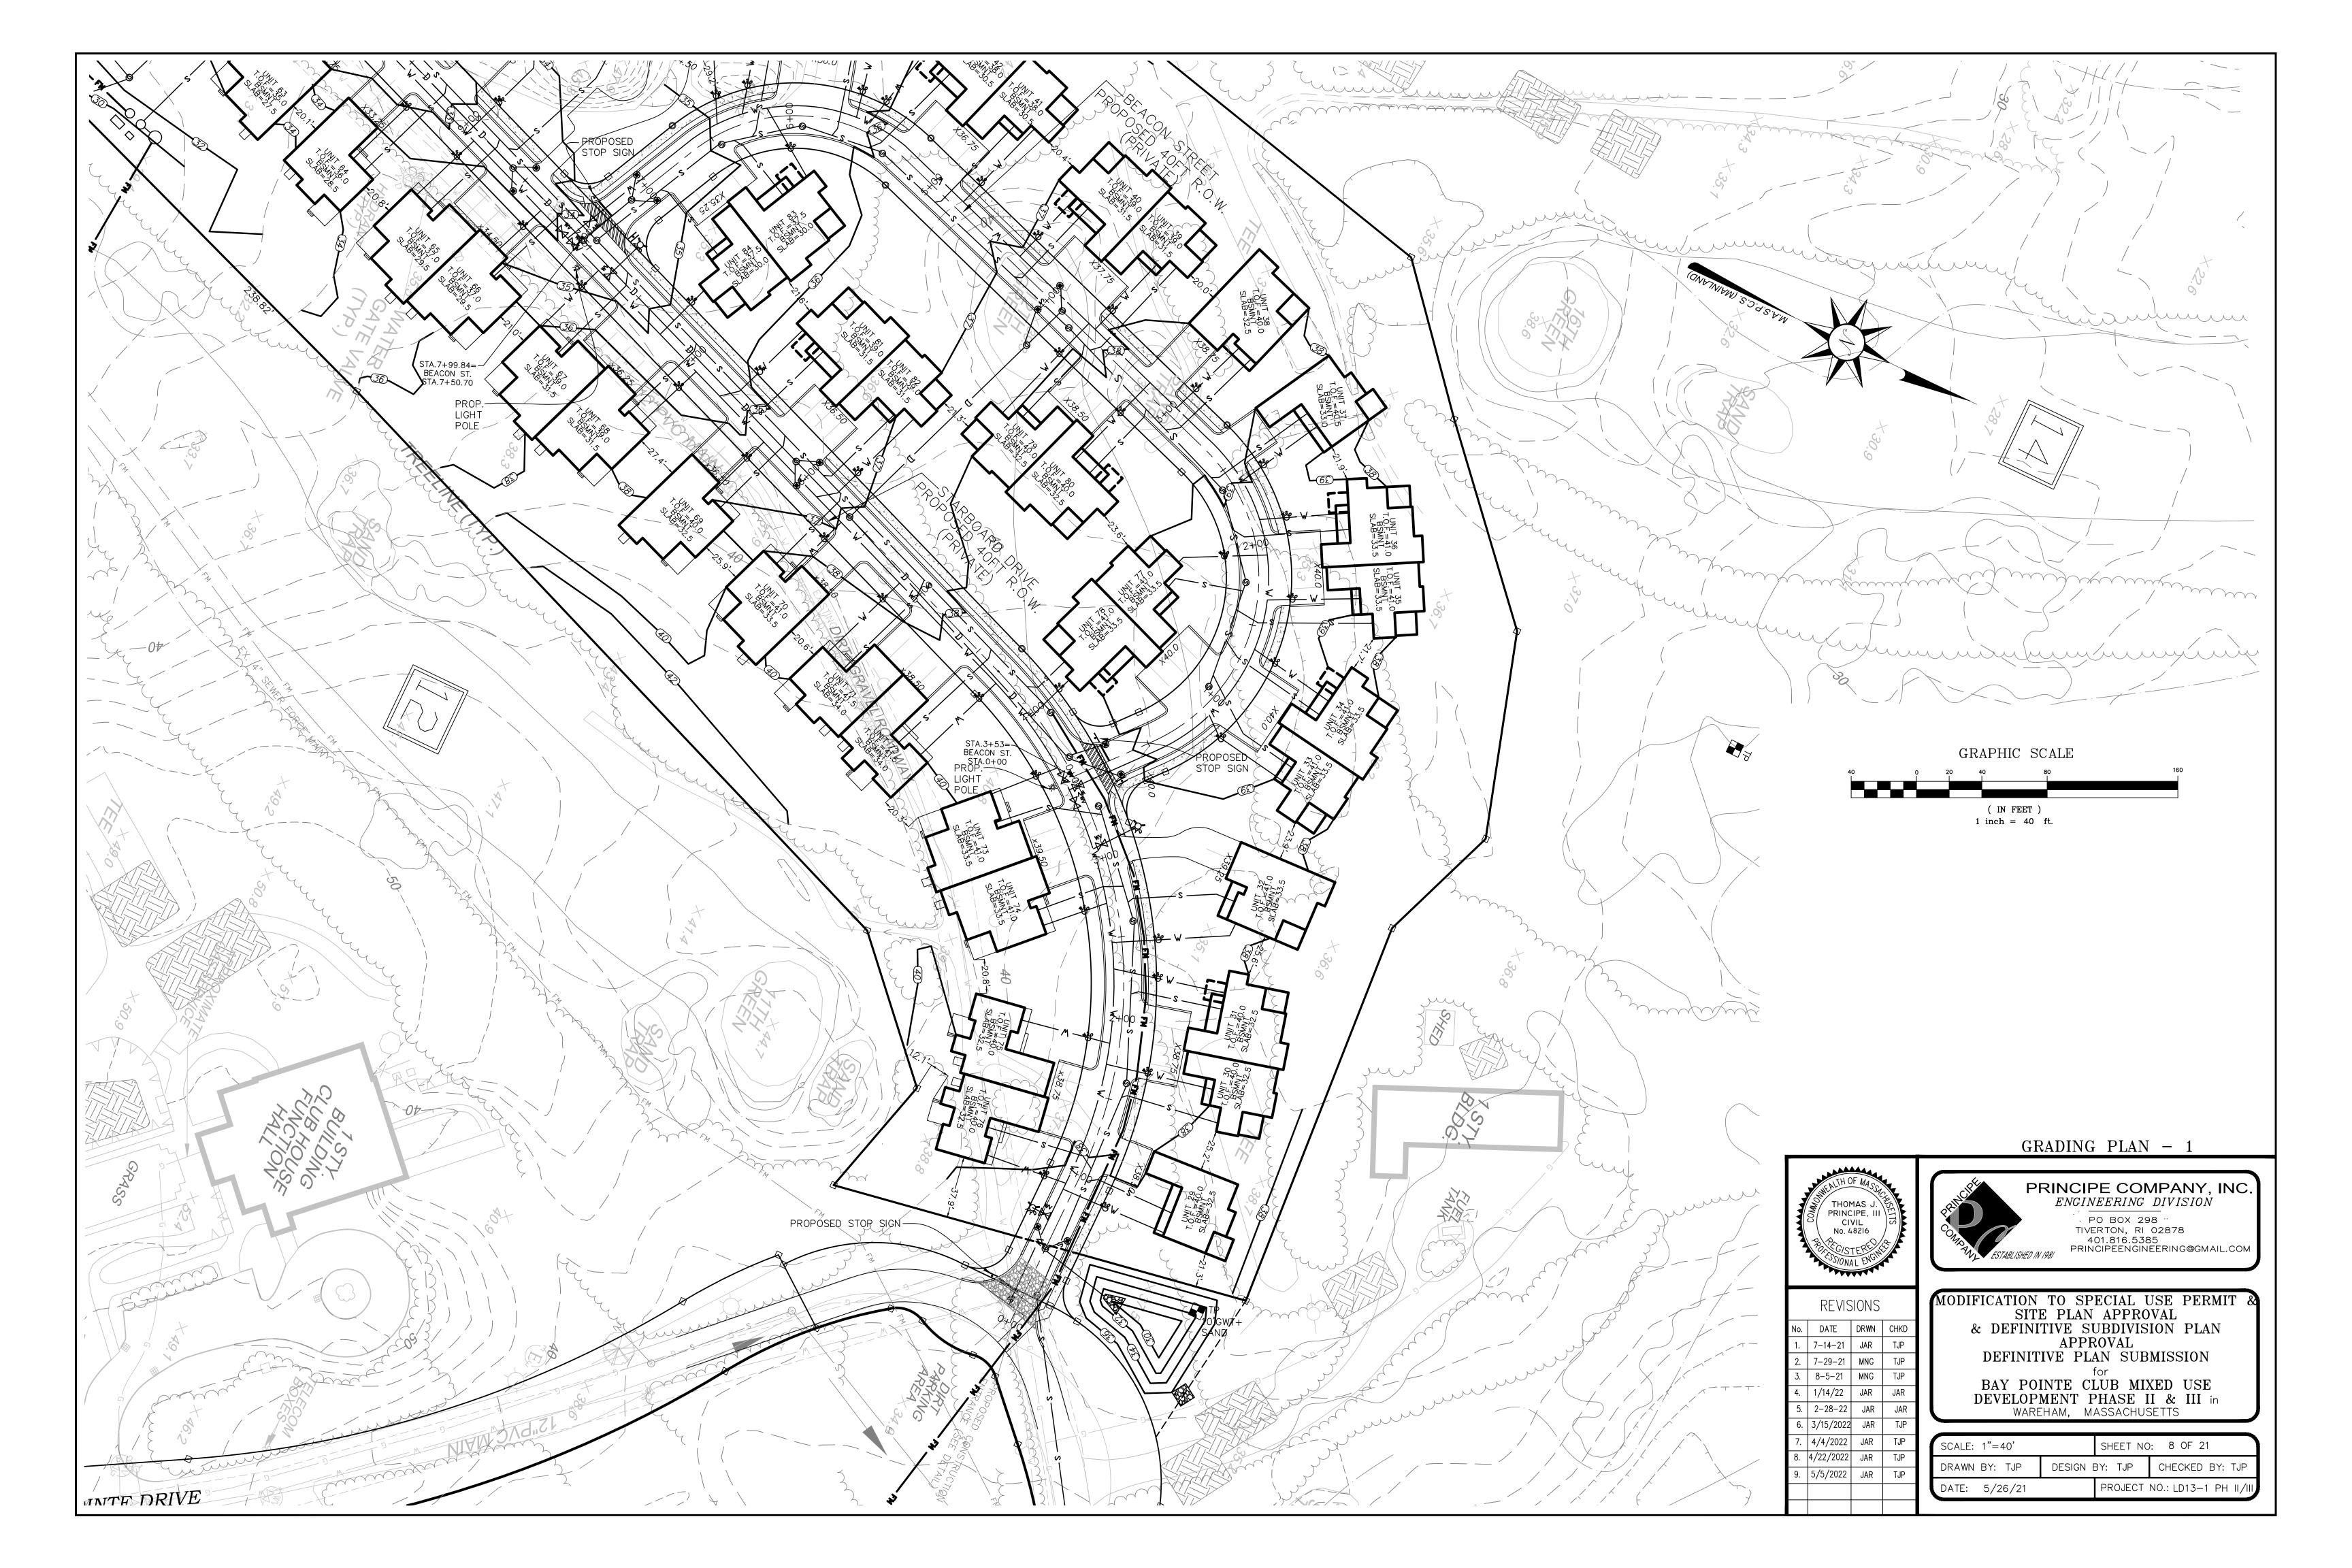


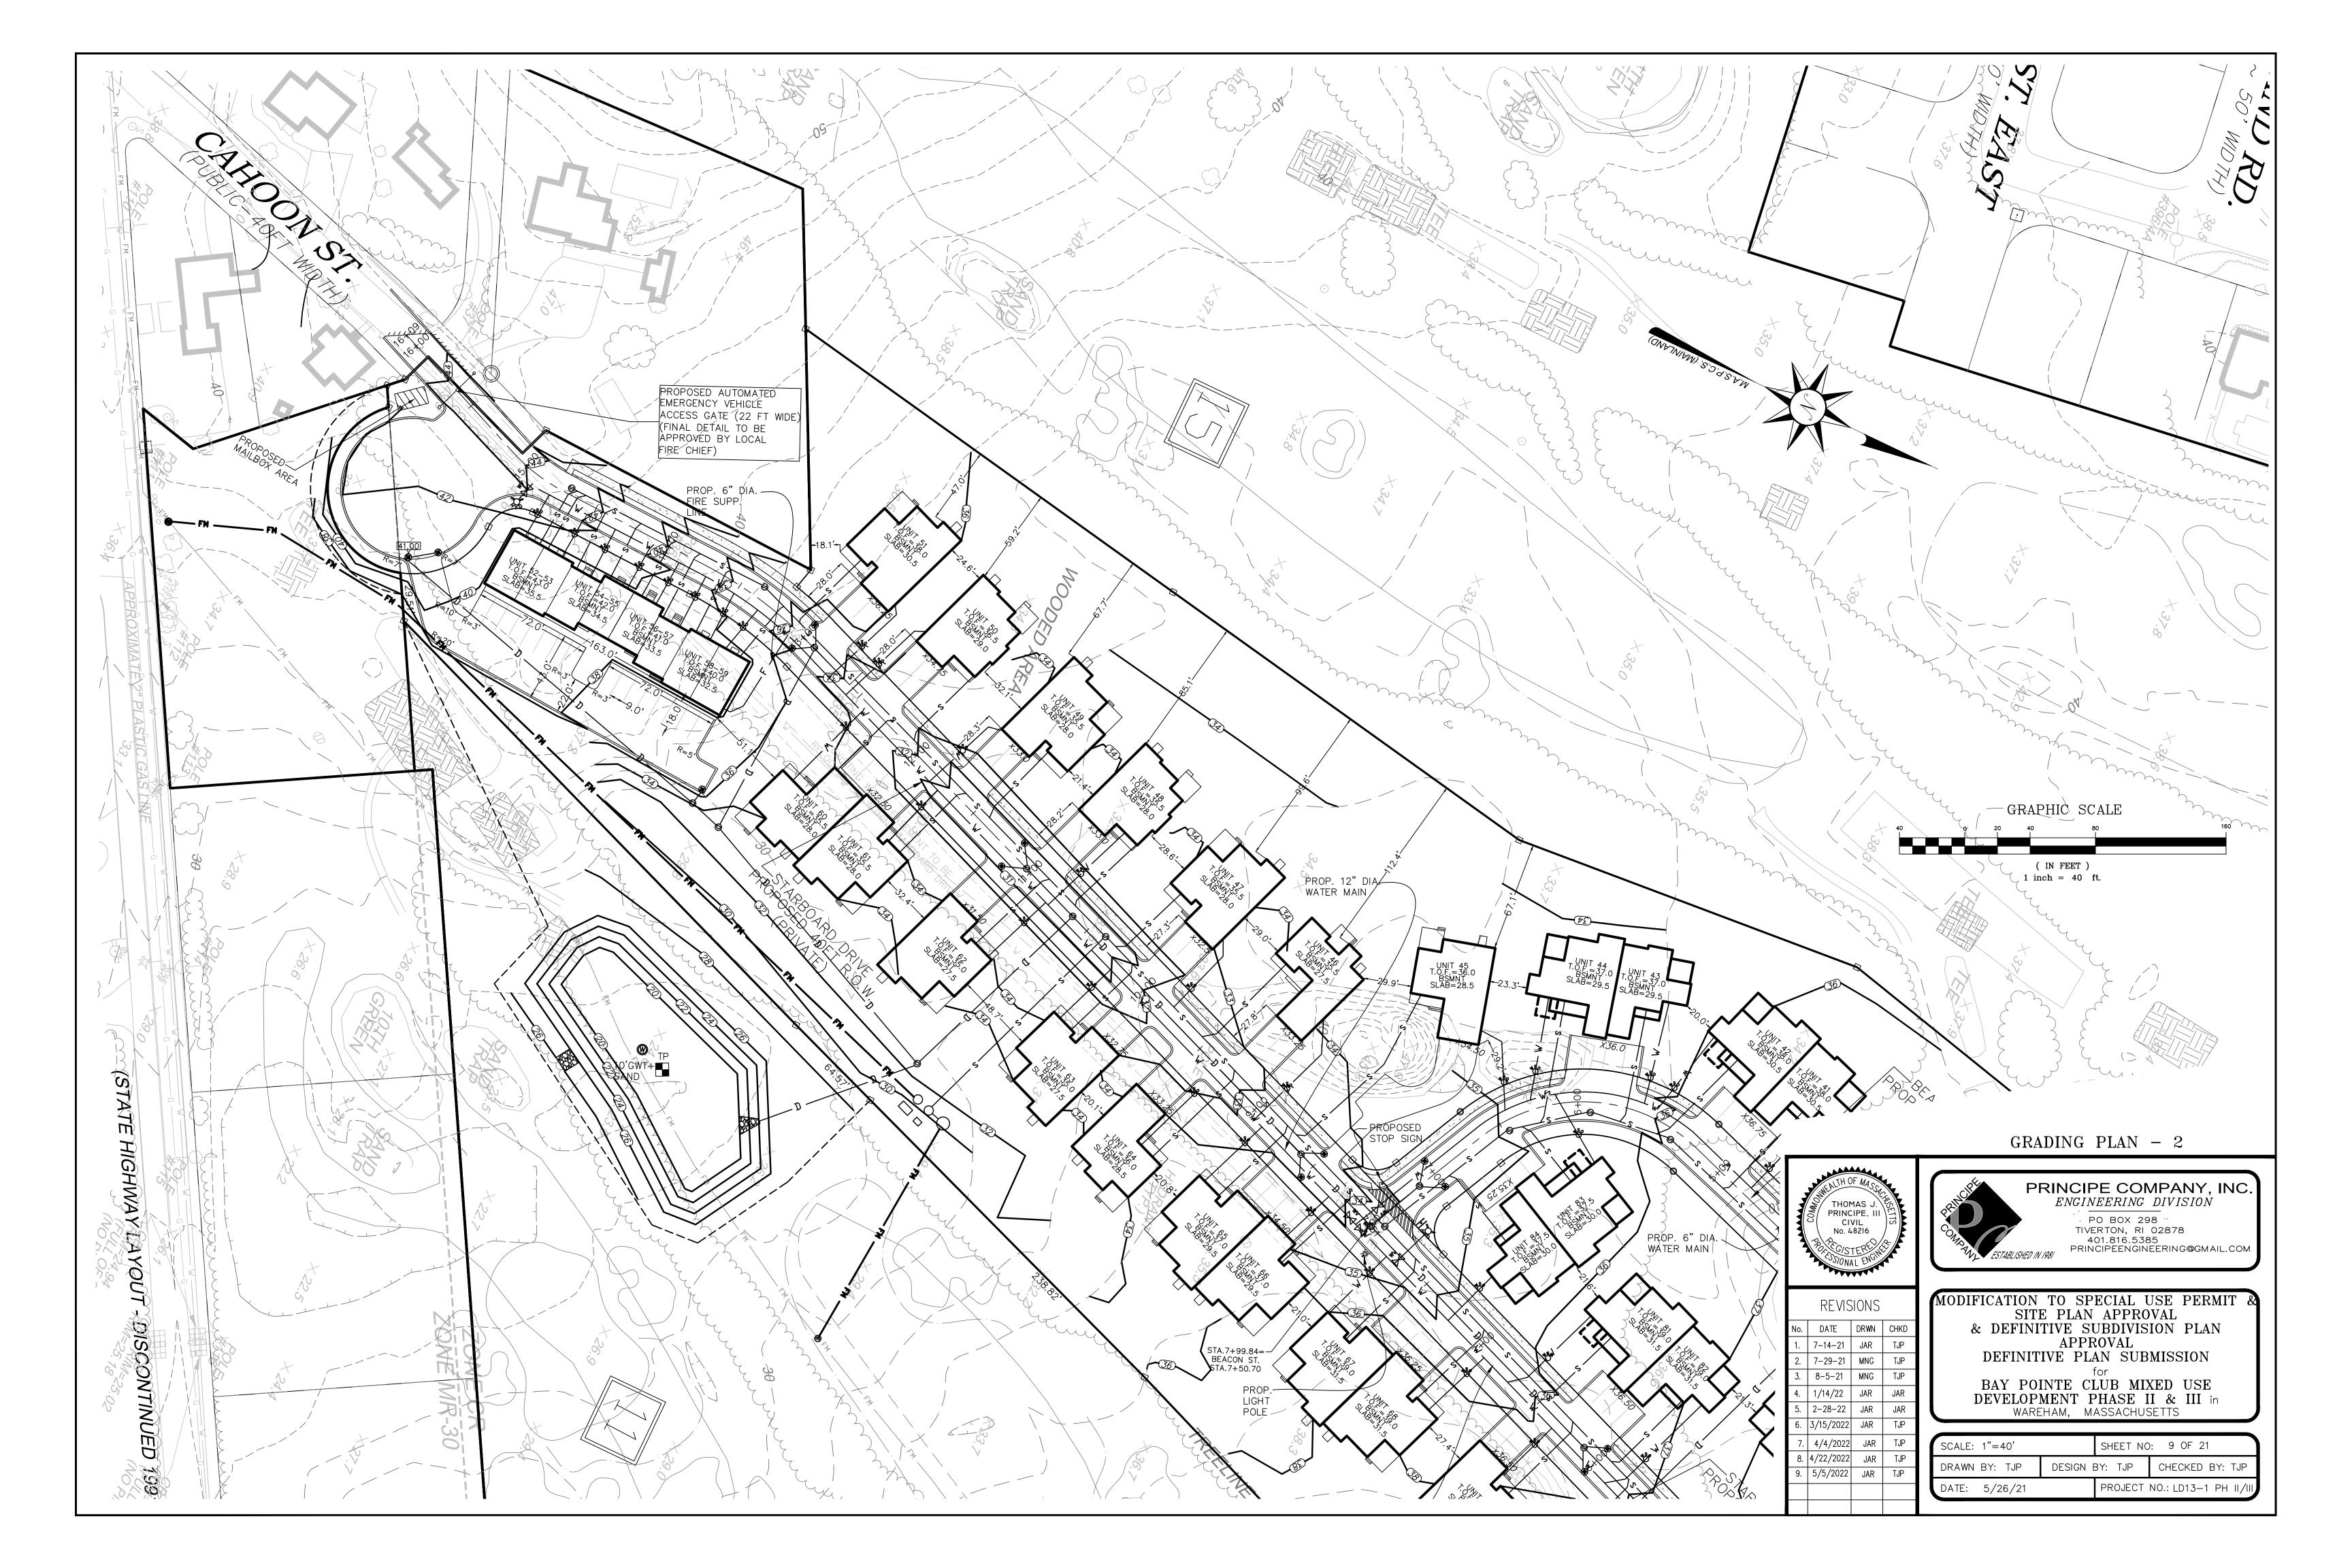


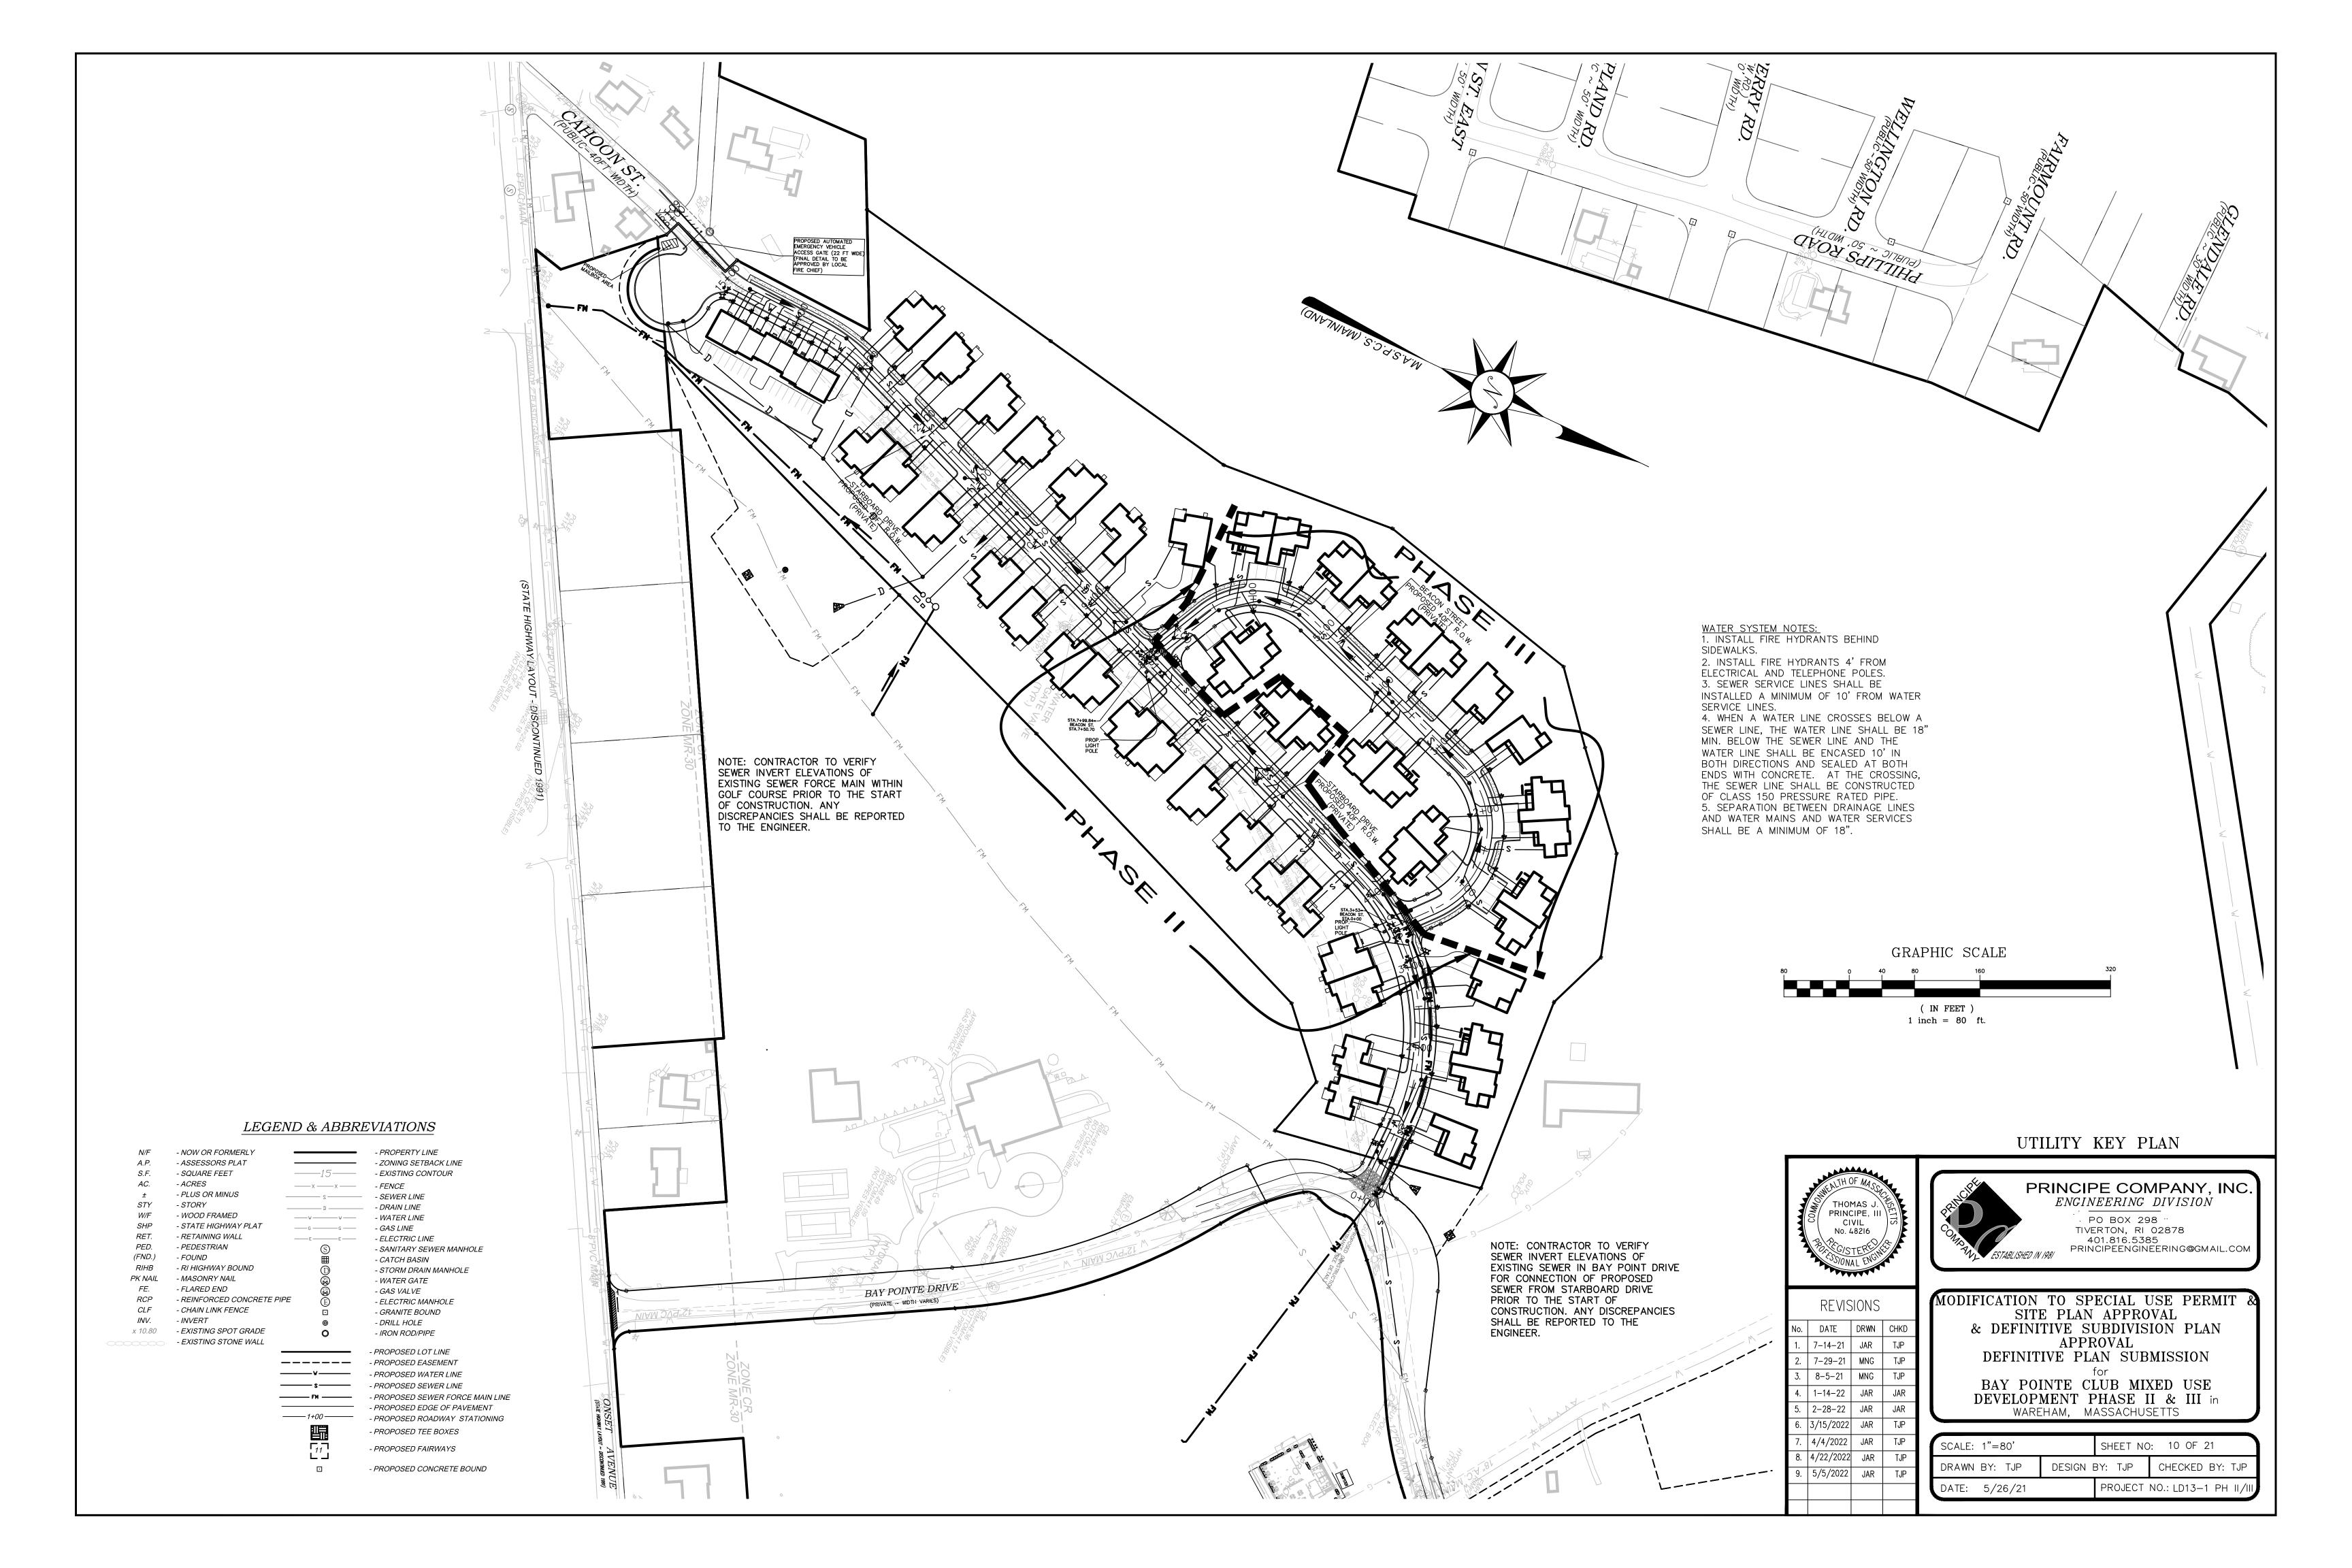


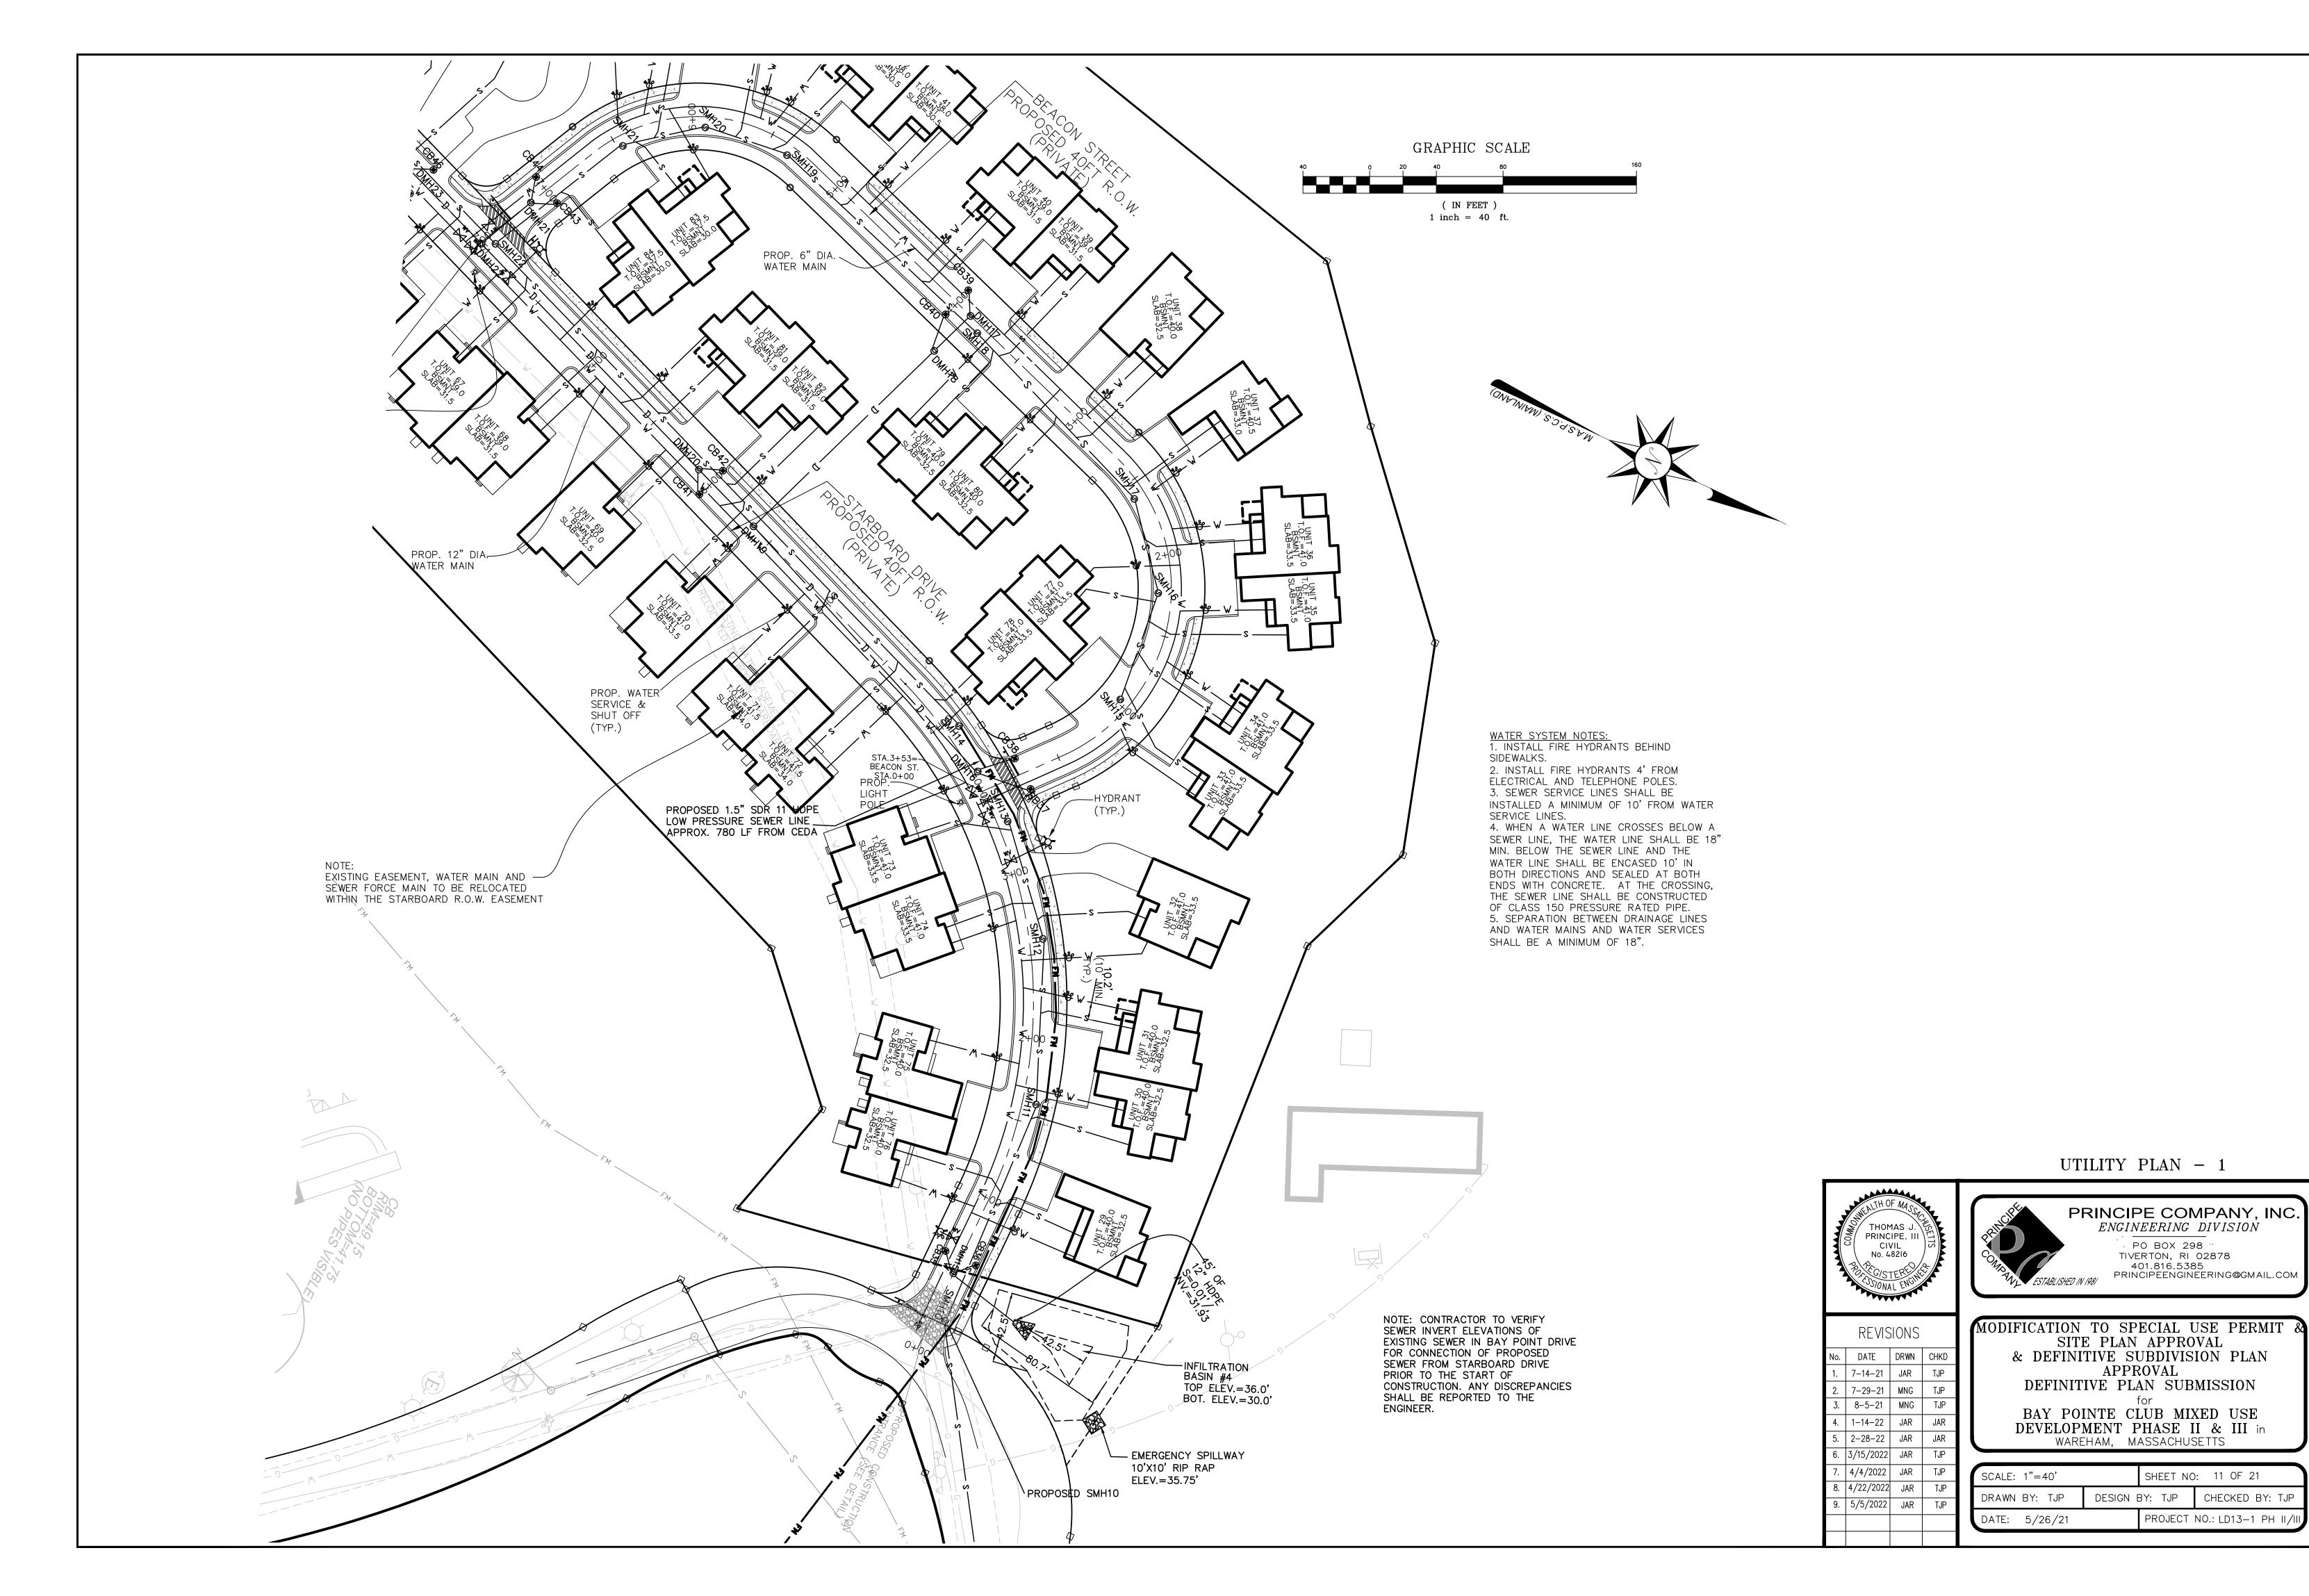


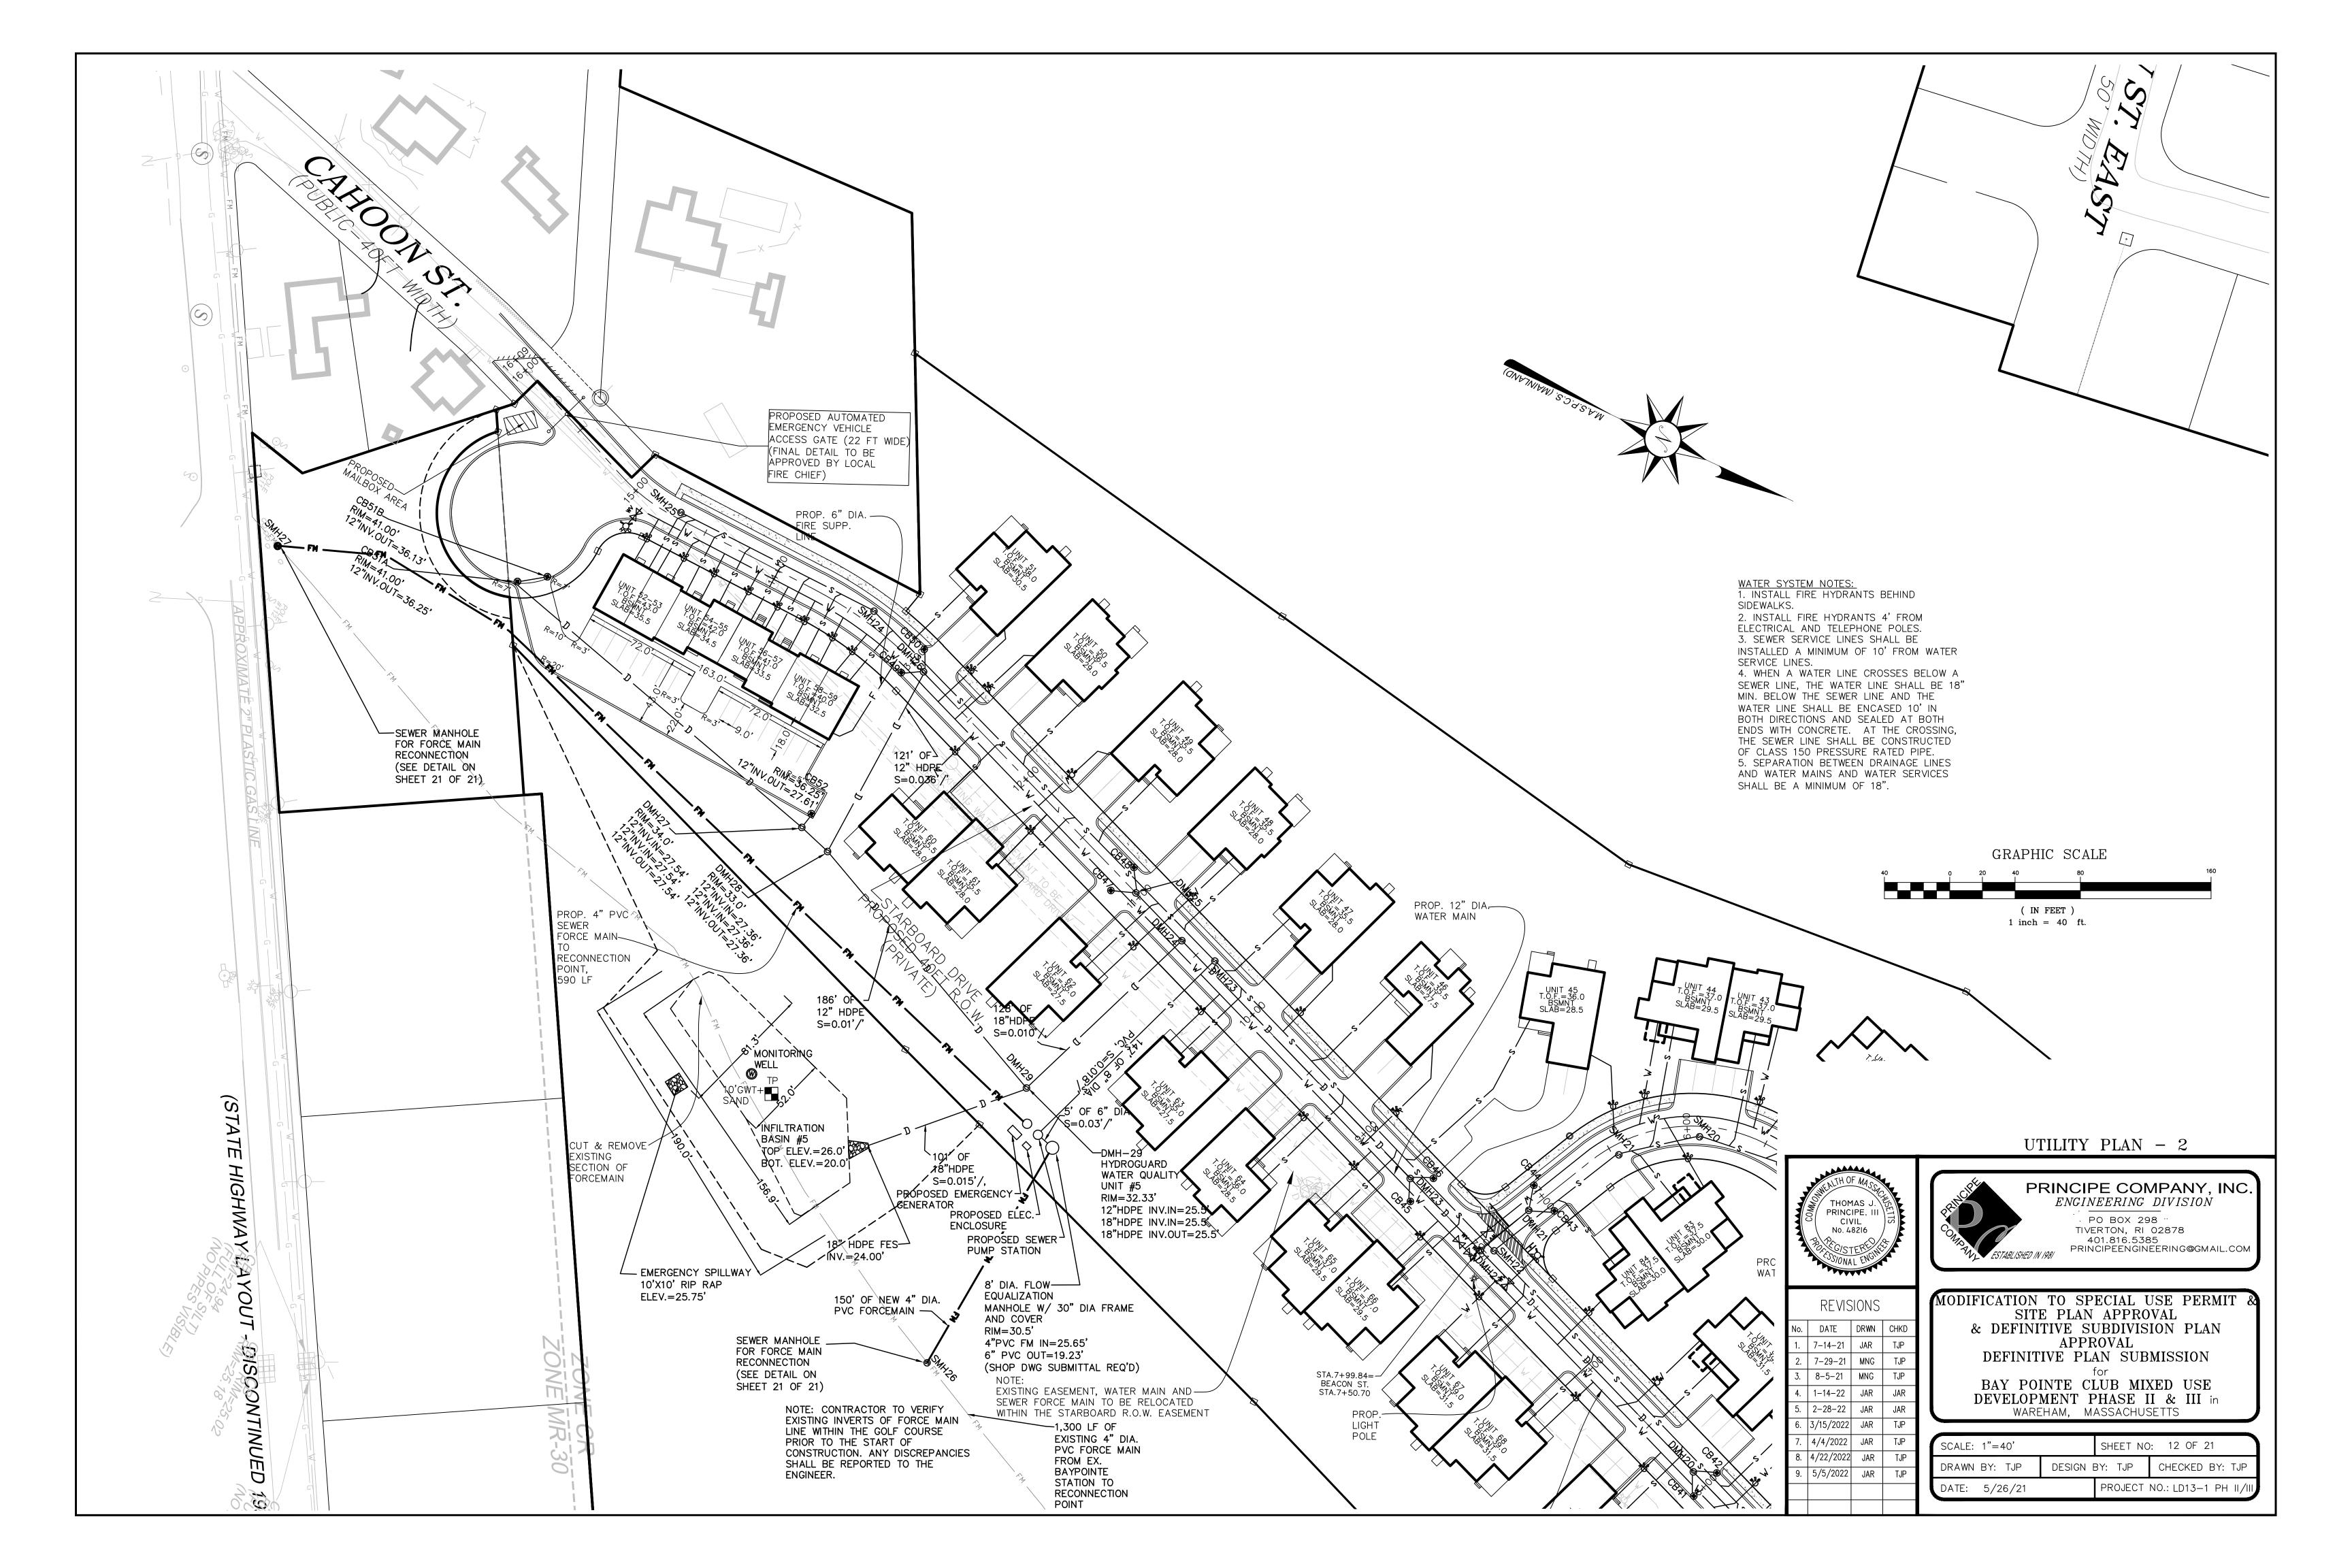


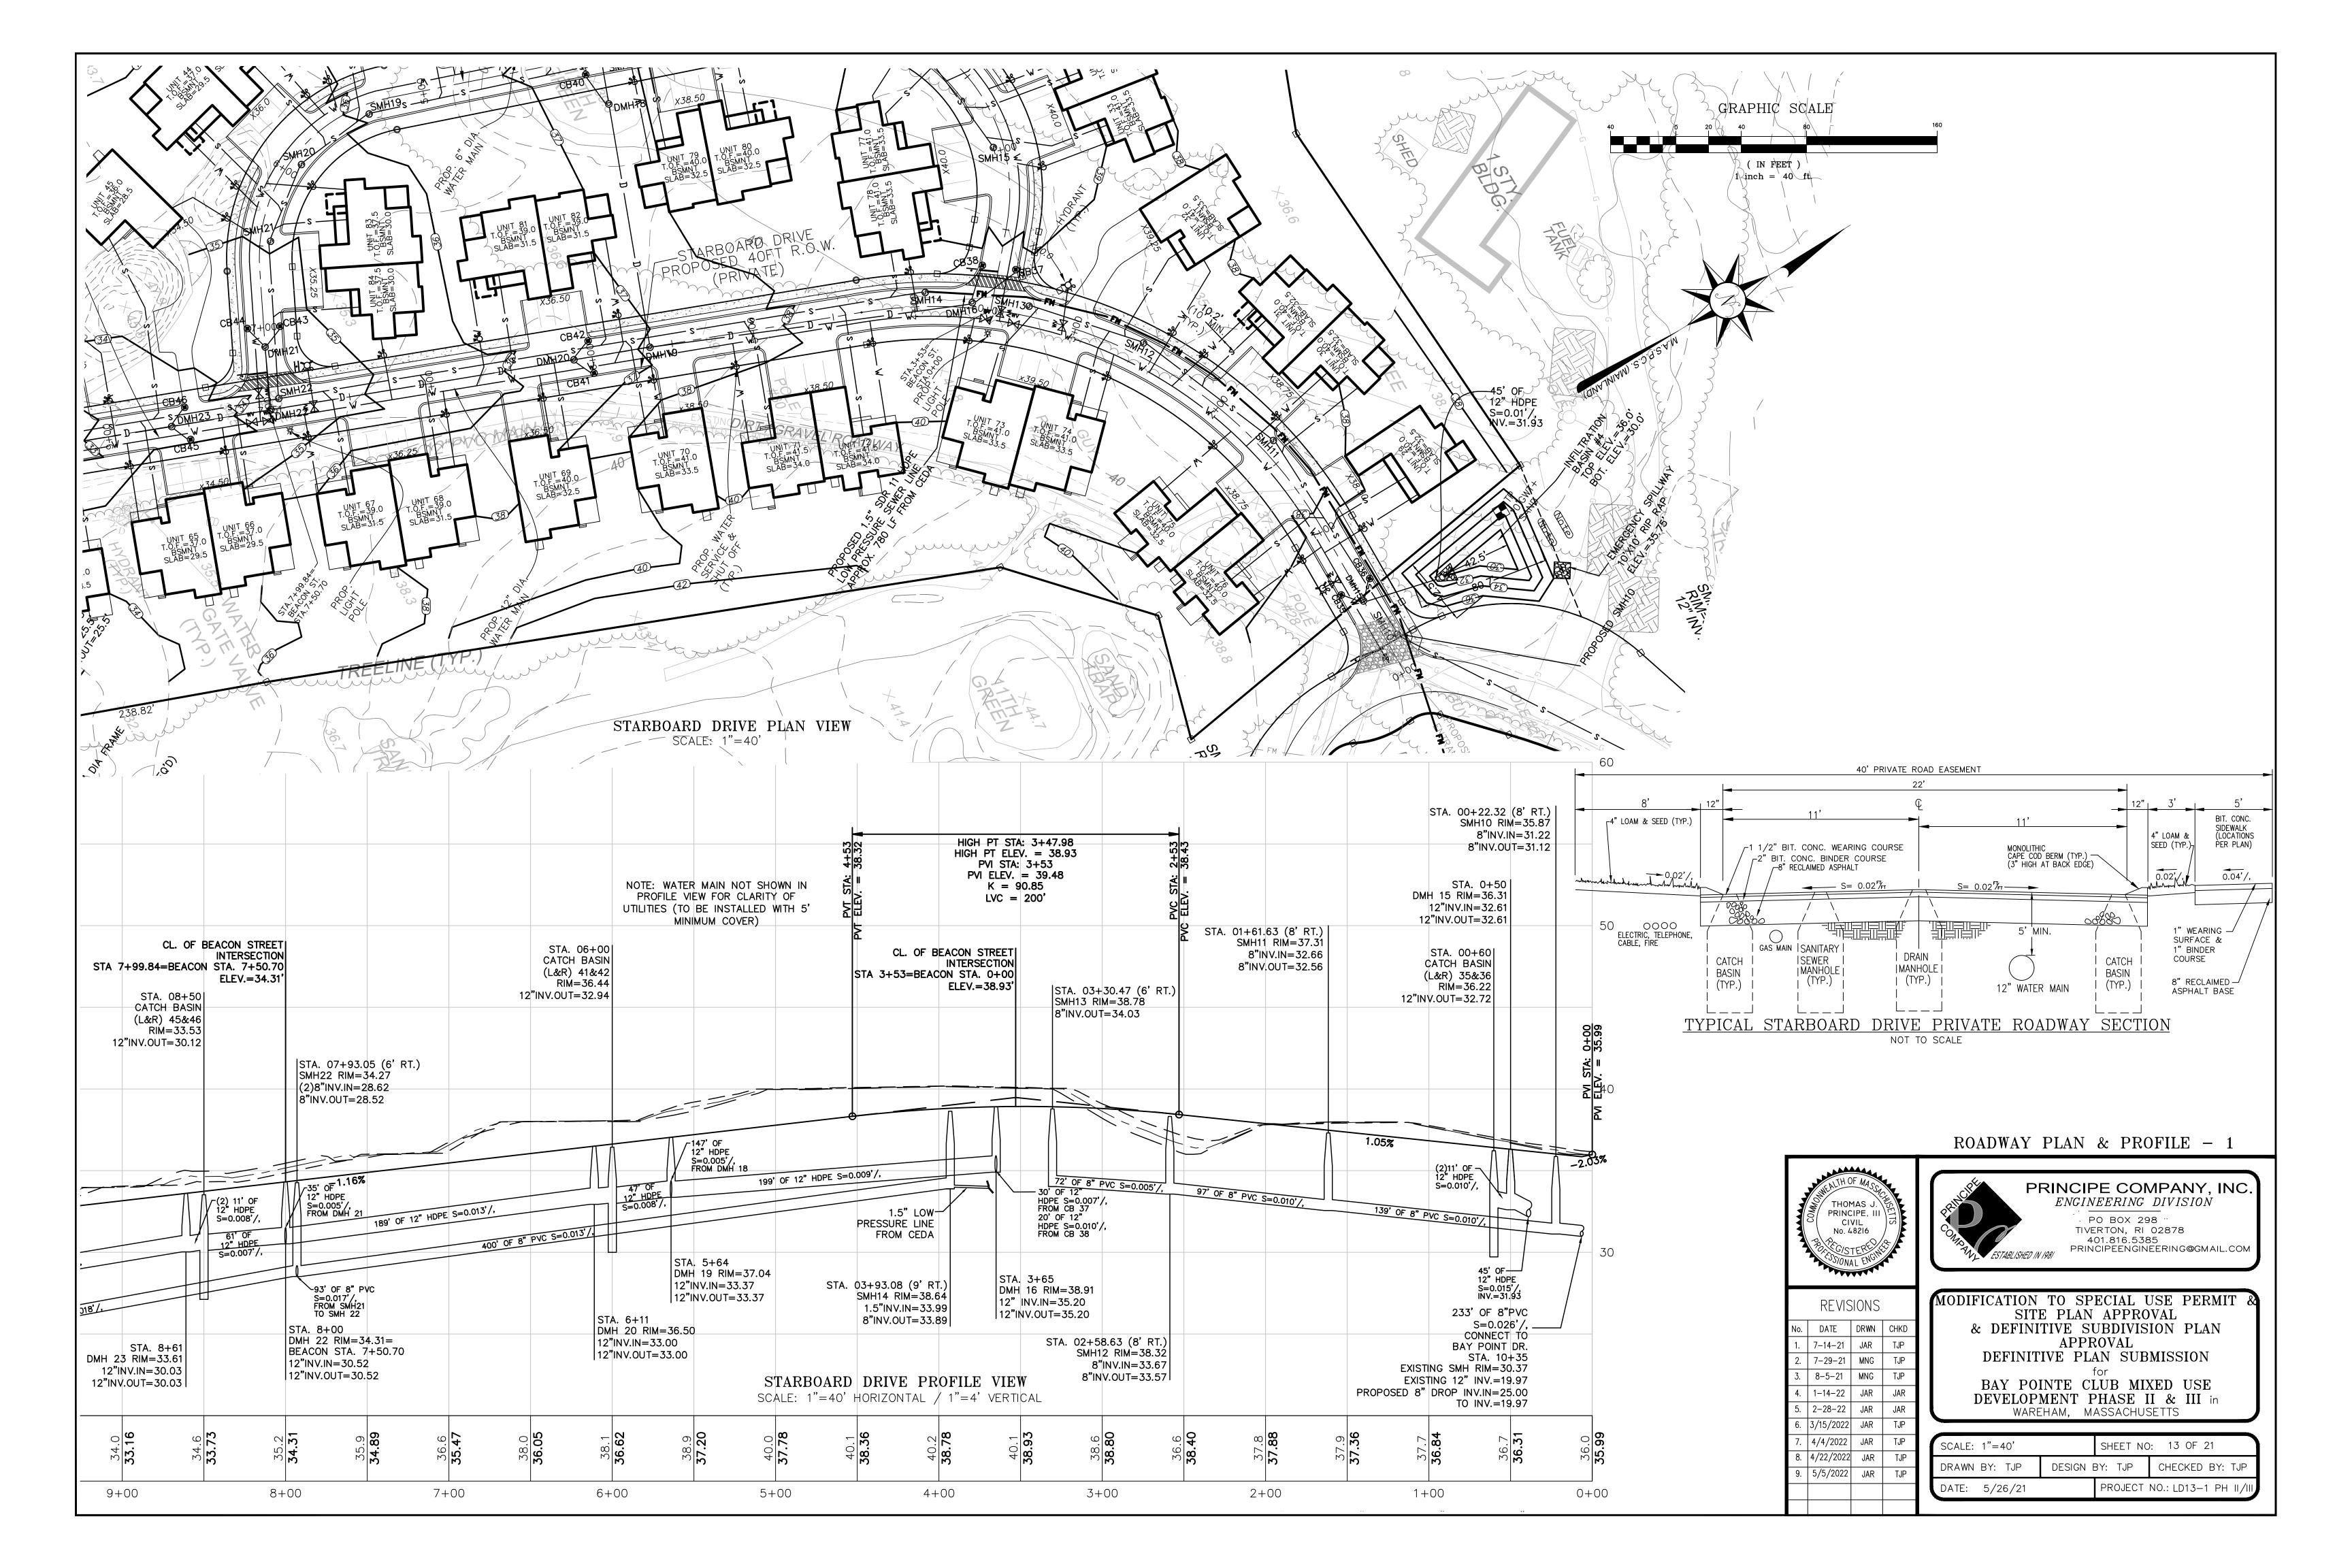

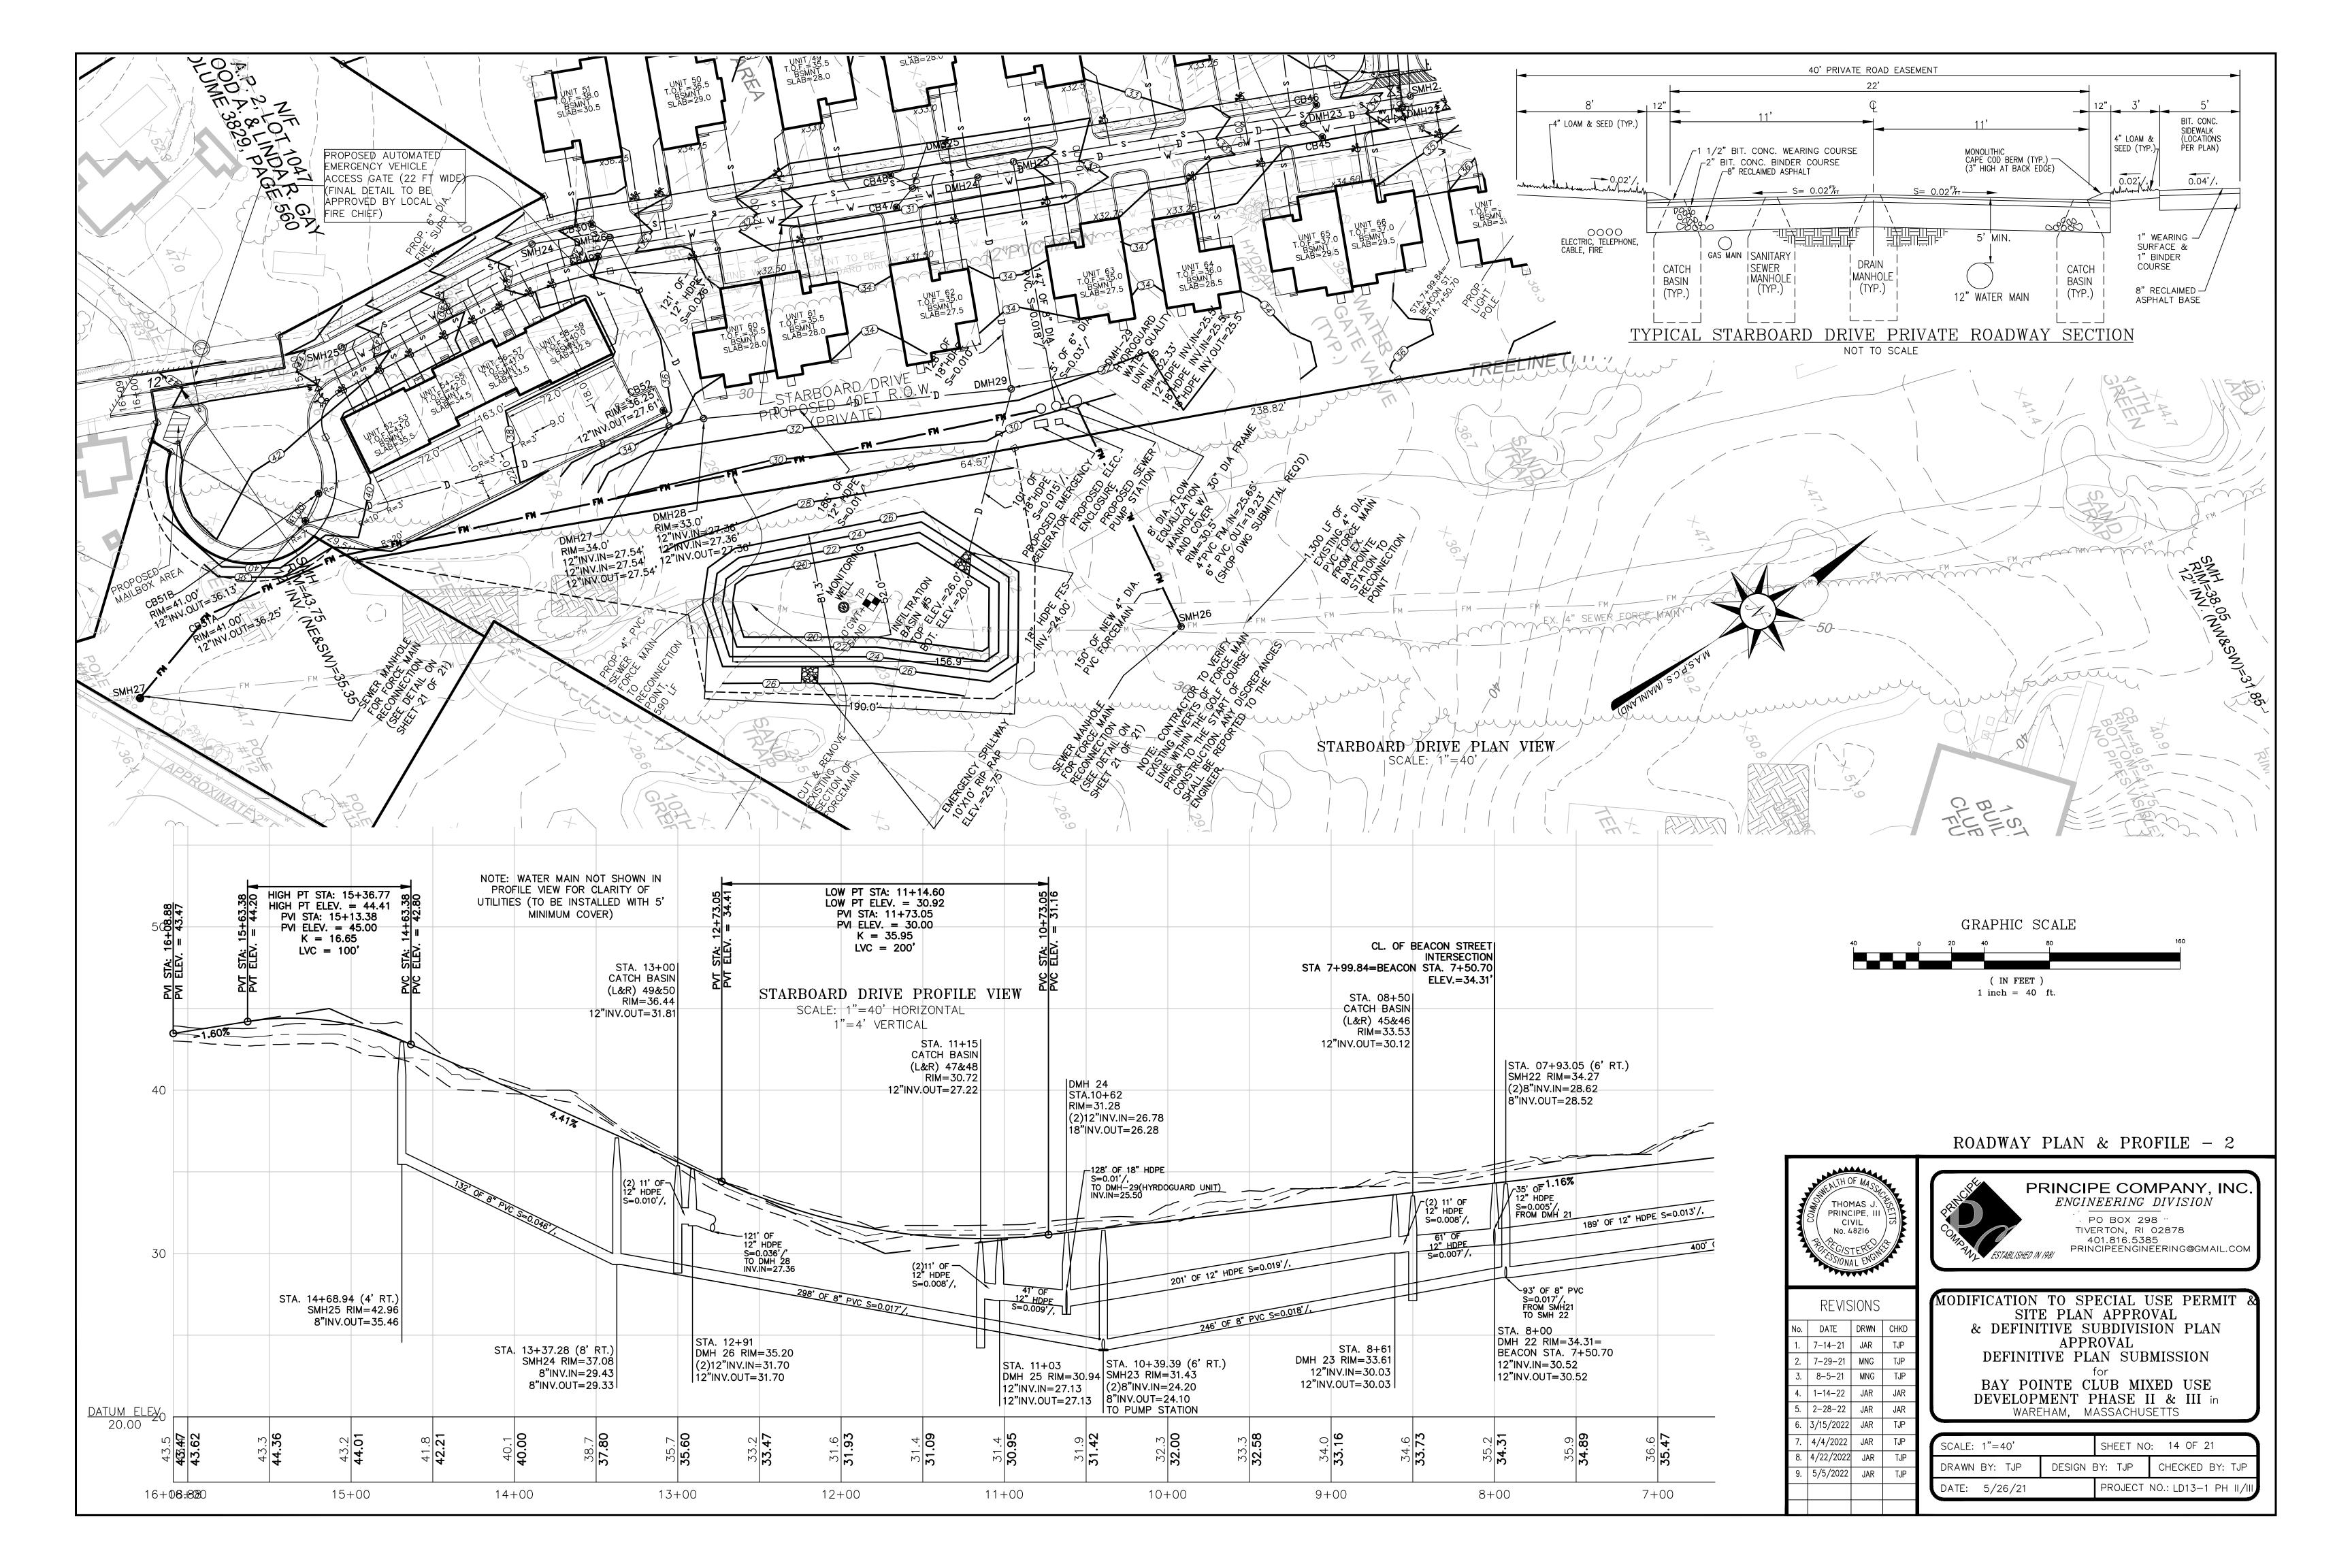

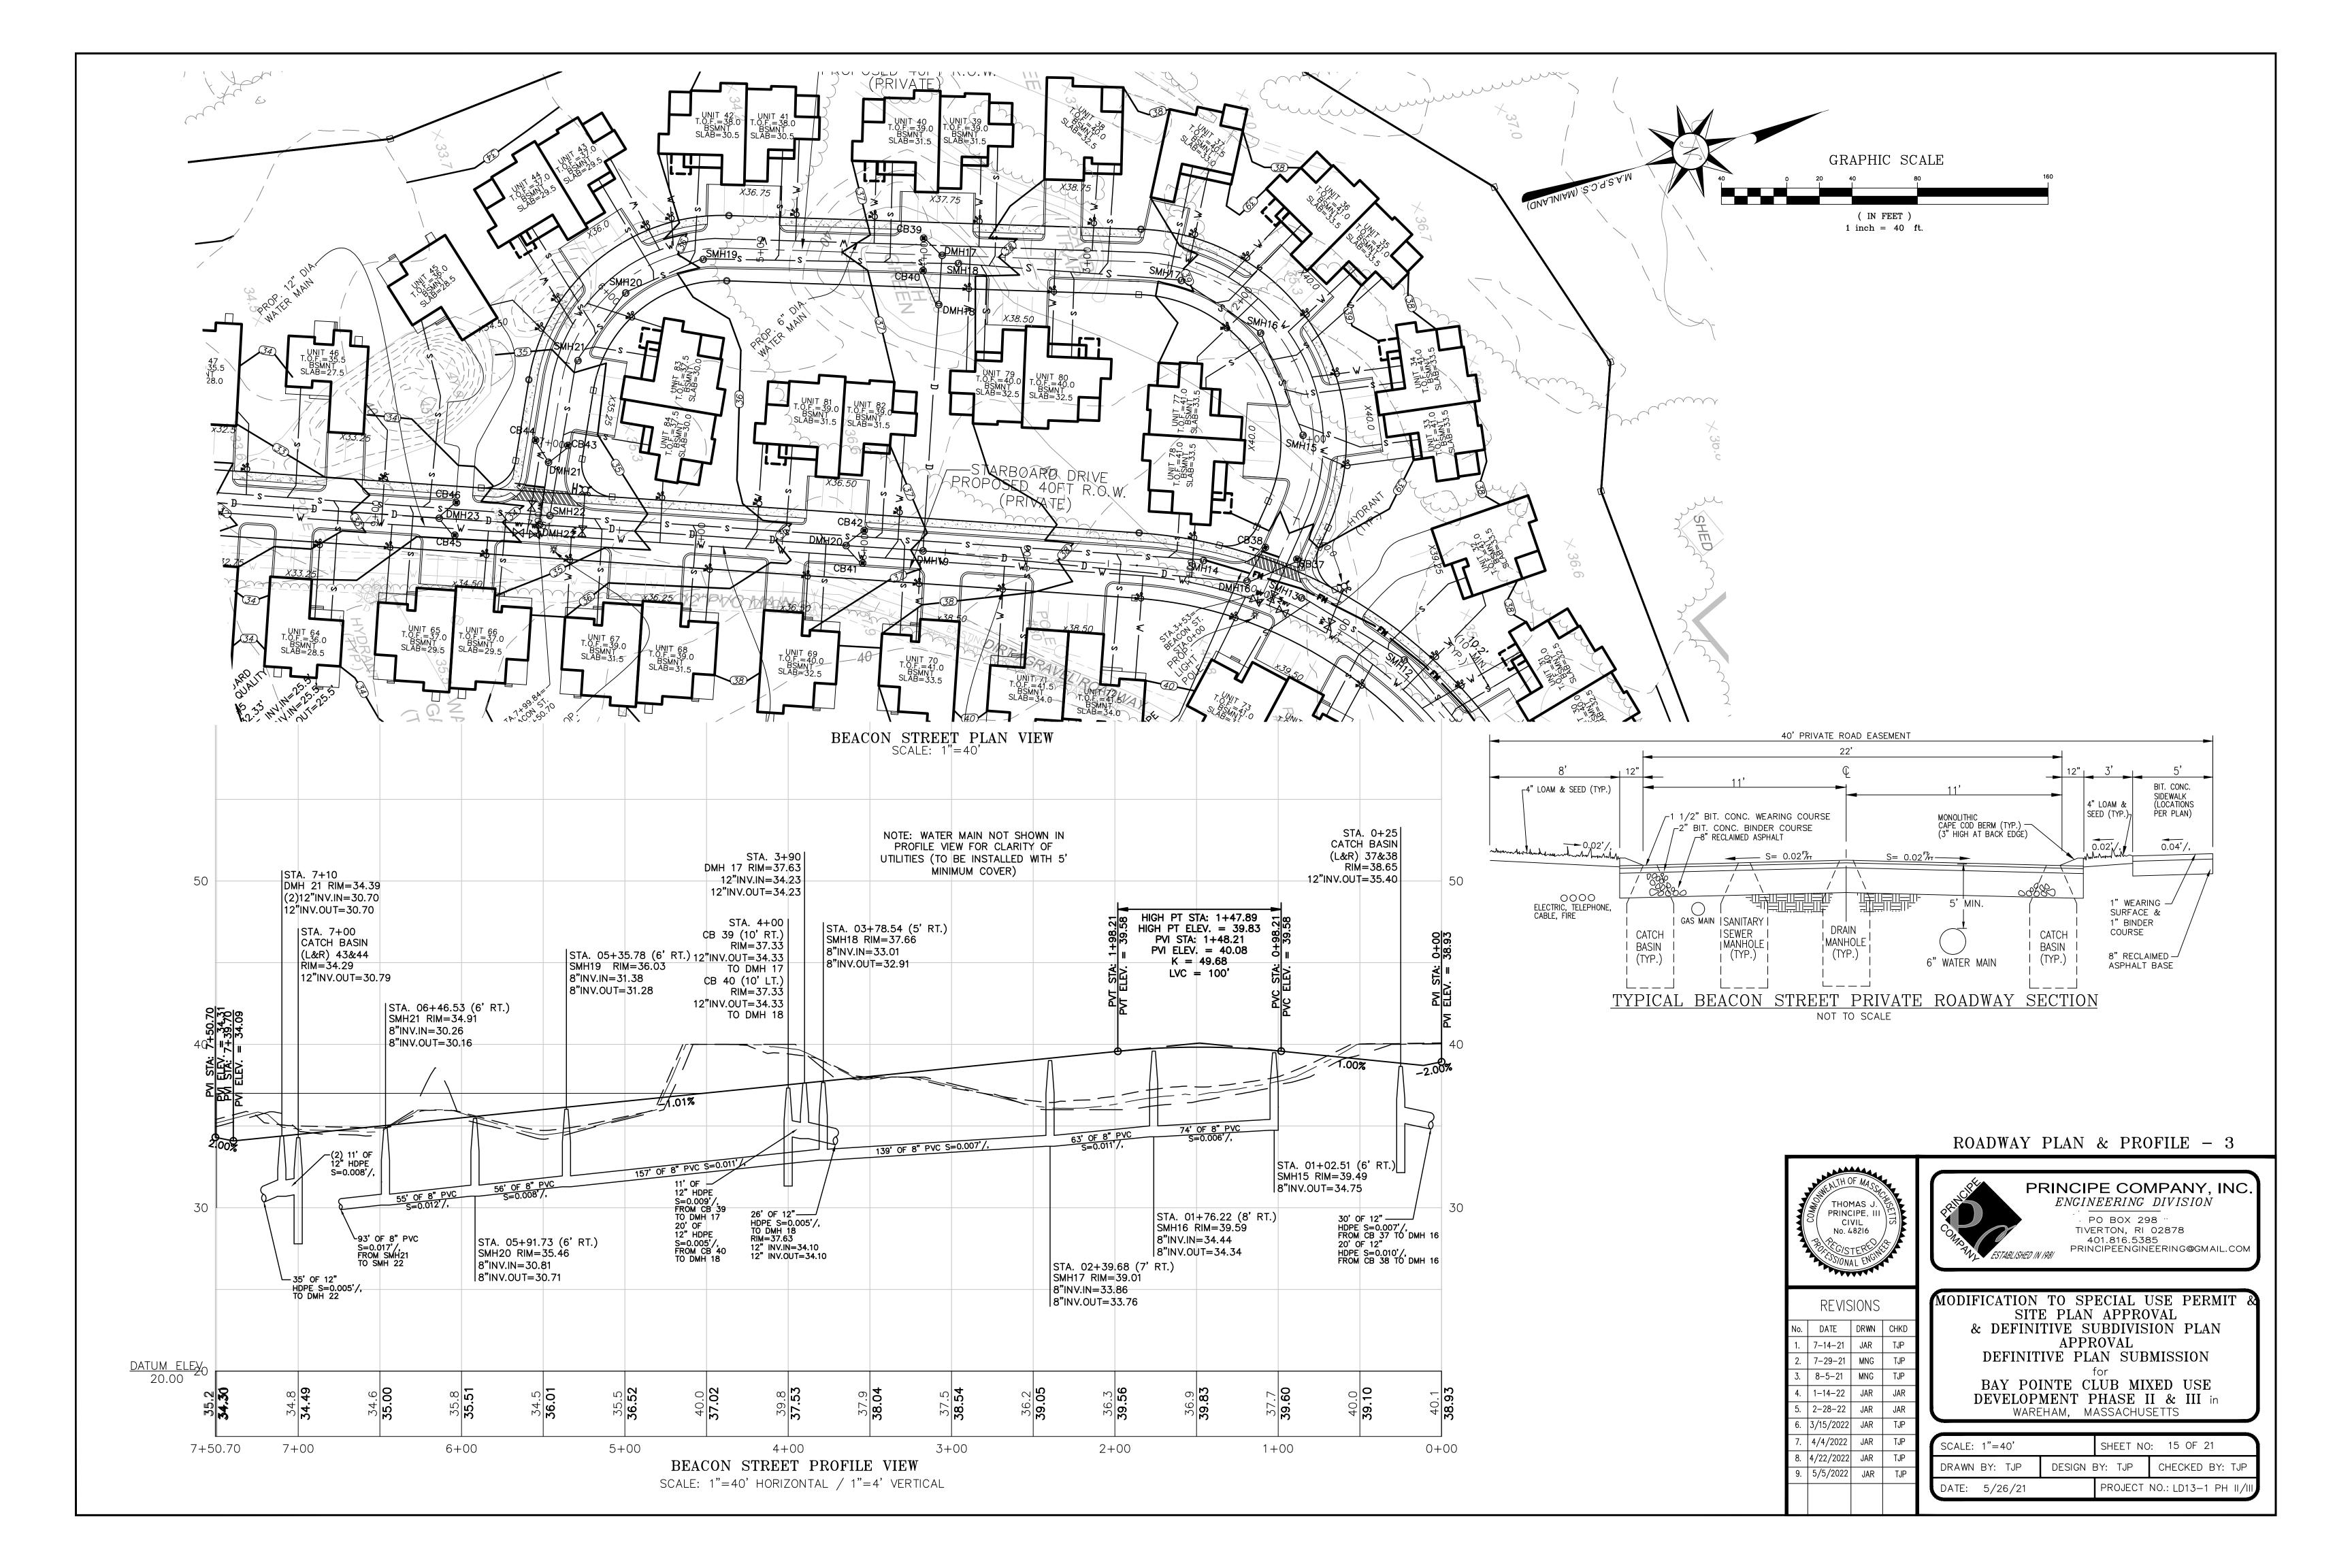

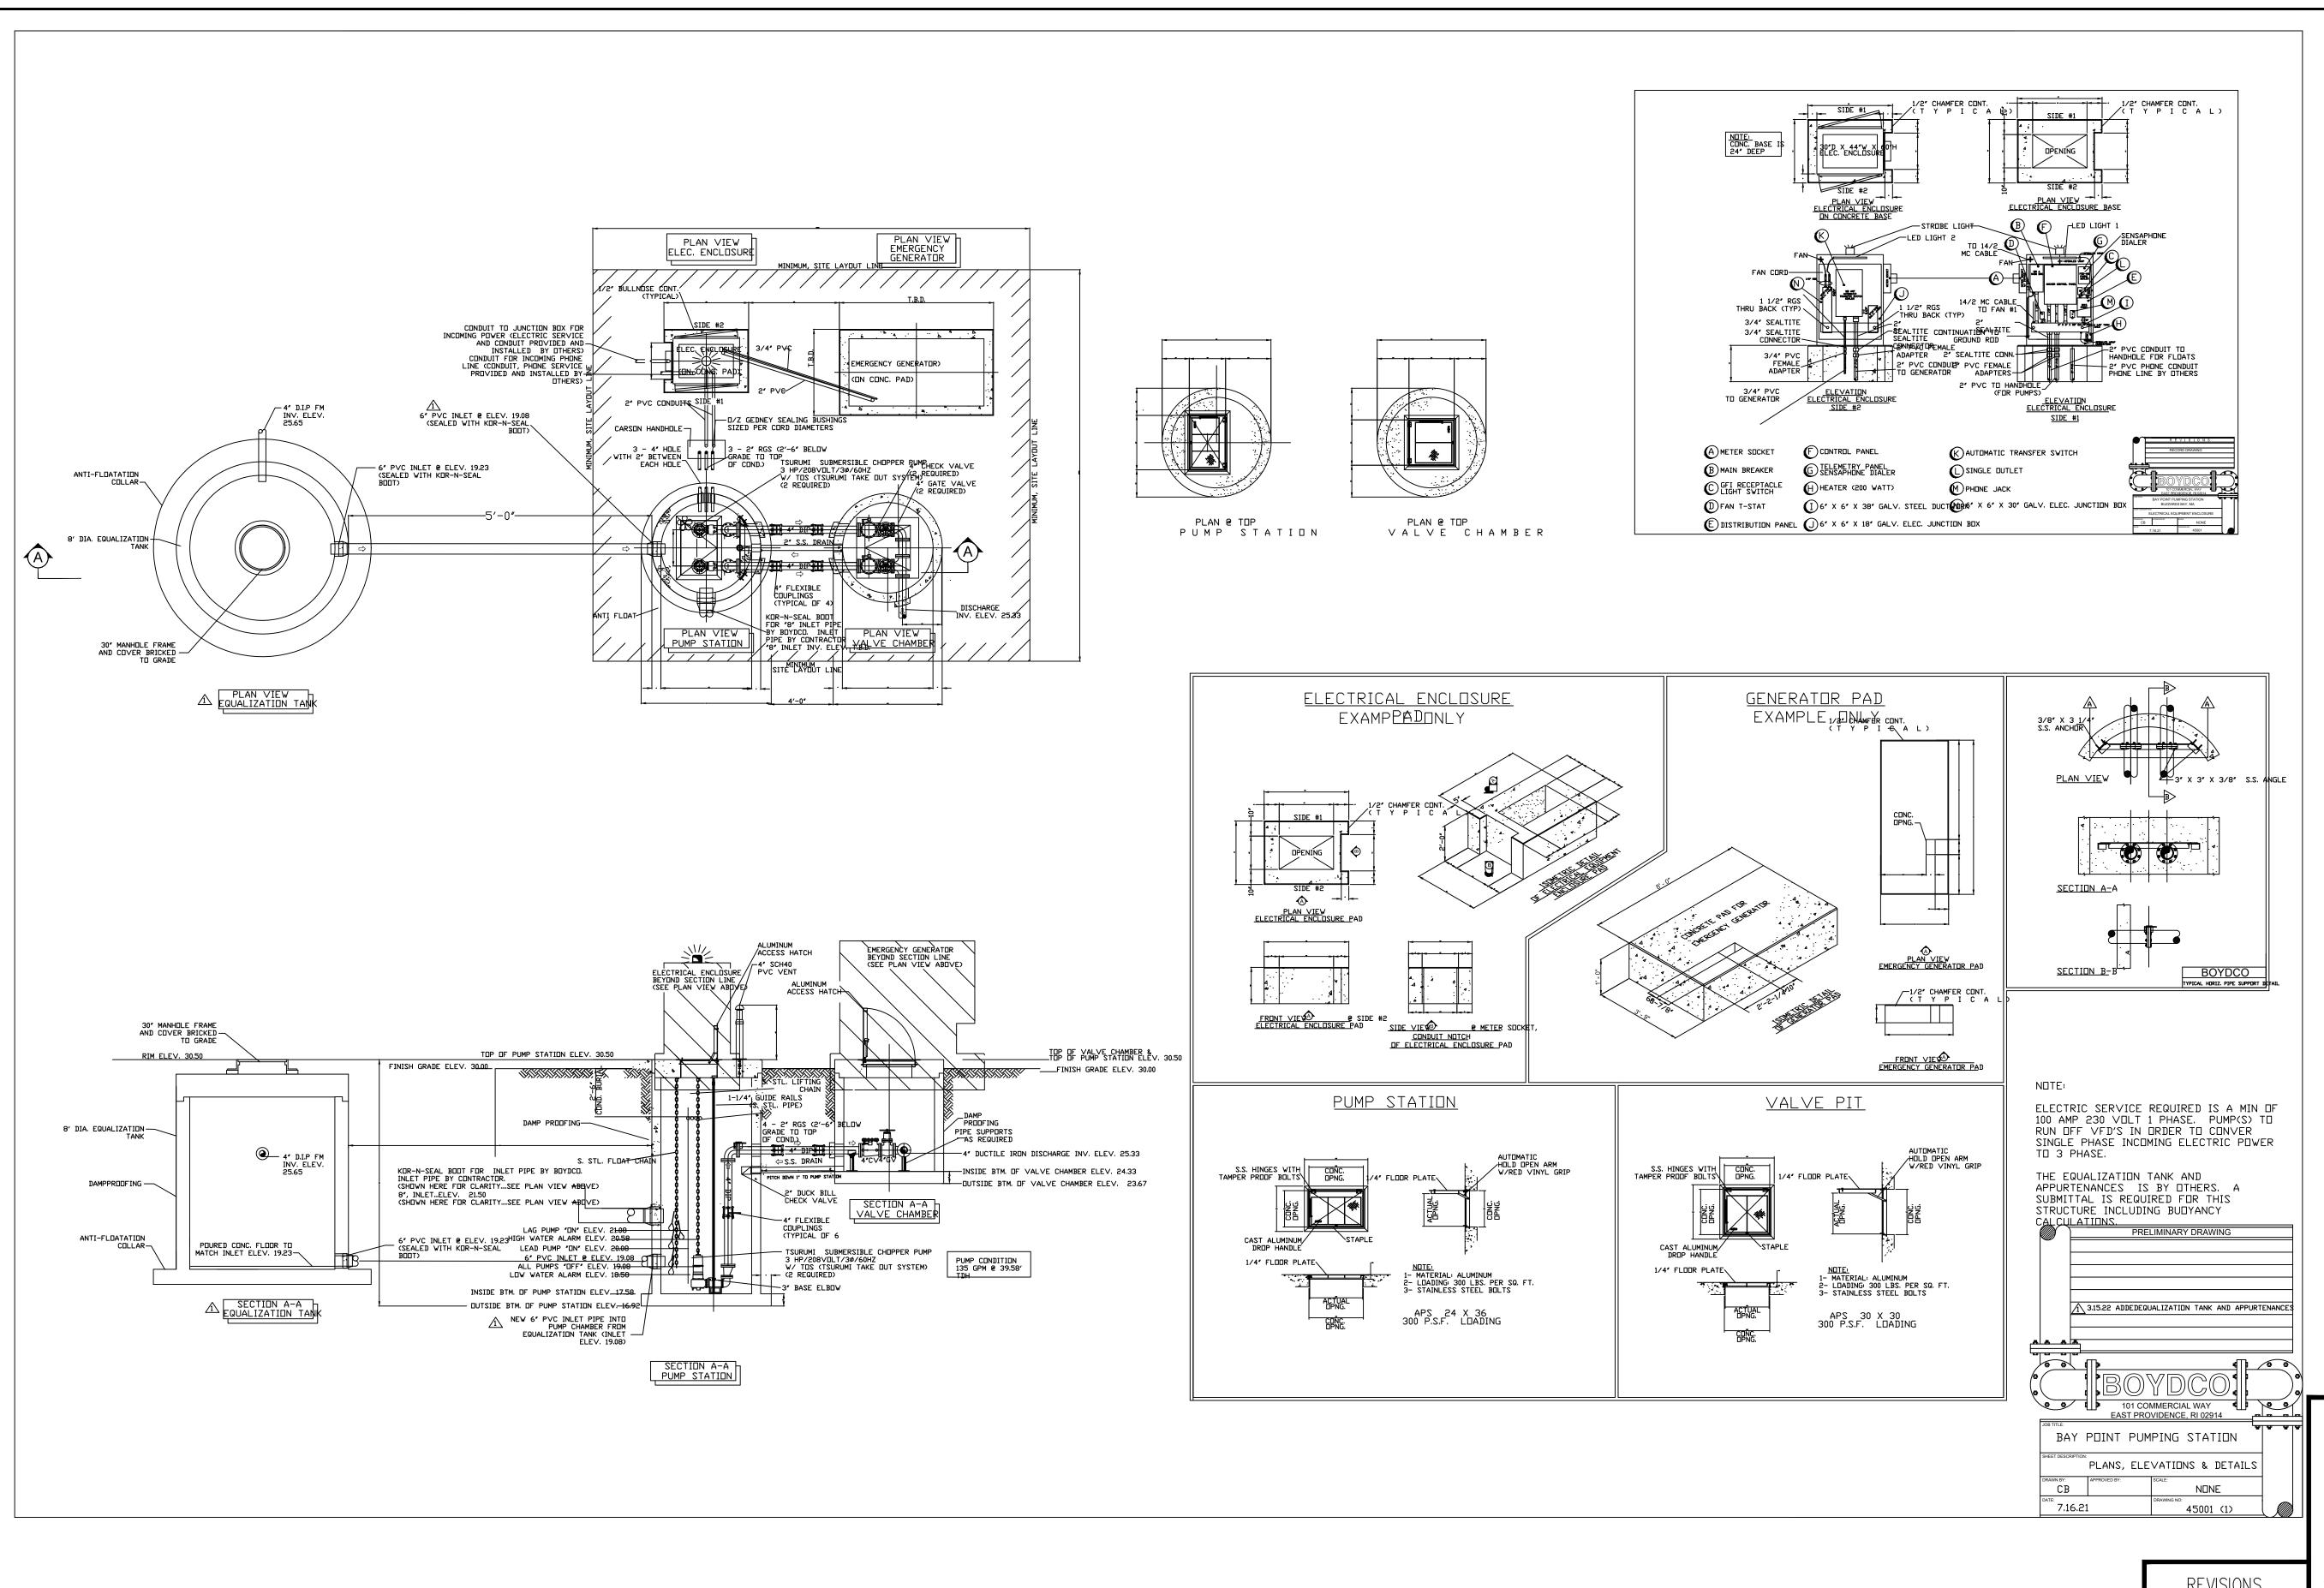

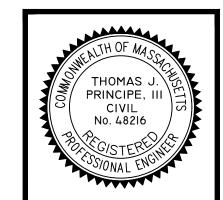

	REVISIONS			
	No.	DATE	DRWN	CHKD
	1.	7-14-21	JAR	TJP
	2.	7-29-21	MNG	TJP
	3.	8-5-21	MNG	TJP
	4.	1-14-22	JAR	JAR
	5.	2-28-22	JAR	JAR
	6.	3/15/2022	JAR	TJP
3	7.	4/4/2022	JAR	TJP
	8.	5/5/2022	JAR	TJP
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DETAIL SHEET - 1



PRINCIPE COMPANY, INC.


ENGINEERING DIVISION

PO BOX 298 TIVERTON, RI 02878 401.816.5385 PRINCIPEENGINEERING@GMAIL.COM


MODIFICATION TO SPECIAL USE PERMIT & SITE PLAN APPROVAL & DEFINITIVE SUBDIVISION PLAN APPROVAL DEFINITIVE PLAN SUBMISSION

BAY POINTE CLUB MIXED USE DEVELOPMENT PHASE II & III in WAREHAM, MASSACHUSETTS

SCALE: AS NOTED	SHEET NO: 16 OF 21			
DRAWN BY: TJP	DESIGN E	BY: TJP	CHECKED BY: TJP	
DATE: 5/26/21		PROJECT	NO.: LD13-1 PH II/III	,

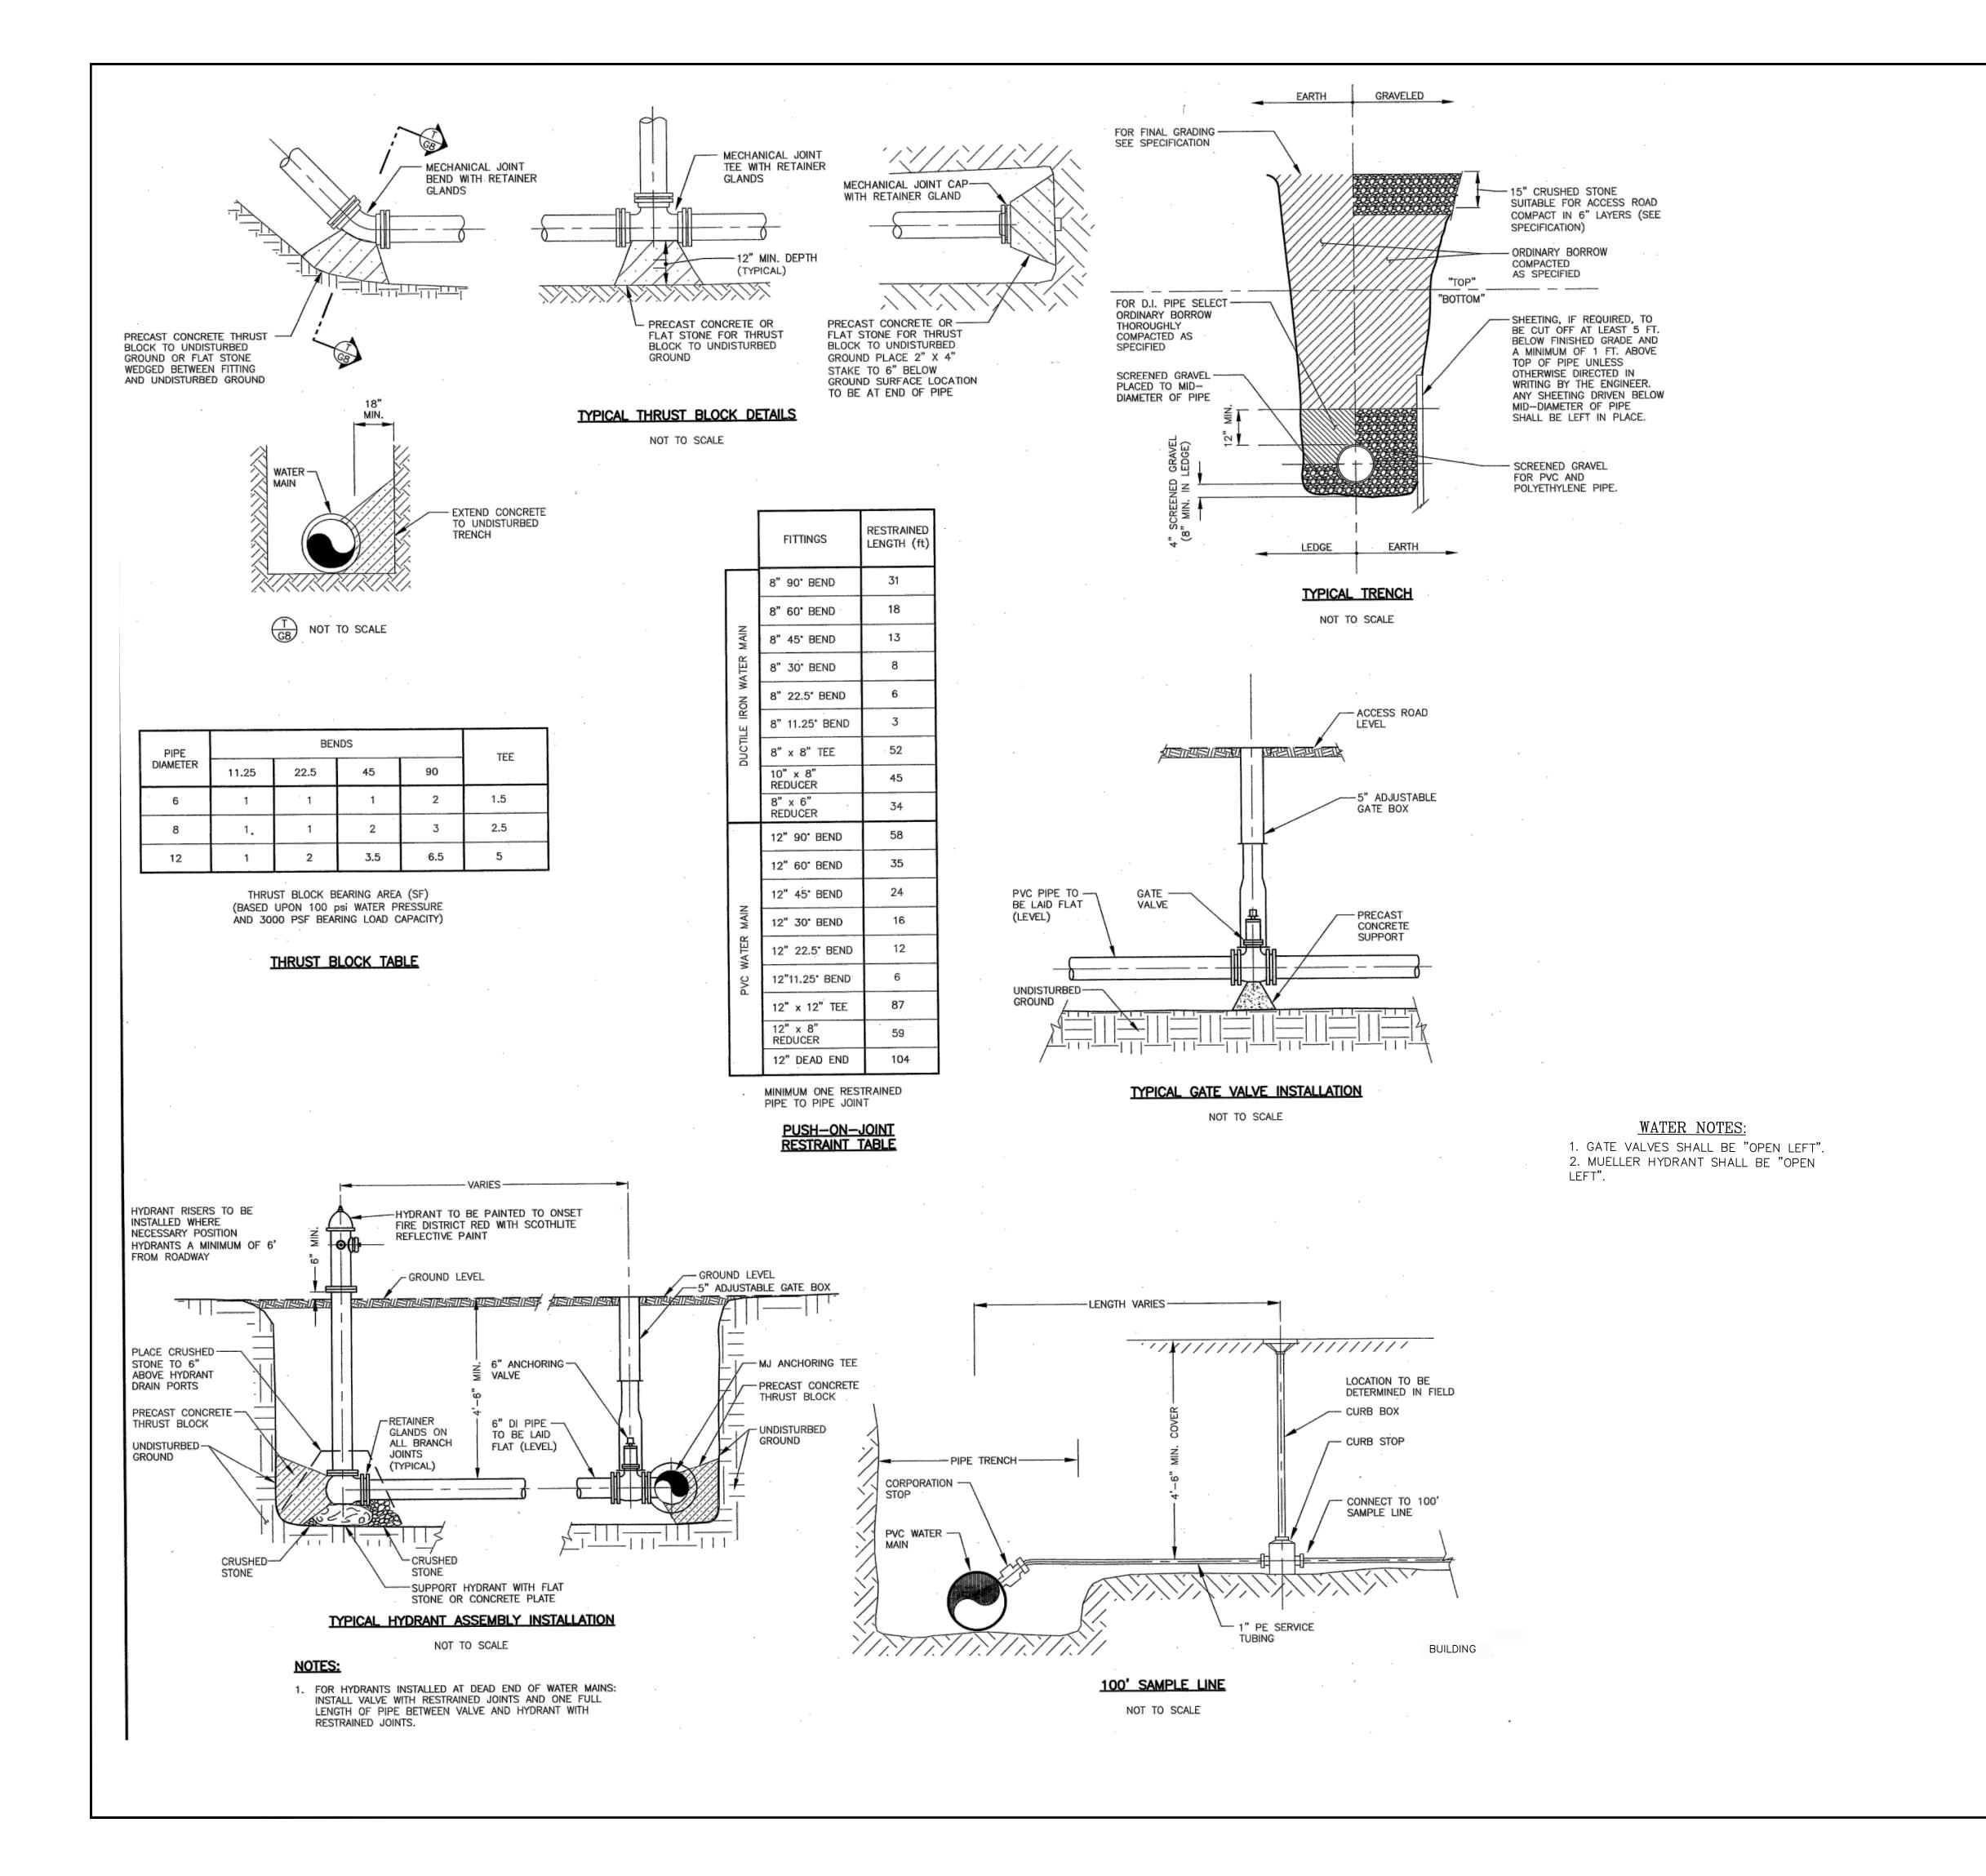

DETAIL SHEET - 2

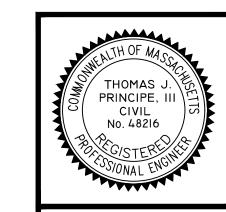

PRINCI ENGI CONINANA ESTABLISHED IN 1981

PRINCIPE COMPANY, INC.

ENGINEERING DIVISION

PO BOX 298
TIVERTON, RI 02878
401.816.5385
PRINCIPEENGINEERING@GMAIL.COM

	I			
No.	DATE	DRWN	CHKD	
1.	7-14-21	JAR	TJP	
2.	7-29-21	MNG	TJP	
3.	8-5-21	MNG	TJP	
4.	1-14-22	JAR	JAR	
5.	2-28-22	JAR	JAR	ll
6.	3/15/2022	JAR	TJP	
7.	4/4/2022	JAR	TJP	

8. | 5/5/2022 | JAR | TJP

MODIFICATION TO SPECIAL USE PERMIT &
SITE PLAN APPROVAL
& DEFINITIVE SUBDIVISION PLAN
APPROVAL
DEFINITIVE PLAN SUBMISSION
for

BAY POINTE CLUB MIXED USE DEVELOPMENT PHASE II & III in WAREHAM, MASSACHUSETTS

1 1	SCALE: AS NOTED		SHEET NO	o: 17 OF 21
	DRAWN BY: TJP	DESIGN E	3Y: TJP	CHECKED BY: TJP
	DATE: 5/26/21		PROJECT	NO.: LD13-1 PH II/III

GENERAL NOTES:

1. IT SHALL BE THE CONTRACTOR'S SOLE RESPONSIBILITY TO FAMILIARIZE HIMSELF WITH ANY APPLICABLE LOCAL, STATE AND FEDERAL LAWS GOVERNING HIS INTENDED ACTIVITIES. OSHA REGULATIONS ARE APPLICABLE OF PROJECT SITE CONSTRUCTION ACTIVITIES.

2. ALL CONSTRUCTION WILL BE UNDERTAKEN IN ACCORDANCE WITH THE APPLICABLE REQUIREMENTS OF THE TOWN OF WARREN.

3. IT SHALL BE THE CONTRACTOR'S SOLE RESPONSIBILITY TO MAINTAIN THE INTEGRITY OF ALL EXISTING UTILITIES, STRUCTURES, AND ABUTTING PROPERTIES. THE COST OF ANY REPAIR OR REPLACEMENT OF DAMAGED ITEMS SHALL BE BORNE BY THE CONTRACTOR.

4. IF THE MUNICIPALITY REQUIRES A PROJECT PRE-CONSTRUCTION CONFERENCE, THE PROJECT DEVELOPER AND THE PROJECT CONTRACTOR WILL ATTEND AND WILL PROVIDE ALL REQUESTED MATERIALS PRIOR TO COMMENCING ANY WORK.

5. IF CEMENT CONCRETE MIX TRUCKS ARE TO BE WASHED OUT ON SITE, THE CONTRACTOR IS RESPONSIBLE FOR ESTABLISHING AND MAINTAINING A WASH OUT AREA WITH APPROPRIATE PROTECTION CONTROLS.

6. THE CONTRACTOR IS RESPONSIBLE FOR PROVIDING AND MAINTAINING COLLECTION AND STORAGE LOCATIONS ON-SITE FOR ALL CONSTRUCTION DEBRIS AND TRASH SO THAT THIS MATERIAL DOES NOT BECOME A NEIGHBORHOOD NUISANCE.


7. ALL REQUIRED SITE IMPROVEMENTS SHALL BE INSPECTED BY THE TOWN ENGINEER TO ENSURE SATISFACTORY COMPLETION. IN NO CASE SHALL THE INSTALLATION OF ANY IMPROVEMENTS BE STARTED UNTIL PRIOR NOTIFICATION IS GIVEN TO THE TOWN ENGINEER. AT LEAST A 48-HOUR NOTICE SHALL BE GIVEN TO THE TOWN ENGINEER PRIOR TO ANY SUCH START OF CONSTRUCTION. A FINAL INSPECTION OF ALL SITE IMPROVEMENTS, UTILITIES AND GRADING WILL BE MADE TO DETERMINE WHETHER THE WORK IS SATISFACTORY AND IN SUBSTANTIAL AGREEMENT WITH THE APPROVED FINAL CONSTRUCTION DRAWING AND THE TOWN SPECIFICATIONS.

8. LOCATION AND DEPTH OF EXISTING UTILITIES ARE APPROXIMATE AND HAVE BEEN PLOTTED FROM THE BEST AVAILABLE INFORMATION. THE CONTRACTOR SHALL CHECK AND VERIFY LOCATIONS OF ALL EXISTING UTILITIES BOTH UNDERGROUND AND OVERHEAD. ANY DAMAGE TO EXISTING UTILITIES AS SHOWN OR NOT SHOWN ON THE PLANS SHALL BE THE CONTRACTOR'S RESPONSIBILITY. COSTS OF SUCH DAMAGE SHALL BE BORNE BY THE CONTRACTOR. NO EXCAVATION SHALL BE DONE UNTIL ALL INVOLVED UTILITY COMPANIES ARE NOTIFIED 48-HOURS IN ADVANCE. THE CONTRACTOR SHALL BE RESPONSIBLE TO NOTIFY DIG-SAFE (1-800-344-7233) A MINIMUM OF 48 WORKING HOURS, EXCLUDING WEEKENDS AND HOLIDAYS, PRIOR TO THE START OF ANY EXCAVATION AND/OR BLASTING WORK. THE NAME OF THE COMPANY PERFORMING THE EXCAVATION AND/OR BLASTING WORK MUST BE SUPPLIED TO DIG-SAFE, IF IT IS DIFFERENT FROM THE CALLER.

9. IT SHALL BE THE CONTRACTOR'S SOLE RESPONSIBILITY TO OBTAIN ANY AND ALL PERMITS REQUIRED BY, BUT NOT LIMITED TO, THE COMMONWEALTH OF MASSACHUSETTS, THE FEDERAL GOVERNMENT, THE TOWN OF NORTH ATTLEBOROUGH AND ALL INDIVIDUAL UTILITY COMPANIES PRIOR TO COMMENCING

10. ALL MATERIAL FOR FILL SHALL BE CLEAN AND FREE OF MATTER WHICH COULD POLLUTE ANY DOWN STREAM WATERCOURSE.

11. FILL MATERIAL SHALL BE COMPACTED IN ONE FOOT (MAXIMUM) LIFTS TO AT LEAST 95% OF THE MAXIMUM DRY DENSITY AS DETERMINED IN ACCORDANCE WITH ASTM D-1557 (MODIFIED PROCTOR TEST).

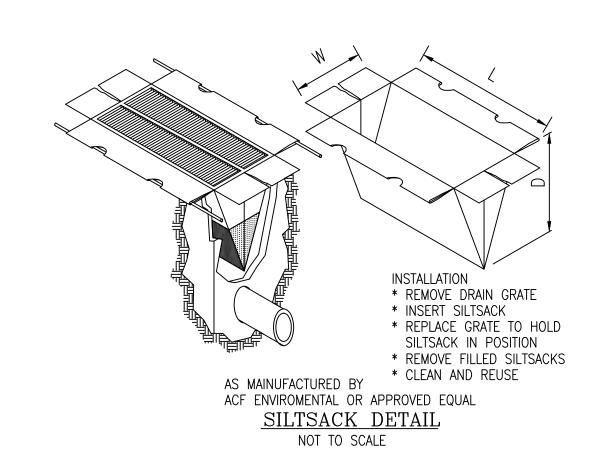

VEGETATIVE COVER AND PLANTING

1. THE NORMAL ACCEPTABLE SEASONABLE SEEDING DATES ARE APRIL 1ST THROUGH OCTOBER 15TH.

2. TOP SOIL FOR PERMANENT OR LONG TERM TEMPORARY SEEDING SHOULD HAVE A SANDY LOAM TEXTURE, RELATIVELY FREE OF SUBSOIL MATERIAL, STONES, ROOTS, LUMPS OF SOIL, TREE LIMBS, TRASH OR CONSTRUCTION DEBRIS. TOP SOIL SHALL CONFORM WITH RHODE ISLAND SPECIFICATIONS M18.01.

3. THE DESIGN SEED MIX UTILIZED IN ALL DISTURBED AREAS TO BE SEEDED SHALL BE COMPRISED OF THE FOLLOWING:


TYPE	% BY WEIGHT	SEEDING DATE
CREEPING RED FESCUE	70	
ASTORIA BENTGRASS	5	APRIL 1 – JUNE 15
BIRDFOOT TREFOIL	15	AUG. 15 — OCT. 15
PERENNIAL RYE GRASS	10	


APPLICATION RATE - 100 LBS PER ACRE


SEED MIX SHALL BE INOCULATED WITHIN 24 - HOURS BEFORE MIXING AND PLANTING, WITH APPROPRIATE INOCULATION FOR EACH SEED VARIETY. ALTERNATE SEED TYPES DUE TO SITE SPECIFIC CONDITIONS AND SOILS ARE ACCEPTABLE WITH THE ENGINEER'S APPROVAL.


4. IN TOPSOIL SEEDING AREAS, THE CONTRACTOR WILL LIME AND FERTILIZE AS REQUIRED TO COMPLIMENT OR UPGRADE SOIL CONDITIONS.


5. THE CONTRACTOR MUST REPAIR AND OR RESEED ANY PERMANENT VEGETATIVE COVER AREAS THAT DO NOT DEVELOP OR WHICH ERODE WITHIN A ONE (1) YEAR PERIOD.

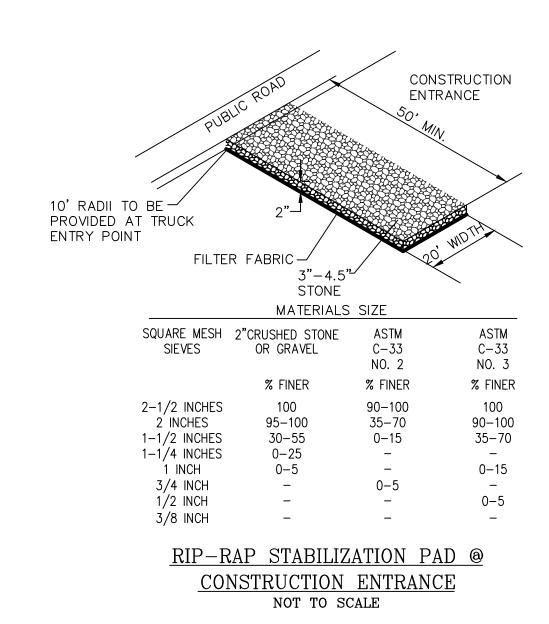

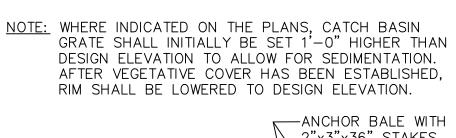

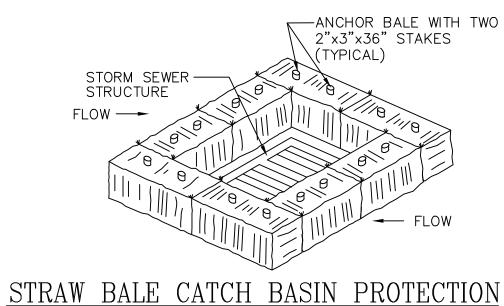

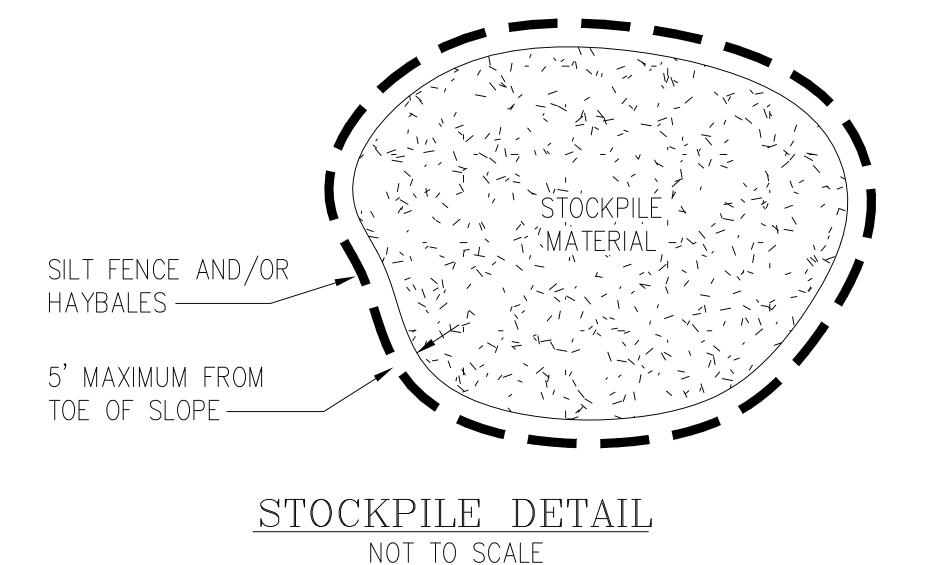


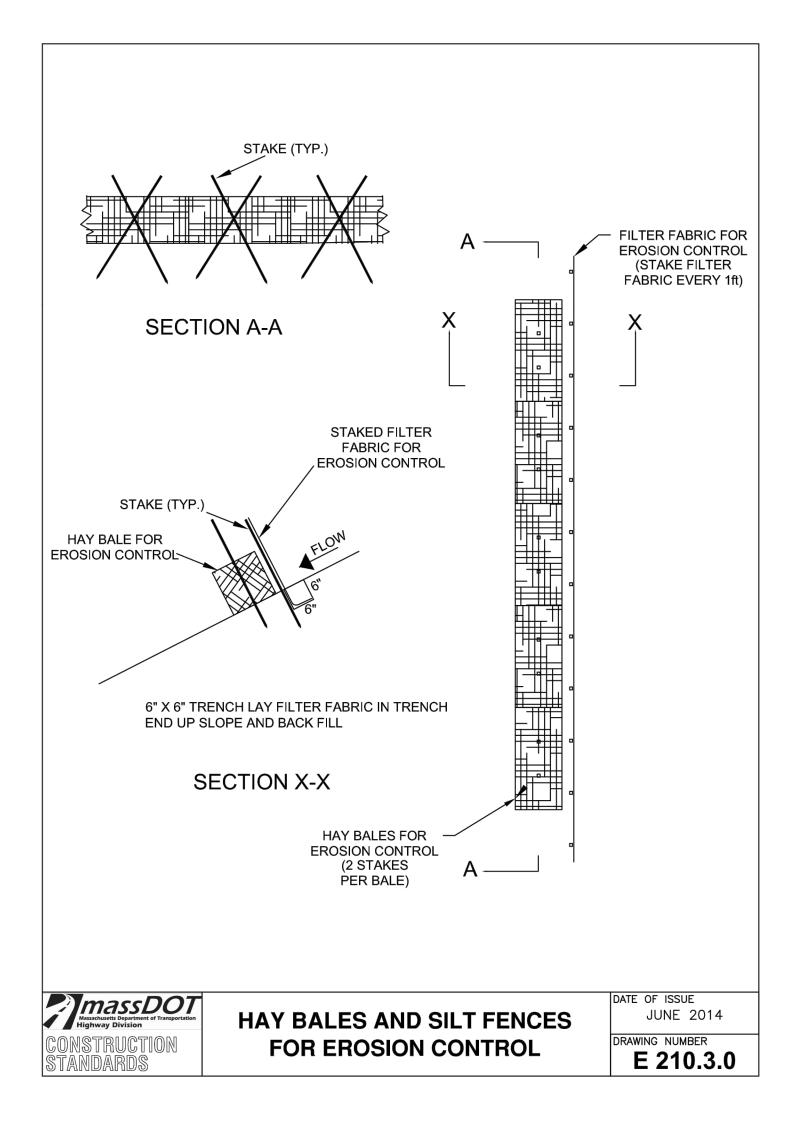

EROSION CONTROL, SOIL STABILIZATION AND SEDIMENT CONTROL PLAN

- 1. PRIOR TO THE COMMENCEMENT OF ANY CLEARING, GRUBBING, DEMOLITION OR EARTHWORK ACTIVITY, TEMPORARY EROSION AND SEDIMENT CONTROL MEASURES AS INDICATED ON THE PLANS ARE TO BE INSTALLED BY THE CONTRACTOR.
- 2. CONSTRUCTION ACCESS STABILIZATION ENTRANCE PADS ARE TO BE INSTALLED PRIOR TO THE COMMENCEMENT OF SITE GRUBBING OR EARTHWORK ACTIVITY.
- 3. EXISTING CATCH BASINS ARE TO BE PROTECTED WITH HAY BALES AND/OR SILT SACS PRIOR TO THE START OF SITE GRUBBING, EARTHWORK OR UNDERGROUND UTILITY AND DRAINAGE INFRASTRUCTURE INSTALLATION TO SERVE THE DEVELOPMENT SITE.
- 4. THE PROJECT CONSTRUCTION SEQUENCE, TO THE EXTENT PRACTICAL, SHOULD REQUIRE THE INSTALLATION OF DOWN GRADE AND OFF SITE STORM DRAINAGE SYSTEM IMPROVEMENTS BEFORE THE START OF SITE GRUBBING AND EARTHWORK ACTIVITY.
- 5. TEMPORARY SITE SLOPE TREATMENTS FOR SOIL STABILIZATION SHALL CONSIST OF HAY, STRAW, FIBER MULCH, RIP RAP OR PROTECTIVE COVERS SUCH AS MAT OR FIBER LINING (BURLAP, JUTE, FIBERGLASS NETTING, AND EXCELSIOR OR EQUAL PRODUCTS). THESE AND OTHER ACCEPTABLE MEASURES SHALL BE INCORPORATED INTO THE SITE WORK AS WARRANTED OR AS ORDERED BY THE ENGINEER.
- 6. CONSTRUCTION SITES ARE DYNAMIC, THE CONTRACTOR IS RESPONSIBLE FOR THE INSTALLATION AND OR MOVEMENT AND MAINTENANCE OF EROSION CONTROLS, SOIL STABILIZATION AND SEDIMENT CONTROL MEASURES AS NEEDED TO MAXIMIZE THE INTENT OF THE PLAN FOR ALL SITE CONDITIONS
- 7. THE CONTRACTOR SHALL BE RESPONSIBLE FOR PERIODIC INSPECTION, MAINTENANCE, REPAIR, AND REPLACEMENT OF EROSION CONTROL DEVICES UNTIL AN ACCEPTABLE PERMANENT VEGETATIVE GROWTH IS ESTABLISHED. THE CONTRACTOR SHALL MAINTAIN A DETAIL LOG OF ALL EROSION CONTROL INSPECTIONS, COMPLAINTS RELATED TO EROSION OR SEDIMENT, AND CORRECTIVE REMEDIAL MEASURES TAKEN THROUGHOUT THE COURSE OF THE PROJECT CONSTRUCTION.
- 8. SOIL EROSION AND SEDIMENT CONTROL IS NOT LIMITED TO DAMAGES CAUSED BY WATER BUT ALSO INCLUDES EROSION AND SEDIMENT RESULTING FROM WINDS. MEASURES, SUCH AS TEMPORARY GROUND COVERS, WATER AND CALCIUM APPLICATIONS ARE TO BE UNDERTAKEN AS NEEDED TO MINIMIZE WIND RELATED SOIL AND DUST CONTROL.
- 9. STOCK PILES OF EARTH MATERIALS SHALL NOT BE LOCATED NEAR WATERWAYS OR WETLANDS. STOCK PILES SHALL HAVE SIDE SLOPES NO GREATER THAN THIRTY PERCENT (30%). STOCK PILES SHALL BE SURROUNDED ON THE DOWN GRADIENT OF THE EXISTING GROUND SURFACE BY HAY BALES OR SILT FENCE. THE STOCK PILES SHALL ALSO BE SEEDED OR STABILIZED IN SOME MANOR TO PREVENT SOIL EROSION.
- 10. THE SMALLEST POSSIBLE SITE AREAS SHALL BE DISTURBED OR EXPOSED AT ONE TIME AND DENUDED SLOPES OR WORK AREAS SHALL NOT BE LEFT EXPOSED FOR EXCESSIVE PERIODS OF TIME, SUCH AS INACTIVE PERIODS OR SITE WORK SHUT DOWNS.
- 11. TO THE EXTENT POSSIBLE, ALL DISTURBED AREAS MUST BE SEEDED OR STABILIZED WITHIN THE CONSTRUCTION SEASON. STABILIZATION OF ONE FORM OR ANOTHER SHALL BE ACHIEVED WITHIN FIFTEEN (15) DAYS OF FINAL GRADING.
- 12. EXPOSED STEEP OR LONG SLOPES SHOULD BE TREATED WITH "CRIMPING" OR "TRACKING" TO REDUCE EROSION AND SEDIMENT AND TO TACK DOWN SEEDING OR MULCH APPLICATIONS.
- 13. IF CONCRETE IS TO BE USED ON SITE, THE CONTRACTOR MUST ESTABLISH AND MAINTAIN SPECIFIC WASHOUT AREAS FOR THE CONCRETE TRUCKS WITH APPROPRIATE PROTECTION CONTROLS.
- 14. THE CONTRACTOR IS RESPONSIBLE FOR PROVIDING AND MAINTAINING COLLECTION AND STORAGE LOCATIONS ON-SITE FOR ALL CONSTRUCTION DEBRIS AND TRASH SO THAT THIS MATERIAL DOES NOT BECOME A NEIGHBORHOOD NUISANCE.
- 15. EXISTING TREES AND VEGETATION WILL BE RETAINED WHENEVER FEASIBLE.
- 16. SITE SOIL EROSION AND SOIL STABILIZATION AND SEDIMENT CONTROLS MUST CONFORM TO ALL REQUIREMENTS OF THE APPLICABLE LOCAL COMMUNITY ORDINANCES AND STATE REGULATIONS.



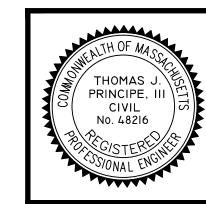

PRINCIPE COMPANY, INC. ENGINEERING DIVISION PO BOX 298 TIVERTON, RI 02878 401.816.5385

REVISIONS DATE DRWN CHKD 7-14-21 JAR 7-29-21 MNG | 8-5-21 | MNG |

MODIFICATION TO SPECIAL USE PERMIT & SITE PLAN APPROVAL & DEFINITIVE SUBDIVISION PLAN APPROVAL DEFINITIVE PLAN SUBMISSION

PRINCIPEENGINEERING@GMAIL.COM

BAY POINTE CLUB MIXED USE DEVELOPMENT PHASE II & III in WAREHAM, MASSACHUSETTS

SCALE: AS NOTED SHEET NO: 18 OF 21 DESIGN BY: TJP CHECKED BY: TJP DRAWN BY: TJP PROJECT NO.: LD13—1 PH II/ DATE: 5/26/21

<u>Introduction</u>

The Hydroguard is a state of the art hydrodynamic separator. Hydrodynamic separators remove solids, debris and lighter than water (oil, trash, floating debris) pollutants from stormwater. Hydrodynamic separators and other water quality measures are mandated by regulatory agencies (Town/City, State, Federal Government) to protect storm water quality from pollution generated by urban development (traffic, people) as part of new development permitting requirements.

As storm water treatment structures fill up with pollutants they become less and less effective in removing new pollution. Therefore it is important that storm water treatment structures be maintained on a regular basis to ensure that they are operating at optimum performance. The Hydroguard is no different in this regard and this manual has been assembled to provide the owner/operator with the necessary information to inspect and coordinate maintenance of their Hydroguard.

Hydroworks® HG Operation

The Hydroworks HG separator is unique since it treats both high and low flows in one device, but maintains separate flow paths for low and high flows. Accordingly, high flows do not scour out the fines that are settled in the low flow path since they are treated in a separate area of the device as shown in Figure 1.


The HG separator consists of three chambers:

1. an inner chamber that treats low or normal flows 2. a middle chamber that treats high flows

3. an outlet chamber where water is discharged to the downstream storm system

Under normal or low flows, water enters the middle chamber and is conveyed into the inner chamber by momentum. Since the inner chamber is offset to one side of the structure the water strikes the wall of the inner chamber at a tangent creating a vortex within the inner chamber. The vortex motion forces solids and floatables to the middle of the inner chamber. The water spirals down the inner chamber to the outlet of the inner chamber which is located below the inlet of the inner chamber and adjacent to the wall of the structure but above the floor of the structure. Floatables are trapped since the outlet of the inner chamber is submerged. The design maximizes the retention of settled solids since solids are forced to the center of the inner chamber by the vortex motion of water while the outlet of the inner chamber draws water from the wall of the inner chamber.

The water leaving the inner chamber continues into the middle chamber, again at a tangent to the wall of the structure. The water is then conveyed through an outlet baffle wall (high and low baffle). This enhances the collection of any floatables or solids not removed by the inner chamber. Water flowing through the baffles then enters the outlet chamber and is discharged into the downstream storm drain.

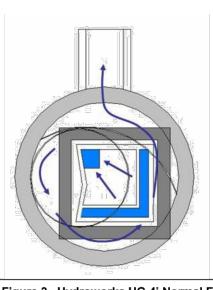

During periods of peak flow the water will back up from the corner inlet and overflow into two side overflow troughs which discharge directly into the middle chamber. These overflow troughs are covered from the surface such that water cannot directly fall through them (i.e. water must back up to enter the overflow troughs).

Accordingly this funnel provides the same separate flow paths for low and high flow as the other Hydroguard separators.

The whole funnel is removed for inspection and cleaning providing.

Figure 3. Hydroworks HG 4i Normal Flow Path

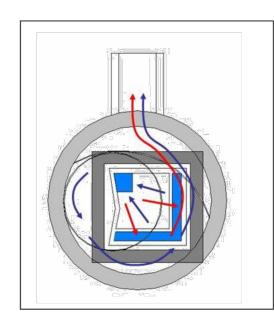


Figure 4. Hydroworks HG 4i Peak Flow Path

Post-Construction Period

The Hydroguard was independently tested by Alden Research Laboratory in 2008. A HG6 was tested for scour with initial sediment loads of 4.6 ft³ and 9.3 ft³. The results from these tests were almost identical. Therefore, the 9.3 ft³ sediment load was used as 50% of the maximum sediment depth for maintenance in the calculation of the maintenance interval for the HG6 separator based on the NJDEP maintenance interval

Maintenance Interval (months) = 3.565 x (Sediment Storage) / (MTFR x TSS Removal)

All values (flow, sediment storage) can be scaled by the surface area making the

Maintenance Interval (HG6) = $3.565 \times 9.3 / (1.81 \times 0.60) = 30$ months

sediment depths and maintenance intervals equal for all separators.

The separator was loaded with the sediment in the inner chamber and middle chamber with the majority of sediment (80%) located in the inner chamber. The inner chamber for area represents approximately 44% of the separator surface area. The inner chamber is 4 ft (1200 mm) in diameter in the HG6. Therefore the 50% sediment depth for the HG6 in the inner chamber would be:

9.3 ft³ x 0.80 / (3.14 x 4 ft²) x 12 in/ft = 7.1 inches (175 mm)

Accordingly the 100% sediment volume would represent 14.2" (350 mm) of sediment depth in the inner chamber.

The HG separator must be maintained if there is an appreciable depth of oil in the unit (more than a sheen) or if floatables other than oil cover over 50% of the open water surface on the inlet side of the outlet baffle wall. It should also be maintained once the accumulated TSS/sediment depths are greater than 14" (350 mm) in the inner chamber. For typical stabilized post-construction sites (parking lots, streets) it is anticipated that maintenance will be required annually or once every two years. More frequent or less frequent maintenance will be required depending on individual site conditions (traffic use, stabilization, storage piles, etc.). The long term maintenance frequency can be established based on the maintenance requirements during the first several years of operation if site conditions do not change.

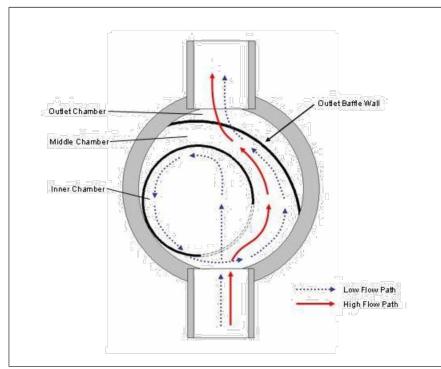


Figure 1. Hydroworks HG Operation – Plan View

During high flows, the flow rate entering the inner chamber is restricted by the size of the inlet opening to the inner chamber. This restriction of flow rate into the inner chamber prevents scour and re-suspension of solids from the inner chamber during periods of high flow. This is important since fines, which are typically considered highly polluted, are conveyed during low/normal flows.

The excess flow is conveyed directly into the middle chamber where it receives treatment for floatables and solids via the baffle system. This treatment of the higher flow rates is important since trash and heavier solids are typically conveyed during periods of higher flow rates. The Hydroworks HG separator is revolutionary since it incorporates low and high flow treatment in one device while maintaining separate low and high flow paths to prevent the scour and re-suspension of fines.

Figure 2 is a profile view of the HG separator showing the flow patterns for low and high

Although all parts of the Hydroguard should be inspected, inspection and maintenance should focus on the inner and middle chambers since this is where the pollutants (floatable and sinking) will accumulate.

A visual inspection can be conducted for floatables by removing the covers and looking down into the separator. Multiple covers are provided on Hydroworks HG units to access all areas of the separator (The HG 4 may have a single larger 32" (800mm) cover due to the lack of space for multiple 24" (600mm) covers). Separators with an inlet grate (HG4i or custom separator) will have a plastic funnel located under the grate or on the top cap of the concrete that must be removed through the frame prior to inspection or maintenance. If you are missing a funnel please contact Hydroworks at the numbers provided at the end of this document.

TSS/Sediment

Inspection for TSS build-up can be conducted using a Sludge Judge®, Core Pro®, AccuSludge® or equivalent sampling device that allows the measurement of the depth of TSS/sediment in the unit. These devices typically have a ball valve at the bottom of the tube that allows water and TSS to flow into the tube when lowering the tube into the unit. Once the unit touches the bottom of the device, it is quickly pulled upward such that the water and TSS in the tube forces the ball valve closed allowing the user to see a full core of water/TSS in the unit. The unit should be inspected for TSS through each of the access covers. Several readings (2 or 3) should be made at each access cover to ensure that an accurate TSS depth measurement is recorded.

Construction Period

The HG separator should be inspected every two weeks and after every large storm (over 0.5" (12.5 mm) of rain) during the construction period.

Post-Construction Period

The Hydroworks HG separator should be inspected once per year for normal stabilized sites (grassed or paved areas). If the unit is subject to oil spills or runoff from unstabilized (storage piles, exposed soils) areas the HG separator should be inspected more frequently (4 times per year). The initial annual inspection will indicate the required future frequency of maintenance if the unit was maintained after the construction period.



HYDROGUARD INSPECTION SHEET

Date of Last Inspection			
Site City State Owner			
GPS Coordinates			
Date of last rainfall			
Site Characteristics Soil erosion evident Exposed material storage Large exposure to leaf litte High traffic (vehicle) area		Yes No □ □ □ □ □ □ □ □)
Floating debris in the sepa Large debris visible in the Concrete cracks/deficience Exposed rebar Water seepage (water leve	r outlet ints al components or outlet pipes ge (cracked, broken, loose pieces arator (oil, leaves, trash) separator ies	Yes No	•
Routine Measurements Floating debris depth Floating debris coverage Sludge depth	< 0.5" (13mm)	>0.5" 13mm)	*

Please call Hydroworks at 888-290-7900 or email us at support@hydroworks.com if you have any questions regarding the Inspection Checklist. Please fax a copy of the completed checklist to Hydroworks at 888-783-7271 for our records.

Maintenance required Repairs required

*** Further investigation is required

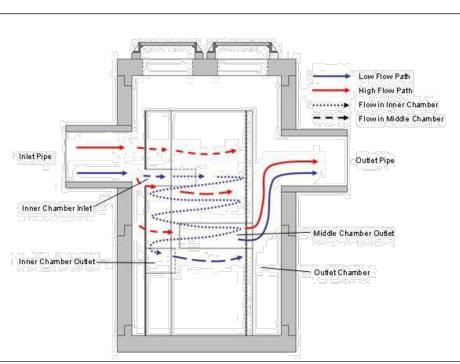


Figure 2. Hydroworks HG Operation – Profile View

The HG 4i is an inlet version of the HG 4 separator. There is a catch-basin grate on top of the HG 4i. Water flows directly into the inner chamber of the HG 4i through the catchbasin grate on top of the structure. The grate is oversized to allow maintenance of the entire structure. A funnel that sits underneath the grate on the top cap of the concrete itself directs the water into the inner chamber during normal flows and the middle chamber during high flows. Figures 3 and 4 show the flow paths for the HG 4i separator.

The inlet funnel is sloped towards the corner inlet and hence the wall of the inner chamber. Water moves in a circular direction in the inner chamber since water enters tangentially along the wall of the inner chamber due to the sloping funnel.

Water continues moving in a circular motion (vortex) through the rest of the structure (through the middle chamber and baffle wall) until it is discharged from the separator.

Reports should be prepared as part of each inspection and include the following information:

- 1. Date of inspection 2. GPS coordinates of Hydroworks unit
- 3. Time since last rainfall
- 4. Date of last inspection
- 5. Installation deficiencies (missing parts, incorrect installation of parts) 6. Structural deficiencies (concrete cracks, broken parts)
- 7. Operational deficiencies (leaks, blockages) 8. Presence of oil sheen or depth of oil layer
- 9. Estimate of depth/volume of floatables (trash, leaves) captured
- Sediment depth measured
- 11. Recommendations for any repairs and/or maintenance for the unit 12. Estimation of time before maintenance is required if not required at time of

A sample inspection checklist is provided at the end of this manual.

Procedure

The Hydroworks HG unit is typically maintained using a vactor truck or clam shell bucket. There are numerous companies that can maintain the HG separator. Envirocalm, LLC, an affiliate company of Hydroworks offers inspection and maintenance services and can inspect and maintain the HG separator. (www.envirocalm.com).


Disposal of the contents of the separator depend on local requirements. Maintenance of a Hydroworks HG unit will typically take 1 to 2 hours.


Frequency

Construction Period

A HG separator can fill with construction sediment quickly during the construction period. The Hydroguard must be maintained during the construction period when the depth of TSS/sediment reaches 30" (750 mm). It must also be maintained during the construction period if there is an appreciable depth of oil in the unit (more than a sheen) or if floatables other than oil cover over 50% of the open water surface on the inlet side of the outlet baffle wall.


The HG separator should be maintained at the end of the construction period, prior to operation for the post-construction period.

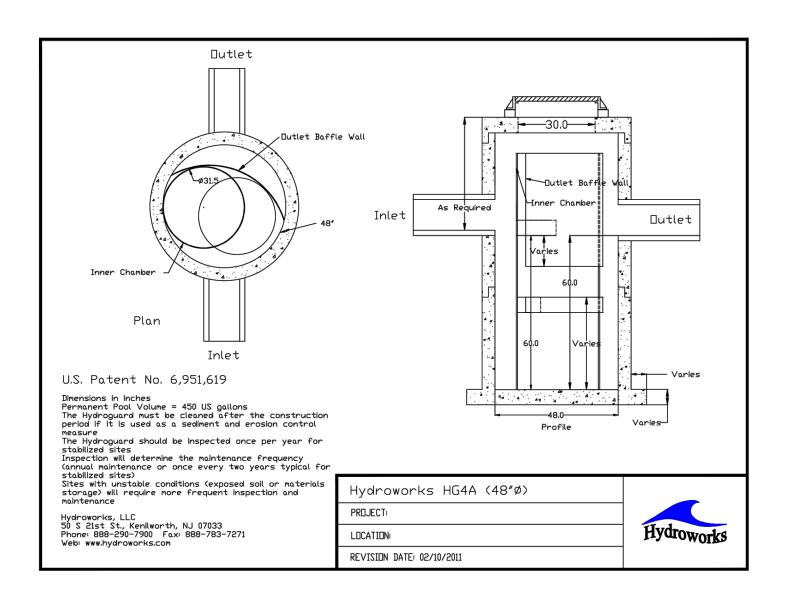

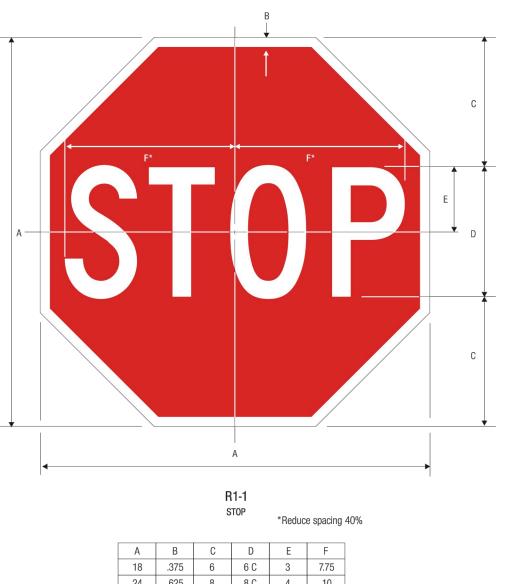

COLORS: LEGEND — WHITE (RETROREFLECTIVE) BACKGROUND - RED (RETROREFLECTIVE) DETAIL SHEET - 4

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REVISIONS						
No.	DATE	DRWN	CHKD			
1.	7-14-21	JAR	TJP			
2.	7-29-21	MNG	TJP			
3.	8-5-21	MNG	TJP			

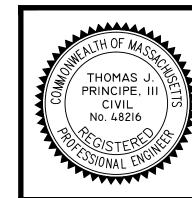MODIFICATION TO SPECIAL USE PERMIT & SITE PLAN APPROVAL & DEFINITIVE SUBDIVISION PLAN APPROVAL DEFINITIVE PLAN SUBMISSION

> BAY POINTE CLUB MIXED USE DEVELOPMENT PHASE II & III in WAREHAM, MASSACHUSETTS

SCALE: AS NOTED		SHEET NO	o: 19 OF 21
DRAWN BY: TJP	DESIGN E	BY: TJP	CHECKED BY: TJP
DATE: 5/26/21	DATE: 5/26/21		NO.: LD13-1 PH II/III

STORM DRAINAGE SYSTEM MAINTENANCE PLAN:

THE FOLLOWING LIST OF MAINTENANCE TASKS AND FREQUENCIES MUST BE ADHERED TO IN ORDER TO INSURE A SUCCESSFUL LONG TERM OPERATION OF THE STORM DRAINAGE SYSTEM.

1. DURING CONSTRUCTION ACTIVITIES ALL EROSION CONTROLS ON THE SITE SHALL BE INSPECTED AT LEAST ONCE EVERY SEVEN (7) CALENDAR DAYS AND WITHIN TWENTY FOUR (24) HOURS AFTER AN EVENT WHICH GENERATES AT LEAST 0.25 INCHES OF RAIN IN A TWENTY FOUR (24) HOUR PERIOD.

2. SEDIMENTS SHALL BE REMOVED FROM ALL BASINS IMMEDIATELY AFTER SITE STABILIZATION.

3. ALL TRASH, LITTER AND OTHER DEBRIS SHALL BE REMOVED FROM ALL STORM WATER INLET AND OUTLET STRUCTURES A MINIMUM OF TWICE PER YEAR. THESE STRUCTURES SHALL ALSO BE INSPECTED TWICE PER YEAR. INSPECTIONS SHALL BE PERFORMED SEVERAL TIMES WITHIN THE FIRST SIX MONTHS OF OPERATION.

4. INSPECTIONS OF ALL CATCH BASINS SHALL OCCUR ON AN ANNUAL BASIS TO CHECK FOR DEBRIS REMOVAL (SEDIMENT AND HYDROCARBONS) AND STRUCTURAL INTEGRITY OR DAMAGE. SUCH DEFICIENCIES SHALL BE CORRECTED IMMEDIATELY.

5. REPAIRS OR REPLACEMENT OF INLET/OUTLET STRUCTURES OR ANY ELEMENT OF THE FACILITY SHALL BE DONE WITHIN THIRTY (30) DAYS OF DEFICIENCY REPORTS. IF AN EMERGENCY SITUATION IS IMMINENT THEN REPAIR/REPLACEMENT SHALL BE DONE IMMEDIATELY TO AVERT FAILURE OR DANGER TO NEARBY

6. MAKE REPAIRS IMMEDIATELY USING APPROPRIATE STONE SIZES. DO NOT PLACE STONES ABOVE FINISHED GRADE.

7. ALL REMOVED SEDIMENTS AND DEBRIS SHALL BE DISPOSED OF OFF SITE IN ACCORDANCE WITH STATE AND LOCAL REGULATIONS.

8. ALL OUTLET STRUCTURES AND OUTFLOW CHANNELS WILL BE INSPECTED ANNUALLY. INSPECTIONS WILL BE ACCOMPLISHED SEVERAL TIMES DURING THE FIRST SIX MONTHS OF OPERATION, ESPECIALLY AFTER RAINFALL EVENTS TO CHECK FOR CLOGGING OR, CONVERSELY, TOO RAPID OF A RELEASE.

9. REPAIRS OR REPLACEMENT OF INLET/OUTLET STRUCTURES, RIP-RAP CHANNELS, FENCES, OR OTHER ELEMENTS OF THE FACILITY WILL BE DONE WITHIN 30 DAYS OF DEFICIENCY REPORTS. IF AN EMERGENCY SITUATION IS IMMINENT THEN REPAIR/REPLACEMENT MUST BE DONE IMMEDIATELY TO AVERT FAILURE OR DANGER TO NEARBY RESIDENTS.

10. ALL SEDIMENT GENERATED DURING CONSTRUCTION AND AS A RESULT OF MAINTENANCE OF THE DRAINAGE SYSTEM MUST BE DISPOSED OF PROPERLY. SEDIMENT SHALL NOT BE DISPOSED OF IN OR NEAR STATE OR FEDERAL REGULATED WATERS.

11. ADDITIONAL BMP INSPECTION/MAINTENANCE MEASURES OUTLINED WITHIN THE PROJECT STORMWATER POLUTION PREVENTION PLAN SHALL BE ADHERED TO.

DRAINAGE <u>AND UTILITY NOTES:</u>

1. UTILITY LOCATION VERIFICATION IS TO INCLUDE TEST HOLES AS NEEDED.


2. WATER MAINS AND APPURTENANCES, INCLUDING SERVICE CONNECTIONS SHALL BE INSTALLED IN CONFORMITY WITH THE SPECIFICATIONS OF THE ONSET WATER DEPARTMENT AND IN ACCORDANCE WITH THE TOWN'S MASTER OR STUDY WATER PLAN.


3. THE CONTRACTOR IS REQUIRED TO SCHEDULE AND COORDINATE WATER SERVICE INSTALLATIONS, SHUT DOWNS AND DISRUPTIONS WHICH AFFECT THE SITE AND SITE ADJACENT USERS WITH THE LOCAL WATER AUTHORITY AND THE LOCAL FIRE DEPARTMENT.

4. UNDERGROUND UTILITIES, ELECTRIC, TELEPHONE, FIRE ALARM CABLE, TELEVISION AND GAS SERVICES SHALL BE INSTALLED PER THE REQUIREMENTS OF THE APPLICABLE SITE UTILITY PROVIDER

5. METALLIC WARNING TAPE SHALL BE INSTALLED 12" ABOVE ALL STORM DRAIN AND OTHER UTILITIES.


6. IT SHALL BE THE CONTRACTOR'S SOLE RESPONSIBILITY TO MAINTAIN THE INTEGRITY OF ALL EXISTING UTILITIES, STRUCTURES AND ABUTTING PROPERTIES. THE COST OF ANY REPAIR OR REPLACEMENT OF DAMAGED

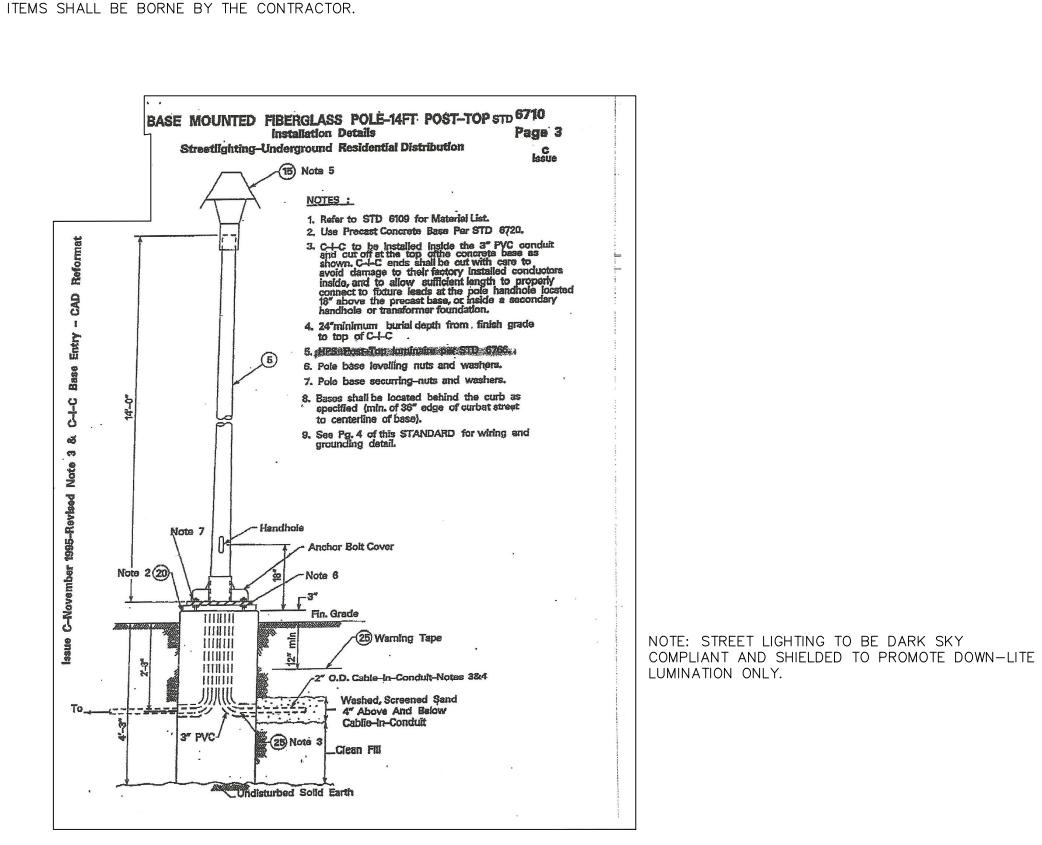

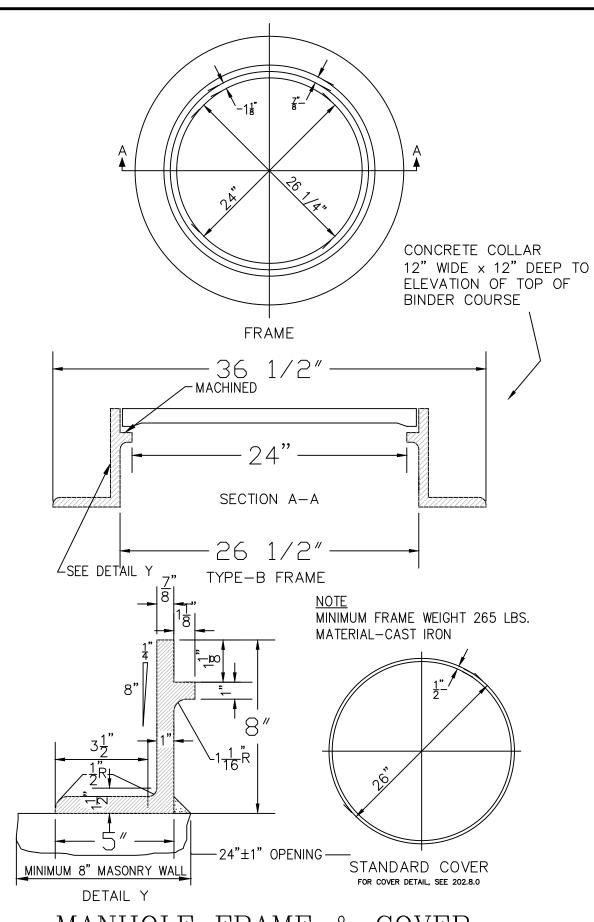


MANHOLE FRAME & COVER NOT TO SCALE

NOTE: DRAIN MANHOLE COVERS SHALL HAVE THE WORD "DRAIN" CAST INTO THEM WITH THREE INCH LETTERING

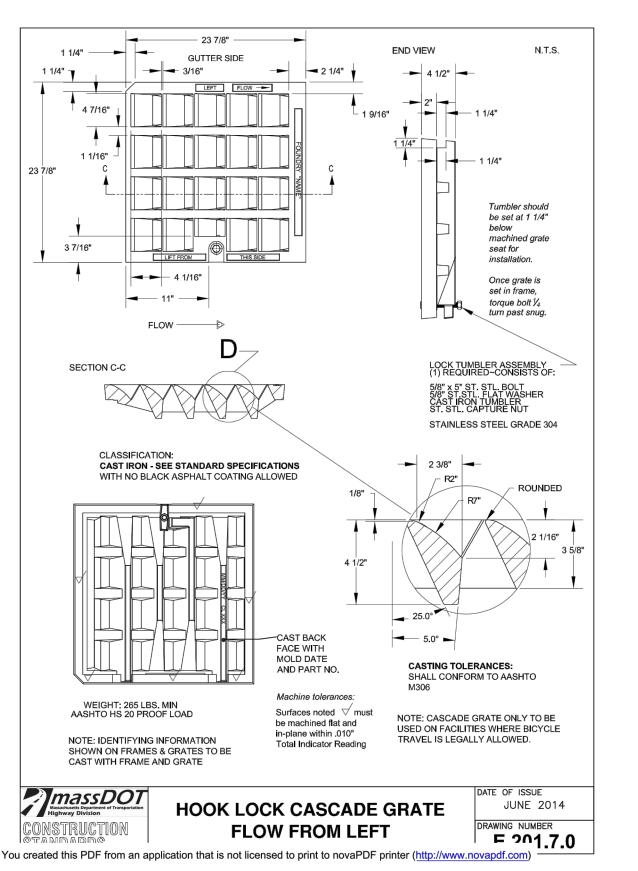

1. THE MASSACHUSETTS STANDARD FRAME IS TO BE USED, DETAILS AND DIMENSIONS NOT SHOWN ABOVE ARE TO BE THE SAME AS THOSE SHOWN ON CONSTRUCTION STANDARD 201.6.0.

2. A (3)THREE FLANGE FRAME IS TO BE USED WHEN A CURB INLET IS REQUIRED. 3. GRATE DETAILS ARE SHOWN ON CONSTRUCTION STANDARD 201.7.0. 4. THE GRATE AS PLACED ABOVE IS FOR WATER COMING FROM THE RIGHT. TURN THE GRATE 180° FOR A WATER FLOW FROM THE LEFT. SEE NOTE No. 2 ON

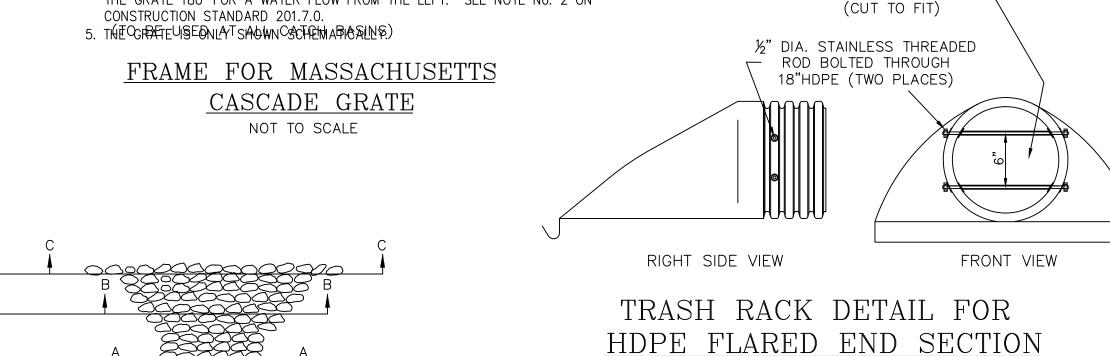

34" DIA. COPPER TUBING (TYPE

M) SLEEVE ON INSIDE OF PIPE

TO PREVENT PIPE WARPING

STONE

BEDDING

1.5"STONE / 4"

1.5"STONE / 4"

1 FT.—► —FLARED END SECTION WIDTH OF FLARED END SECTION + 10' -RIP RAP STONE WITH SECTION C-C BEDDING BENEATH RIP-RAP TABLE FILTER FABRIC 10' MINIMUM WIDTH OF FLARED END SECTION STONE / DEPTH SIZE / DEPTH SECTION + 6 FT. M02.02.4 / 12" BASIN INLET PIPES BASIN SPILLWAYS M02.02.4 / 12" SECTION B-B FILTER FABRIC-M02.02.4 = 8" - 95 / 100%,8' MINIMUM WIDTH 4" - 0 / 25% 2½" - 0 / 5% WIDTH OF FLARED END (50 lb. STONE) SECTION + 2 FT.


SECTION A-A NOTES: 5' MINIMUM WIDTH

7/////

FILTER FABRIC-

CLASS OF RIP-RAP AND BEDDING TO BE SPECIFIED IN CONTRACT DOCUMENTS. DIMENSIONS MAY BE MODIFIED BY ENGINEER TO MEET FIELD CONDITIONS 3. UNLESS OTHERWISE SPECIFIED, DUMPED RIP-RAP SHALL BE USED.

> ROCK FILL RIP-RAP @ FLARED END SECTIONS NOT TO SCALE

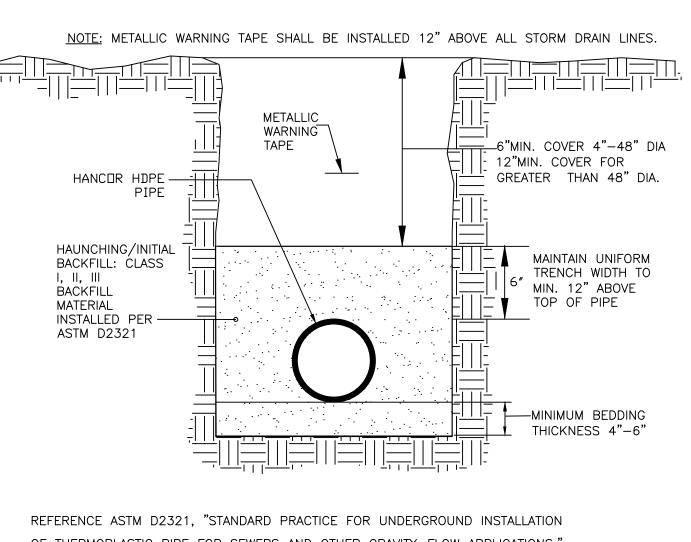


OF THERMOPLASTIC PIPE FOR SEWERS AND OTHER GRAVITY-FLOW APPLICATIONS."

HDPE TRENCH INSTALLATION DETAIL NOT TO SCALE

RECOMMENDED MINIMUM TRENCH WIDTH						
PIPE DIAMETER	TRENCH WIDTH	PIPE DIAMETER	TRENCH WIDTH			
IN. (MM)	IN. (M)	IN. (MM)	IN. (M)			
- 8 (100-200)	*	30 (750)	60 (1.5)			
10 (250)	24 (0.6)	36 (900)	65 (1.7)			
12 (300)	28 (0.7)	42 (1050)	84 (2.1)			
15 (375)	35 (0.9)	48 (1200)	91 (2.3)			
18 (450)	43 (1.1)	54 (1350)	97 (2.5)			
24 (600)	56 (1.4)	60 (1500)	103 (2.6)			


* USUALLY BASED ON SMALLEST BUCKET SIZE AVAILABLE

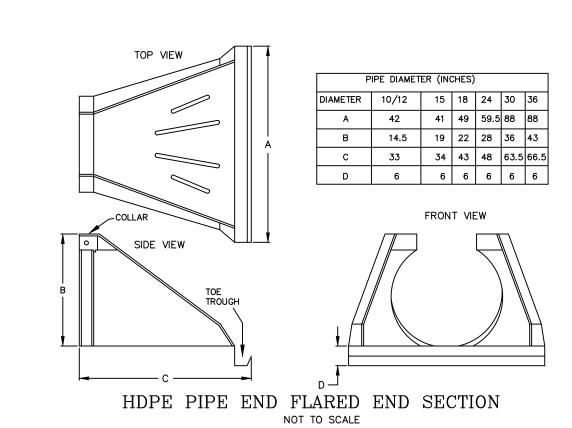

MAINTENANCE RESPONSIBILITY

1. THE APPLICANT IS RESPONIBLE FOR THE MAINTENANCE OF ALL DRAINAGE STRUCTURES.

DETAIL SHEET - 5

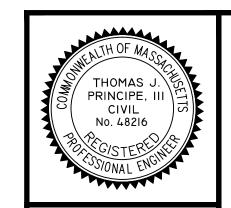

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	REVISIONS						
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	TJP	JAR	7-14-21	1.			
	TJP	MNG	7-29-21	2.			
	TJP	MNG	8-5-21	3.			
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		SCALE: AS NOTED		SHEET NO	o: 20 OF 21
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] [DATE: 5/26/21		PROJECT NO.: LD13-1 PH II/III	

