# SITE PLANS FOR 801 VILLAGE

LOCATED AT

801 MAIN STREET


ANA MASSACHUSETTS 02571

WAREHAM, MASSACHUSETTS 02571


DATE: JUNE 30, 2022

REVISED: SEPTEMBER 23, 2022 PER TOWN COMMENTS

REVISED: OCTOBER 5, 2022

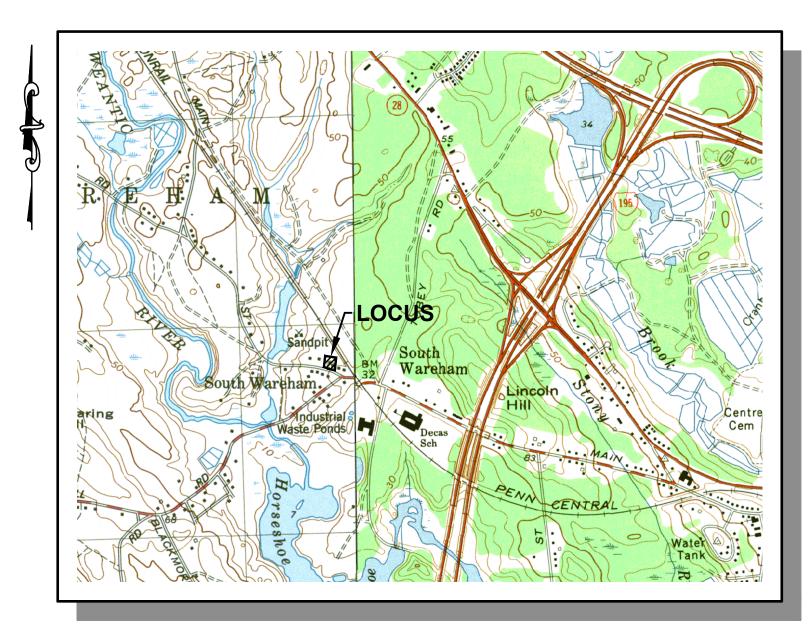

VICINITY MAP
SCALE: 1" = 1,500'

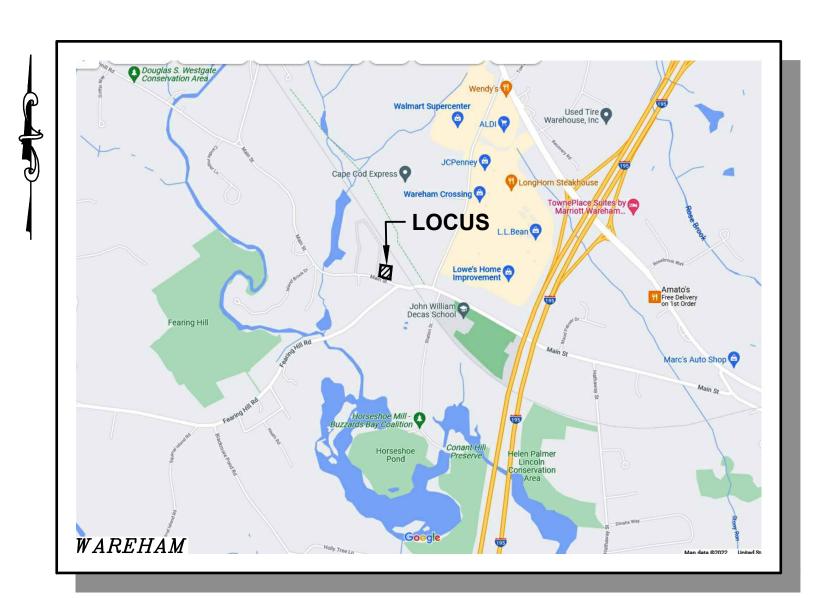

<u>LOCUS MAP</u> SCALE: 1" = 1,500'



INDEX OF PLANS			
SHEET NO.	TITLE	SCALE	
1 2	COVER SHEET SITE PLAN	1" = 100' 1" = 20'	
3	DETAILS PLAN	N.T.S.	

# **APPLICANT:**

VILLAGES 801 MAIN STREET, LLC 815 MAIN STREET — MGMT. OFFICE WAREHAM, MASSACHUSETTS 02571

### **OWNER:**

VILLAGES 810 MAIN STREET, LLC 15 FERNWOOD ROAD N. FALMOUTH, MASSACHUSETTS 02556

## **ENGINEER:**






Sheet of 1 3

JOB NUMBER
3271.00

OVERALL LOCATION PLAN
SCALE: 1" = 100'

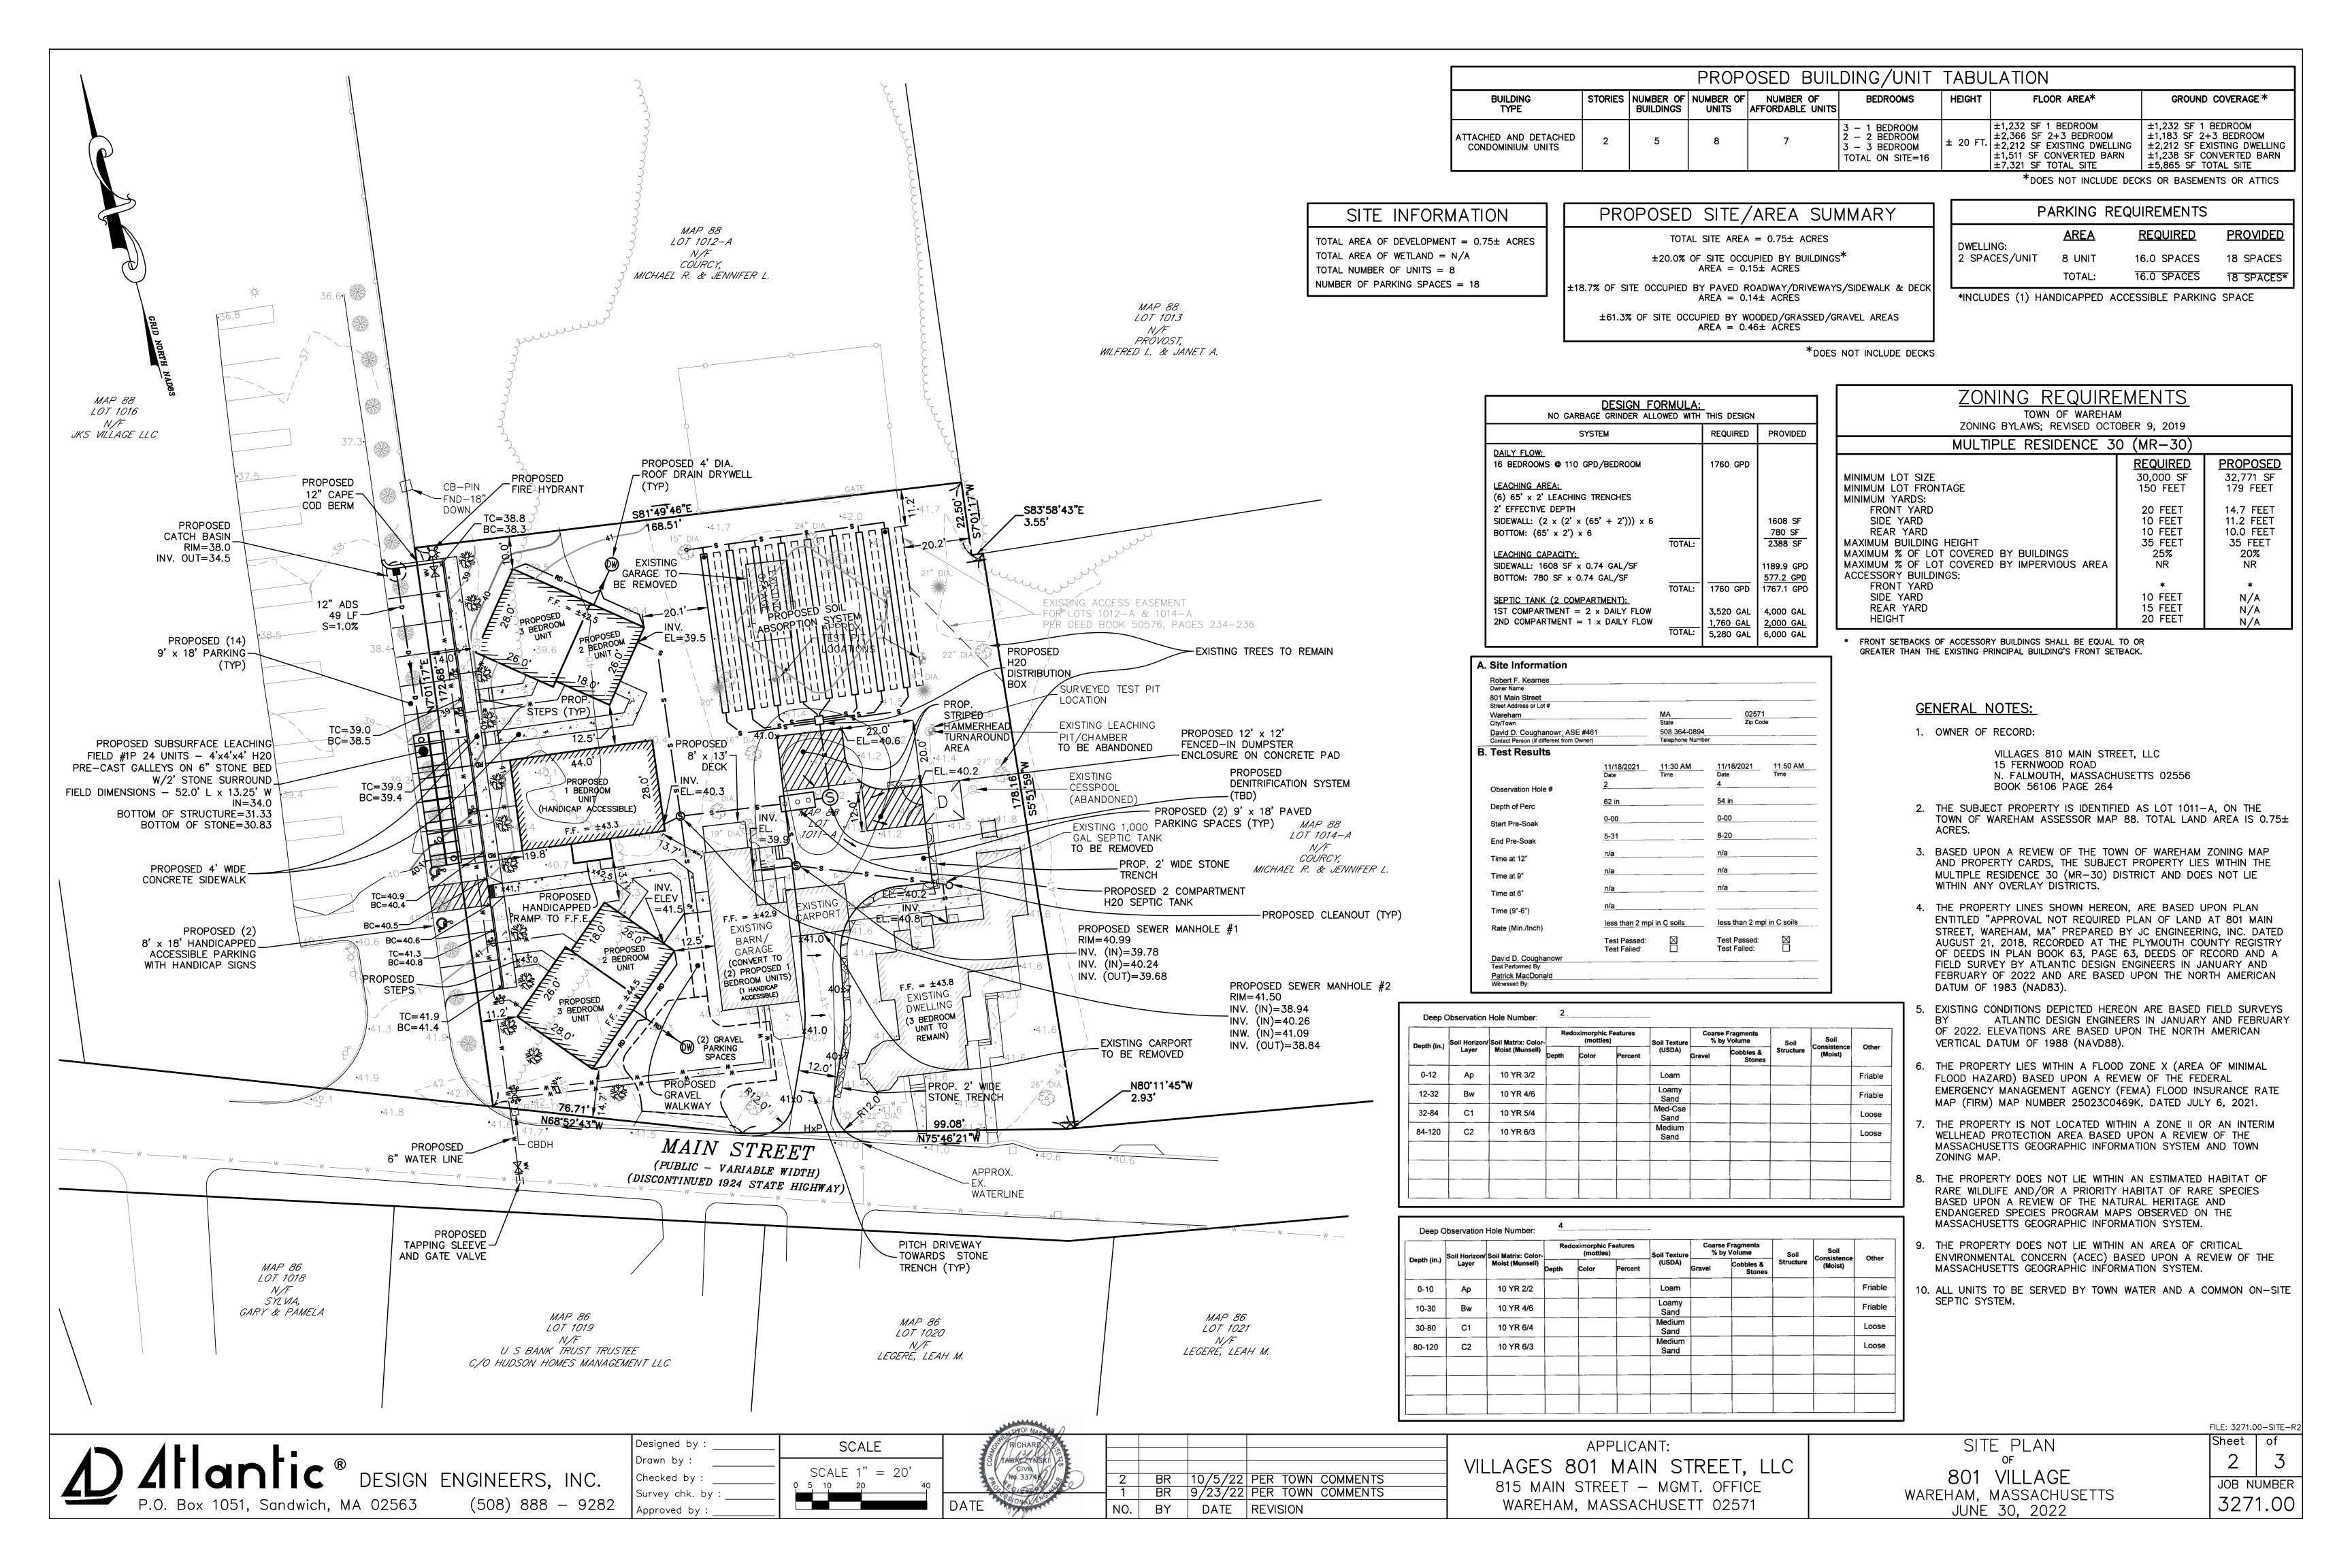

### **WATER SYSTEM NOTES:**

- A DUAL SPRING CHECK VALVE BACKFLOW DEVICE IS REQUIRED ON EACH RESIDENTIAL DOMESTIC SERVICE.
- 2. A TESTABLE DUAL CHECK VALVE ASSEMBLY (DCYA) OR REDUCED BACK PRESSURE-ZONE (RPZ) BACKFLOW PROTECTION DEVICE IS REQUIRED ON EACH COMMERCIAL/BUSINESS BUILDING AND ALL PROPOSED NEW FIRE SPRINKLER CONNECTIONS, TYPE REQUIRED DEVICE INSTALLED WILL BE DEPENDENT UPON THE POTENTIAL HAZARDS AT EACH LOCATION.
- 3. ALL RPZ DEVICES MUST INCLUDE THE INSTALLATION OF A MEANS TO CATCH WATER AND PROPERLY DIVERT THAT WATER TO A FLOOR DRAIN OR OTHER DESIGNATED LOCATION FROM THE BOTTOM OF THE DEVICE. THIS IS REQUIRED FOR ROUTINE TESTING PROCEDURES AND FOR CONTROL OF WATER WITHIN THE FACILITY.
- 4. ALL NEW WATER INFRASTRUCTURE INSTALLATIONS SHALL COMPLY WITH THE WAREHAM FIRE DISTRICT RULES & REGULATIONS ADOPTED FEBRUARY 11, 2002 UPDATED MARCH 2022. DOCUMENT CAN BE FOUND AT HTTP://WWW.WAREHAMFIREDISTRICT.ORG/
- 5. PLEASE NOTE THE FOLLOWING SECTION OF THE WFD RULES AND REGULATIONS: SECTION 4.0 -WATER MAIN MATERIALS

ALL WATER MAIN MATERIALS USED WITHIN THE WFD SYSTEM SHALL CONFORM TO ANSI/AWWA STANDARDS, AND WHERE APPLICABLE, HAVE NATIONAL SANITARY FOUNDATION APPROVAL. ALL MATERIAL MUST BE INSTALLED AS TO HAVE NO LEAKAGE UNDER 150 POUNDS HYDROSTATIC PRESSURE. IN GENERAL, THE WFD HAS STANDARDIZED ON LEAD-FREE MATERIALS AND DUCTILE IRON FOR PIPE AND FITTINGS. CAST IRON FITTINGS SHALL NOT BE ACCEPTED.

PIPE: ALL WATER MAIN PIPE SHALL BE BURIED AT A DEPTH OF NO LESS THAN 4.5 FEET AND NOT MORE THAN 6 FEET DEEP AND CONFORM TO ONE OF THE FOLLOWING STANDARDS:

- A) <u>DISTRICT OWNED WATER MAINS:</u> CLASS 52 (OR BETTER) OR PRESSURE CLASS 350 NORTH AMERICAN MADE CEMENT LINED DUCTILE IRON PIPE.
- i. PIPES WILL BE MANUFACTURED BY MCWANE DUCTILE, US PIPE, AMERICAN PIPE, OR APPROVED EQUAL
- ii. PIPE SHALL MEET THE LATEST REVISION OF THE FOLLOWING STANDARDS:

ANSI/AWWA C104/A21.4 CEMENT - MORTAR LININGS ANSI/AWWA C105-A21.5 POLYETHYLENE ENCASEMENT FOR DUCTILE IRON PIPE ANSI/AWWA C110/ A21.10 DUCTILE-IRON AND GREY-IRON FITTINGS, 3 INCH THROUGH 48 INCH FOR WATER ANSI/AWWA C111/A21.11 RUBBER - GASKET JOINTS ANSI/AWWA C115/A21.15 FLANGED PIPE ANSI/AWWA C150/A21.50 DESIGN ANSI/AWWA C151/A21.51 WATER PIPE ANSI/AWWA C153/A21.53 FITTINGS - DUCTILE IRON ANSI/AWWA C600 INSTALLATION


- iii. ALL PRODUCTS SHALL BE CONSTRUCTED OF DUCTILE IRON. CAST IRON PRODUCTS ARE ONLY ACCEPTABLE IF WRITTEN PERMISSION IS PROVIDED BY THE WFD.
- iv. EXTERIOR OF PIPE SHALL BE PROVIDED WITH ZINC COATING AS FOLLOWS: 1) CONSISTS OF A LAYER OF ARC APPLIED OR PAINT APPLIED, 99.99% PURE ZINC COATING HAVING A MASS OF 200G/M $^2$
- 2) HAS A FINISH LAYER OF STANDARD SHOP APPLIED BITUMINOUS PAINT IN ACCORDANCE WITH AWWA C—104. 3) PIPE MARKINGS SHALL INCLUDE THE WORD "ZINC" IN THE PIPE MARKINGS OR LABEL REQUIRED BY A WW A C-151 AND/OR OTHER MARKINGS AS DEEMED
- APPROPRIATE BY THE MANUFACTURER. 4) SHALL COMPLY WITH ALL APPLICABLE PARTS OF ISO 8179 FOR ZINC COATINGS.
- 5) MINOR SCRATCHES IN THE ZINC COATING WILL NOT NEED TO BE REPAIRED DUE TO THE SELF-HEALING NATURE OF ZINC COATINGS BUT LARGER AREAS SHALL BE REPAIRED BY FIELD APPLICATION OF A ZINC RICH PAINT IN ACCORDANCE WITH ISO 8179.

B) PRIVATE OWNED MAINS — BEYOND DISTRICT OWNED GATE VALVES: MATERIAL LISTED IN PARAGRAPH A) ABOVE OR ii. C—900 DR—14 PVC (PERMITTED ONLY BEYOND DISTRICT OWNED GATE VALVES) I. WHERE ORGANIC CONTAMINANTS EXIST (E.G. PETROLEUM) IN THE SOIL THAT ARE NOT COMPATIBLE PROVIDING SAFE WATER WITH PVC PIPE, PVC PIPE SHALL NOT BE USED. IN SUCH SITUATIONS ONLY DUCTILE IRON PIPE SHALL BE ACCEPTABLE. iii. FITTINGS SHALL BE DUCTILE IRON.

C) PIPE LAYING CONDITIONS: PIPE LAYING CONDITIONS SHALL BE TYPE 5 (TABLE 1).

D) RESTRAINING SYSTEM: ALL PIPES SHALL BE RESTRAINED. RESTRAINTS SHALL BE PROVIDED BY SURE STOP 350 GASKETS (GRIPPER) FOR SIZES 3 INCH TO 24 INCHES IN DIAMETER AND TR FLEX OVER 24 INCHES IN DIAMETER OR EQUAL BY APPROVED MANUFACTURERS (FIELD LOK 350, FAST GRIP). WHERE SOIL IS BELIEVED TO PROVIDE THE NECESSARY FRICTION FOR RESTRAINT, PERMISSION SHALL BE OBTAINED BY THE WFD IN WRITING AND CALCULATIONS BY CERTIFIED BY A PROFESSIONAL ENGINEER IN THE STATE OF MASSACHUSETTS SHALL BE PROVIDED. THRUST BLOCKS OR MECHANICAL JOINT RESTRAINTS CAN BE PROVIDED AS DESCRIBED BELOW ARE ACCEPTABLE ALTERNATIVES WHERE APPROPRIATE.

- 6. ALL HYDRANTS SHALL BE MUELLER SUPER CENTURION TRAFFIC MODEL HYDRANTS. HYDRANTS SHALL HAVE A GATE VALVE ATTACHED TO AN ANCHORING TEE. ALL HYDRANTS AND ALL GATE VALVES SHALL BE OPEN-LEFT.
- IF NEEDED THE DEVELOPER SHALL PROVIDE WFDWD WITH FIXTURE COUNT CALCULATION PER 248 CMR 10.14(4), AND AWWA-M22 TO VALIDATE SERVICE LINE AND SIZING OF THE DOMESTIC SERVICE WATER METER SHALL BE ADEQUATE.

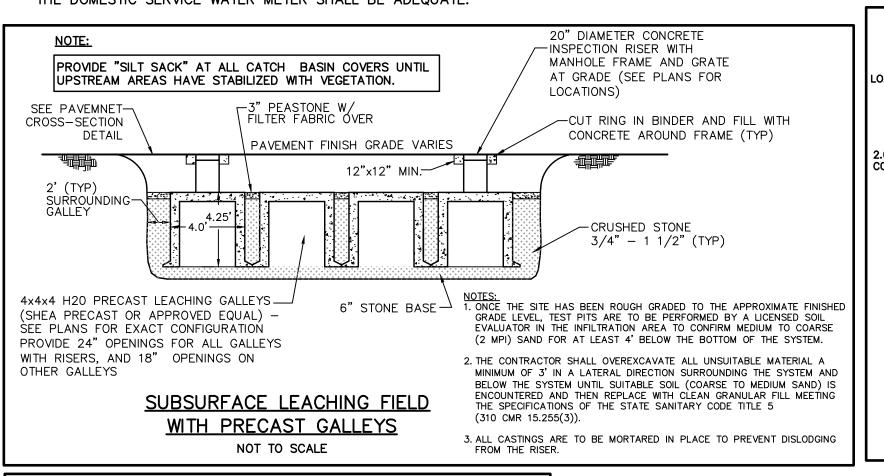

-FINISH GRADE

TO INFILTRATION

-DOWNSPOUT

FACE OF -

BUILDING

(SEE ARCHITECTURALS)

-SPLASHBLOCK FOR

(NOT NEEDED FOR PAVEMENT)

GRASSED AREAS


FOR SIZE)


SEE PLAN


DOWNSPOUT TIE-IN DETAIL

(NOT TO SCALE)

-MORTAR (WATERTIGHT)

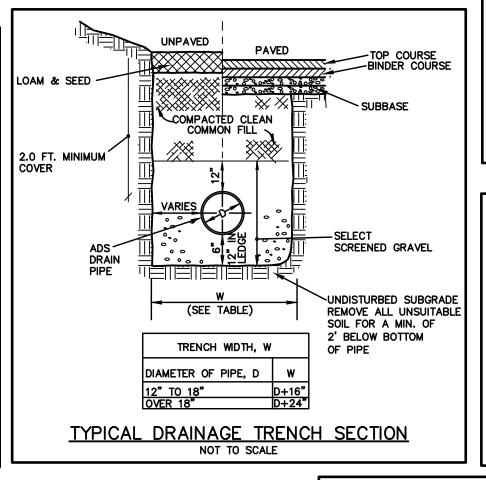

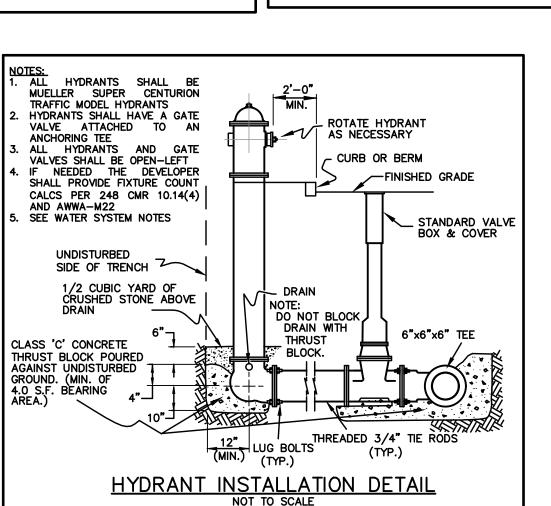

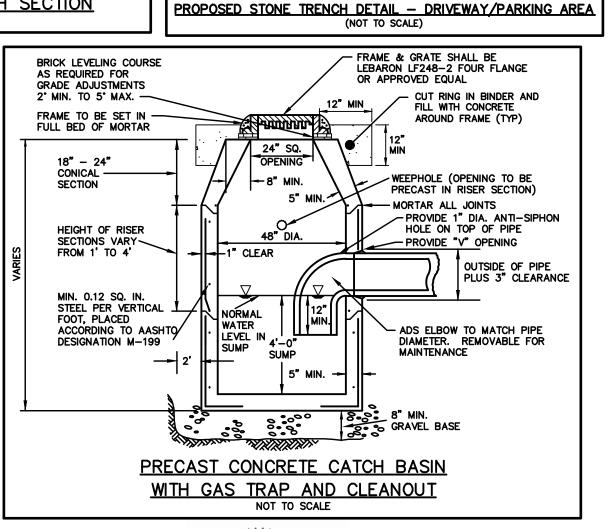

GROUND SLOPE

MIRAFI FILTER FABRIC\_ OR APPROVED EQUAL TOE-IN AT SLOPE

1/4" BIT CONC.

COMPACTED

SUBGRADE -

20230

6" COMPACTED GRAVEL BASE-

OR FILL

TOP COURSE

(TYPE I-1)

- WWF 6x6 - W2.9xW2.9

(BROOM FINISH)

<u>, 15. , 4 , 5:1</u>

(NOT TO SCALE)

1 3/4" BIT CONC

12" GRAVEL

SUBBASE M 1.03

TYPE B (2-6"

LAYERS OR 9"

-BINDER COURSE

(TYPE I-1)

PAVEMENT CROSS SECTION

4" CONCRETE SIDEWALK WITH 1/2 EXPANSION JOINTS @ 20' O.C. AN


SCORED CONTROL JOINTS @ 5' O.C.


WHITE PAINTE


PAINTED HANDICAPPED

SYMBOL DETAIL
NOT TO SCALE

NOT TO SCALE

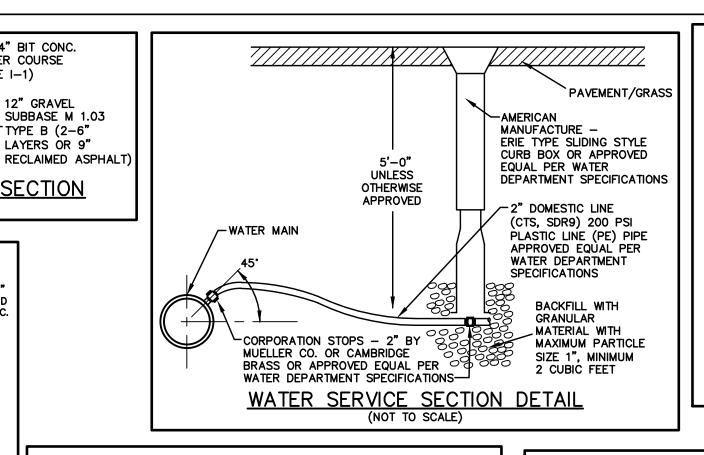

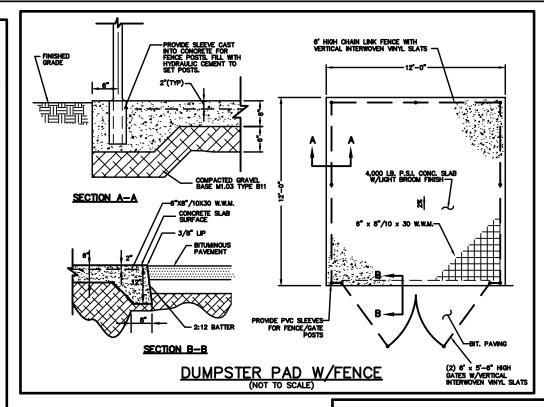

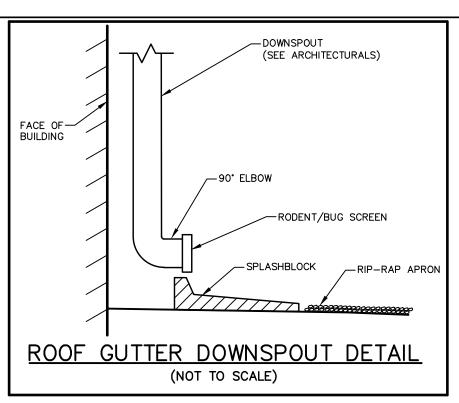

2114Z/2110A OR APPROVED EQUAL. SET RIM EL. AT FINISHED GRADE

PROPOSED INSPECTION

OR CAP AT GRADE

(TYP OF 2)

PORT W/THREADED PLUG

MINIMUM SEPARATION

TO HIGH GROUNDWATER


<u>√</u> (NO GROUNDWATER

**ENCOUNTERED IN TEST PITS)** 

PROPOSED 4" PVC VENT

W/BUG SCREEN

(SEE DETAIL)

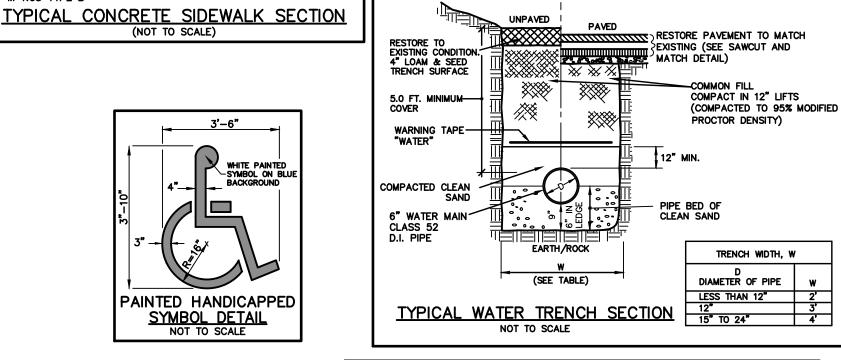

BITUMINOUS BERM

(NOT TO SCALE)

(TYP)

12" GRAVEL


BBASE M 1.03

LAYERS OR 9"


TYPE B (2-6"-


RECLAIMED

ASPHALT)

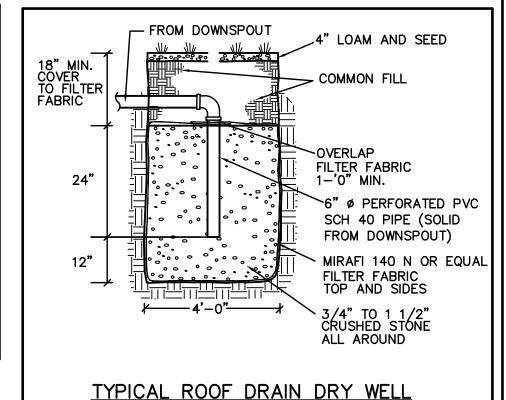

NOT TO SCALE

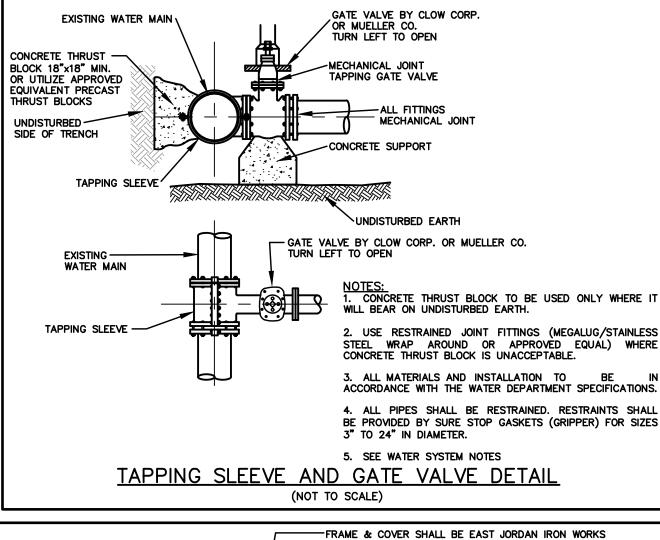


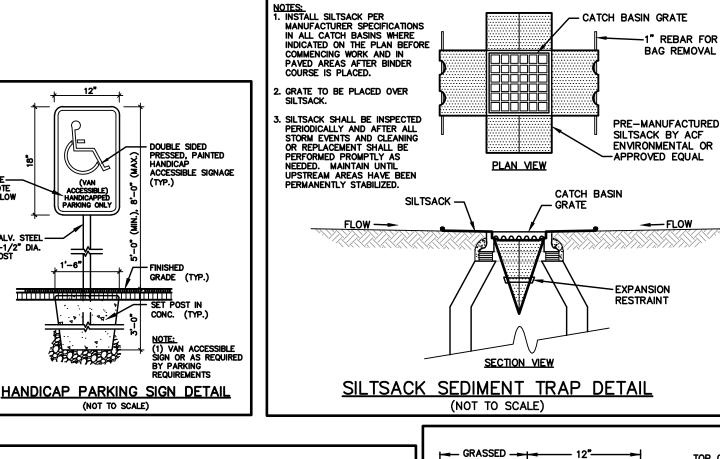

PROVIDE TEMPORARY FILTER FABRIC COVER FOLD. FOLD TO FOLLOW

SLOPE/FLOW DIRECTION. CUT AND REMOVED ONCE SITE IS STABILIZED

DRIVEWAY/PARK

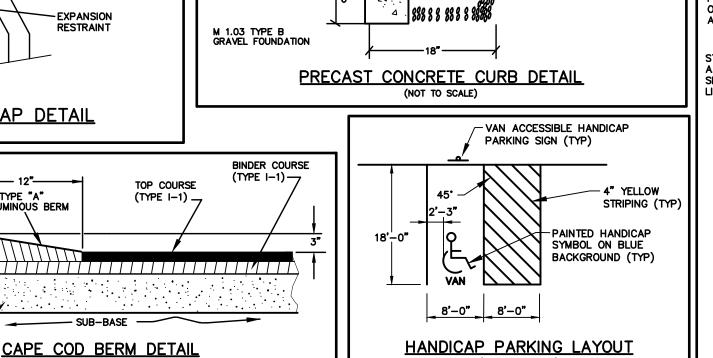


MANHOLE FRAME & COVER

AT FINISHED GRADE (TYP)

MANHOLE #1: 15.6'± @ 1.0%

MANHOLE #2: 29.6'± @ 0.5%

SEE DETAIL 'A'

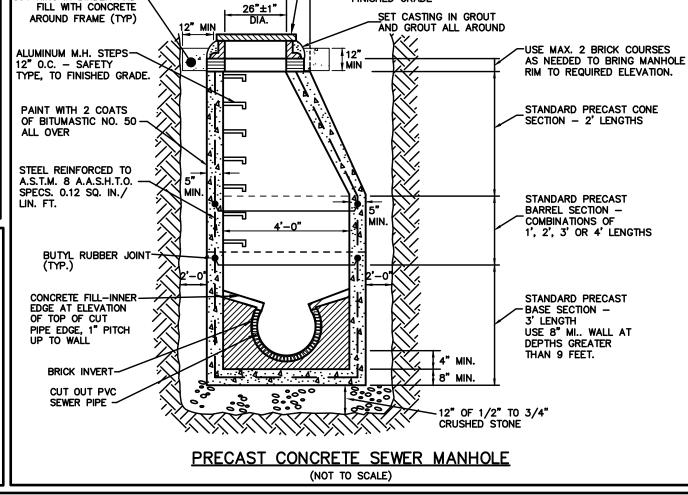

-4" PERFORATED PVC, SCH 40 @


0.5% SLOPE WITH 3/8" MIN. AND


/ 3/4" - 1-1/2" DOUBLE WASHED STONE

-2" OF 1/8"-1/2" DOUBLE

WASHED PEA STONE

5/8" MAX. PERFORATIONS

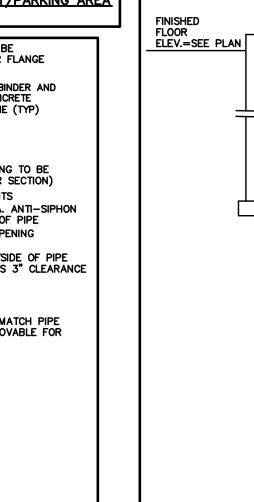

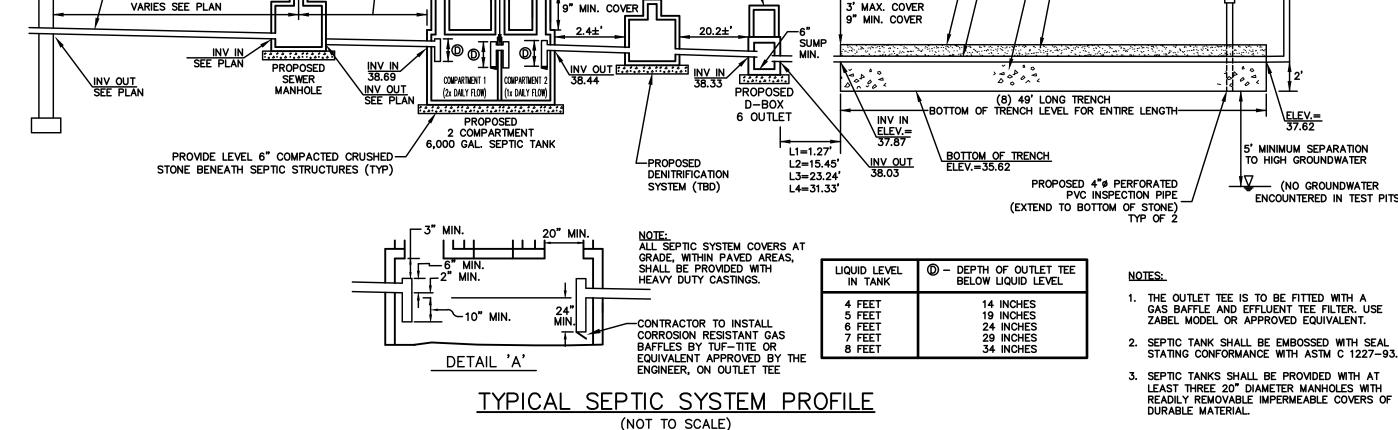

(NOT TO SCALE)

COMPARTMENTS TO BE INTERCONNECTED BY MIN. 4" VENT WHICH

PROVIDE RISER AND COVER TO WITHIN


6" OF FINAL GRADE

ELEV.=38.12

EXTENDS BELOW THE BOTTOM OF THE SCUM LAYER. PROVIDE OPEN TEES CONNECTION OR HOLES TO PREVENT ANTI-SIPHONING



Designed by :	SCALE		
Drawn by:	_		
Checked by:	- AC MOTED		
Checked by: Survey chk. by:	_ AS NUTED		
Approved by :			

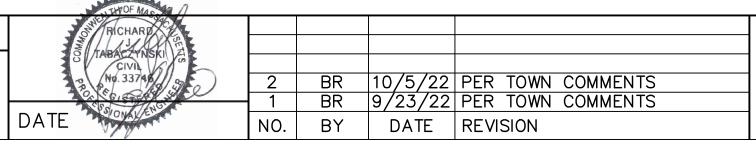

**APPLICANT:** VILLAGES 801 MAIN STREET, LLC 815 MAIN STREET - MGMT. OFFICE WAREHAM, MASSACHUSETT 02571

DETAILS PLAN 801 VILLAGE WAREHAM, MASSACHUSETTS JUNE 30, 2022

FILE: 3271.00-SITE-R Sheet JOB NUMBER 3271.00