

PROJECT TEAM

CLIENT REPRESENTATIVE:

SMARTHINKGROUP 85 RANGEWAY ROAD - BLDG 3, SUITE 102

NORTH BILLERICA, MA 01862

CONTACT: KEVIN GAUVREAU

KEVIN.GAUVREAU@SMARTLINKGROUP.COM

ARCHITECT & ENGINEER:

TRYLON TSF 1825 W. WALNUT HILL LANE, SUITE 120

IRVING, TX 75038 CONTACT:

MIKE MOORE MIKE.MOORE@TRYLON.COM

1-855-669-5421

RF ENGINEER:

84 DEERFIELD LN. MERIDEN, CT 06450

CONTACT: JOHN BENEDETTO RA9161@ATT COM

PROJECT MANAGER:

CONTACT:

CONTACT:

SMARTLINKGROUP 85 RANGEWAY ROAD - BLDG 3, SUITE 102

NORTH BILLERICA, MA 01862

DAVID.WALSH@SMARTLINKGROUP.COM

(860) 993-5191

SMARTLINKGROUP CONSTRUCTION MANAGER:

85 RANGEWAY ROAD - BLDG 3, SUITE 102 NORTH BILLERICA, MA 01862

KEVIN GAUVREAU

KEVIN.GAUVREAU@SMARTLINKGROUP.COM

(978) 886-7149

PROJECT INFORMATION

SITE NAME:

WARFHAM BROWN ST

USID: FA#:

317182 15283436

SITE ADDRESS:

25 BROWN STREET WAREHAM, MA 02571

PARCEL NUMBER (APN):

56_1000_A

PROPERTY OWNER:

STRUCTURE TYPE:

UMANO MICHAEL J TRUSTEE 40 LONE ST MARSHFIELD MA 02050

150'-0" SELF SUPPORT TOWER

SITE TYPE:

SELF SUPORT TOWER 41.753250° / 41°45'11.7°N

LATITUDE (NAD 83): LONGITUDE (NAD 83):

-70.732500° / 70°43'57.0"W

GROUND ELEVATION:

±16'-0" (AMSL)

PLYMOUTH TOWN OF WARFHAM

ZONING JURISDICTION: CURRENT ZONING:

AGRICULTURAL

AT&T LEASE AREA:

240 SQ. FT.

APPLICANT:

AT&T MOBILITY 7150 STANDARD DRIVE HANOVER, MD 21076

TOWER OWNER:

UNKNOWN UNKNOWN

TOWER OWNER SIDE ID:

ow what's below.
Call before you dig,

MASSACHUSETTS
STATUTE REQUIRES MIN
OF 2 WORKING DAYS
NOTICE BEFORE YOU Know what's below.

UNDERGROUND FACILITIES BEFORE YOU DIG IN MASSACHUSETTS, CALL DIG SAFE SYSTEM, INC. TOLL FRFF: 1-888-344-7233 OR

SITE NAME: WAREHAM BROWN ST

SEARCH RING #: MA1883S

FA #: 15283436

USID: 317182

PACE # MRCTB064669

SITE ADDRESS: 25 BROWN STREET

WAREHAM, MA 02571

STRUCTURE TYPE: SELF SUPPORT TOWER



DRIVING DIRECTIONS

FROM 7150 STANDARD DRIVE, INHORED, NO 2017/E
STANT OUT GOING WEST ON COOCHILUTE ROJAM-30 TOWNS DRIVES ST. THEN 0.25 MLES. TWE THE 1ST ROAT GYTO BURR ST. THEN 0.26 MLES. MANK A U-TURN DRIFO BURR ST. F YOU ARE ON EXCHILEDONT MODAL. ROY YELVING COME A LITTLE TO
THE STANT-12S S W. DIT 12S TOWNS DRIVE TO TOWNS DRIVES STORY THE STANT OF THE ST. THEN 0.25 MLES. MEDIC COVEY THE ST. THE ST. THEN 0.25 MLES. MEDIC COVEY THE ST. THEN 0.25 MLES. T

BUILDING CODES

ALL WORK AND MATERIALS SHALL BE PERFORMED AND INSTALLED IN ACCORDANCE WITH THE CURRENT EDITIONS OF THE FOLLOWING CODES AS ADOPTED BY THE LOCAL GOVERNING AUTHORITIES. NOTHING IN THESE PLANS IS TO BE CONSTRUED TO PERMIT WORK NOT CONFORMING TO THE LATEST EDITIONS OF THE FOLLOWING CODES.

- 2015 INTERNATIONAL BUILDING CODE
- 2017 NATIONAL ELECTRICAL CODE WITH LOCAL AMENDMENTS

FOR ANY CONFLICTS BETWEEN SECTIONS OF LISTED CODES AND STANDARDS REGARDING MATERIAL, METHODS OF CONSTRUCTION, OR OTHER REQUIREMENTS, THE MOST RESTRICTIVE REQUIREMENT SHALL GOVERN. WHERE THERE IS CONFLICT BETWEEN A GENERAL REQUIREMENT AND A SPECIFIC REQUIREMENT, THE SPECIFIC REQUIREMENT SHALL GOVERN.

- FACILITY IS UNMANNED AND NOT FOR HUMAN HABITATION
- ADA ACCESS REQUIREMENTS ARE NOT REQUIRED
 THIS FACILITY DOES NOT REQUIRE POTABLE WATER AND WILL NOT
 PRODUCE ANY SEWAG

GENERAL NOTES

THE FACILITY IS UNMANNED AND NOT FOR HUMAN HABITATION. A TECHNICIAN WILL VISIT THE SITE AS REQUIRED FOR ROUTINE MAINTENANCE, THE PROJECT WILL NOT RESULT IN ANY SIGNIFICANT DISTURBANCE OR EFFECT ON DRAINAGE; NO SANITARY SEWER SERVICE, PORTABLE WATER, OR TRASH DISPOSAL IS REQUIRED, NO COMMERCIAL SIGNAGE AND NO LANDSCAPING IS PROPOSED.

DO NOT SCALE DRAWINGS

CONTRACTOR SHALL VERIFY ALL PLANS AND EXISTING DIMENSIONS AND CONDITIONS ON THE JOB SITE AND SHALL IMMEDIATELY NOTIFY THE ARCHITECT/ENGINEER IN WRITING OF ANY DISCREPANCIES BEFORE PROCEEDING WITH THE WORK OR BE RESPONSIBLE FOR SAME.

RFDS DATA

RFDS ID: 5000317 DATED: 2/8/2022

REVISION: FINAL VERSION: 2.00

UPDATED BY: rd9161

DATE/TIME UPDATED: 6/1/2022 / 1:42:16 PM

PROJECT DESCRIPTION

TOWER SCOPE OF WORK:

- INSTALL (3) NEW ANTENNA MOUNTS
- INSTALL (6) NEW ANTENNAS, (2) PER SECTOR INSTALL (3) FUTURE RRH'S, (1) PER SECTOR
- INSTALL (9) NEW RRH'S, (3) PER SECTOR
- INSTALL (1) NEW DC9-48-60-24-8C-EV SQUID
- INSTALL (3) NEW DC TRUNKS
- INSTALL (1) NEW 18 PAIR FIBER TRUNK
- INSTALL NEW 10' EXTENSION (REFER TO STRUCTURAL ANALYSIS BY TEP DATED 4/7/2022)

GROUND SCOPE OF WORK:

INSTALL NEW 8'-0"X8'-0" WALK-IN-CABINET (CWIC)

INSTALL (1) 4'-0"x6'-0" CONCRETE PAD FOR GENERATOR

INSTALL NEW 20KW DIESEL GENERAC GENERATOR INSTALL NEW 32'-0" ICE BRIDGE
INSTALL (1) 12'-0"x12'-0" CONCRETE PAD FOR CWIC

SHEET INDEX

DESCRIPTION

SHEET #	DESCRIPTION	KEVISION #
T-1	TITLE SHEET	4
T-2	GENERAL NOTES	4
A-1	OVERALL SITE PLAN	4
A-2	ENLARGED SITE PLAN	4
A-3	EQUIPMENT AREA	4
A-4	ELEVATION AND ANTENNA LAYOUT	4
A-5	ANTENNA SCHEDULE	4
D-6	CABLE AND MOUNT DETAILS	4
D-7	EQUIPMENT DETAILS	4
D-8	EQUIPMENT DETAILS	4
D-9	EQUIPMENT DETAILS	4
D-10	WALK IN CABINET DETAILS	4
D-11	GENERATOR DETAILS	4
D-12	PLUMBING DIAGRAM	4
S-1	WIC CONCRETE PAD DETAILS	4
S-2	GENERATOR CONCRETE PAD DETAILS	4
E-1	UTILITY PLAN	4
G-1	GROUNDING PLAN	4
G-2	GROUNDING DETAILS	4





BLDG 3, SUITE 102

NORTH BILLERICA, MA 01862



1825 W. WALNUT HILL LANE, SUITE 120 IRVING. TEXAS 75038

DRAWING SCALES ARE INTENDED FOR 11"x17" SIZE PRINTED MEDIA ONLY.

П				
H		9	SUBMITTALS	
П	REV	DATE	DESCRIPTION	BY
П	A	11/03/22	90% CD	JSR
П	8	11/09/22	80% CD	DIN
П	С	11/30/22	90% CD	DIN
П	0	01/31/23	100% CD	DIN
П	1	02/21/23	ADDING FALL ZONE	JSR
I	2	04/20/23	REDLINES PER CLIENT	JSR
П	3	05/05/23	REDLINES PER CLIENT	JSR
ı	4	06/19/23	10' EXTENSION	JSR



REVISION #

SITE INFORMATION

WAREHAM BROWN ST

MA1883 FA#: 15283436

USID: 317182

25 BROWN STREET WAREHAM, MA 02571

SHEET DESCRIPTION

TITLE SHEET

SHEET NO.

1 - 1

GENERAL NOTES

GENERAL CONSTRUCTION

- 1. FOR THE PURPOSE OF CONSTRUCTION DRAWING, THE FOLLOWING DEFINITIONS SHALL APPLY:
- 1.1. CONTRACTOR T.B.D
- 1.2. SUB-CONTRACTOR GENERAL CONTRACTOR (CONSTRUCTION)
- 1.3. OWNER AT&T MOBILITY
- 1.4. OEM ORIGINAL EQUIPMENT MANUFACTURER
- 2. ALL SITE WORK SHALL BE AS INDICATED ON THE DRAWINGS AND PROJECT SPECIFICATIONS.
- 3. GENERAL CONTRACTOR SHALL VISIT THE SITE AND SHALL FAMILIARIZE HIMSELF WITH ALL CONDITIONS AFFECTING THE PROPOSED WORK AND SHALL MAKE PROVISIONS. GENERAL CONTRACTOR SHALL BE RESPONSIBLE FOR FAMILIARIZING HIMSELF WITH ALL CONTRACT DOCUMENTS, FIELD CONDITIONS, DIMENSIONS, AND CONFIRMING THAT THE WORK MAY BE ACCOMPLISHED AS SHOWN PRIOR TO PROCEEDING WITH CONSTRUCTION. ANY DISCREPANCIES SHALL BE BROUGHT TO THE ATTENTION OF THE ENGINEER PRIOR TO THE COMMENCEMENT OF WORK.
- 4. ALL MATERIALS FURNISHED AND INSTALLED SHALL BE IN STRICT ACCORDANCE WITH ALL APPLICABLE CODES, REGULATIONS, AND ORDINANCES. SUBCONTRACTOR SHALL ISSUE ALL APPROPRIATE NOTICES AND COMPLY WITH ALL LAWS, ORDINANCES, RULES, REGULATIONS AND LAWFUL ORDERS OF ANY PUBLIC AUTHORITY REGARDING THE PERFORMANCE OF THE WORK.
- ALL WORK CARRIED OUT SHALL COMPLY WITH ALL APPLICABLE MUNICIPAL AND UTILITY COMPANY SPECIFICATIONS AND LOCAL JURISDICTIONAL CODES, ORDINANCES AND APPLICABLE REGULATIONS.
- UNLESS NOTED OTHERWISE, THE WORK SHALL INCLUDE FURNISHING MATERIALS, EQUIPMENT, APPURTEMANCES, AND LABOR NECESSARY TO COMPLETE ALL INSTALLATIONS AS INDICATED ON THE DRAWINGS.
- 7. THE PLANS ARE NOT TO BE SCALED. THESE PLANS ARE INTENDED TO BE A DIAGRAMMATIC OUTLINE ONLY UNLESS OTHERWISE NOTED. DIMENSIONS SHOWN ARE TO FINISH SURFACES UNLESS OTHERWISE NOTED. SPACING BETWEEN EQUIPMENT IS THE MINIMUM REQUIRED CLEARANCE. THEREFORE, IT IS CRITICAL TO FIELD VERIFY DIMENSIONS, SHOULD THERE BE ANY QUESTIONS REGARDING THE CONTRACT DOCUMENTS, THE CONTRACTOR SHALL BE RESPONSIBLE FOR OBTAINING A CLARIFICATION FROM THE ENGINEER PRIOR TO PROCEEDING WITH THE WORK. DETAILS ARE INTENDED TO SHOW DESIGN INTENT. MODIFICATIONS MAY BE REQUIRED TO SUIT JOB DIMENSIONS OR CONDITIONS AND SUCH MODIFICATIONS SHALL BE INCLUDED AS PART OF WORK AND PREPARED BY THE ENGINEER PRIOR TO PROCEEDING WITH WORK.
- 8. THE SUBCONTRACTOR SHALL INSTALL ALL EQUIPMENT AND MATERIALS IN ACCORDANCE WITH MANUFACTURER'S RECOMMENDATIONS UNLESS SPECIFICALLY STATED OTHERWISE.
- IF THE SPECIFIED EQUIPMENT CANNOT BE INSTALLED AS SHOWN ON THESE DRAWINGS, THE CONTRACTOR SHALL PROPOSE AN ALTERNATIVE INSTALLATION FOR APPROVAL BY THE ENGINEER PRIOR TO PROCEFBING
- 10. GENERAL CONTRACTOR SHALL BE RESPONSIBLE FOR THE SAFETY OF WORK AREA, ADJACENT AREAS AND BUILDING OCCUPANTS THAT ARE LIKELY TO BE AFFECTED BY THE WORK UNDER THIS CONTRACT. WORK SHALL CONFORM TO ALL OSHA REQUIREMENTS AND THE LOCAL JURISDICTION.
- GENERAL CONTRACTOR SHALL COORDINATE WORK AND SCHEDULE WORK ACTIVITIES WITH OTHER DISCIPLINES.
- 12. ERECTION SHALL BE DONE IN A WORKMAN-LIKE MANNER BY COMPETENT EXPERIENCED WORKMAN IN ACCORDANCE WITH APPLICABLE CODES AND THE BEST ACCEPTED PRACTICE. ALL MEMBERS SHALL BE LAID PLUMB AND TRUE AS INDICATED ON THE DRAWINGS.
- 13. SEAL PENETRATIONS THROUGH FIRE RATED AREAS WITH UL LISTED MATERIALS APPROVED BY LOCAL JURISDICTION. SUBCONTRACTOR SHALL KEEP AREA CLEAN, HAZARD FREE, AND DISPOSE OF ALL DEBRIS.
- 14. WORK PREVIOUSLY COMPLETED IS REPRESENTED BY LIGHT SHADED LINES AND NOTES. THE SCOPE OF WORK FOR THIS PROJECT IS REPRESENTED BY DARK SHADED LINES AND NOTES. SUBCONTRACTOR SHALL NOTIFY THE GENERAL CONTRACTOR OF ANY EXISTING CONDITIONS THAT DEVIATE FROM THE DRAWINGS PRIOR TO BEGINNING CONSTRUCTION.
- CONTRACTOR SHALL PROVIDE WRITTEN NOTICE TO THE CONSTRUCTION MANAGER 48 HOURS PRIOR TO COMMENCEMENT OF WORK.
- 16. THE CONTRACTOR SHALL PROTECT EXISTING IMPROVEMENTS, PAVEMENTS, CURBS, LANDSCAPING AND STRUCTURES. ANY DAMAGED PART SHALL BE REPAIRED AT CONTRACTOR'S EXPENSE TO THE SATISFACTION OF THE OWNER.
- 17. THE CONTRACTOR SHALL CONTACT UTILITY LOCATING SERVICES PRIOR TO THE START OF CONSTRUCTION.
- GENERAL CONTRACTOR SHALL COORDINATE AND MAINTAIN ACCESS FOR ALL TRADES AND SUBCONTRACTORS TO THE SITE AND/OR BUILDING.
- 19. THE GENERAL CONTRACTOR SHALL BE RESPONSIBLE FOR SECURITY OF THE SITE FOR THE DURATION OF CONSTRUCTION UNTIL JOB COMPLETION.
- 20. THE GENERAL CONTRACTOR SHALL MAINTAIN IN GOOD CONDITION ONE COMPLETE SET OF PLANS WITH ALL REVISIONS, ADDENDA, AND CHANGE ORDERS ON THE PREMISES AT ALL TIMES.
- 21. THE GENERAL CONTRACTOR AND SUBCONTRACTOR SHALL PROVIDE PORTABLE FIRE EXTINGUISHERS WITH A RATING OF NOT LESS THAN 2A TO 2A:10B:C AND SHALL BE WITHIN 25 FEET OF TRAVEL DISTANCE TO ALL PORTIONS OF WHERE THE WORK IS BEING COMPLETED DURING CONSTRUCTION.
- 22. ALL EXISTING ACTIVE SEWER, WATER, GAS, ELECTRIC, AND OTHER UTILITIES SHALL BE PROTECTED AT ALL TIMES, AND WHERE REQUIRED FOR THE PROPER EXECUTION OF THE WORK, SHALL BE RELOCATED AS DIRECTED BY THE ENGINEER. EXTREME CAUTION SHOULD BE USED BY THE SUBCONTRACTOR WHEN EXCAVATING OR DRILLING PIERS AROUND OR NEAR UTILITIES. SUBCONTRACTOR SHALL PROVIDE SAFETY TRAINING FOR THE WORKING CREW. THIS SHALL INCLUDE BUT NOT BE LIMITED TO: A) FALL PROTECTION, B) CONFINED SPACE, C) ELECTRICAL SAFETY, AND D) TRENCHING & EXCAVATION.
- 23. ALL EXISTING INACTIVE SEWER, WATER, GAS, ELECTRIC, AND OTHER UTILITIES, WHICH INTERFERE WITH THE EXECUTION OF THE WORK, SHALL BE REMOVED, CAPPED, PLUGGED OR OTHERWISE DISCONNECTED AT POINTS WHICH WILL NOT INTERFERE WITH THE EXECUTION OF THE WORK, AS DIRECTED BY THE RESPONSIBLE ENGINEER, AND SUBJECT TO THE APPROVAL OF THE OWNER AND/OR LOCAL UTILITIES.
- 24. THE AREAS OF THE OWNER'S PROPERTY DISTURBED BY THE WORK AND NOT COVERED BY THE TOWER, EQUIPMENT OR DRIVEWAY, SHALL BE GRADED TO A UNIFORM SLOPE, AND STABILIZED TO PREVENT EROSION.
- 25. CONTRACTOR SHALL MINIMIZE DISTURBANCE TO THE EXISTING SITE DURING CONSTRUCTION. EROSION CONTROL MEASURES, IF REQUIRED DURING CONSTRUCTION, SHALL BE IN CONFORMANCE WITH THE FEDERAL AND LOCAL JURISDICTION FOR EROSION AND SEDIMENT CONTROL.
- 26. NO FILL OR EMBANKMENT MATERIAL SHALL BE PLACED ON FROZEN GROUNDING. FROZEN MATERIALS, SNOW OR ICE SHALL NOT BE PLACED IN ANY FILL OR EMBANKMENT.

- 27. THE SUBGRADE SHALL BE BROUGHT TO A SMOOTH UNIFORM GRADE AND COMPACTED TO 95
 PERCENT STANDARD PROCTOR DENSITY UNDER PAVEMENT AND STRUCTURES AND 80 PERCENT
 STANDARD PROCTOR DENSITY IN OPEN SPACE. ALL TRENCHES IN PUBLIC RIGHT OF WAY SHALL BE
 BACKFILLED WITH FLOWABLE FILL OR OTHER MATERIAL PRE-APPROVED BY THE LOCAL JURISDICTION.
- 28. ALL NECESSARY RUBBISH, STUMPS, DEBRIS, STICKS, STONES, AND OTHER REFUSE SHALL BE REMOVED FROM THE SITE AND DISPOSED OF IN A LAWFUL MANNER.
- 29. ALL BROCHURES, OPERATING AND MAINTENANCE MANUALS, CATALOGS, SHOP DRAWINGS, AND OTHER DOCUMENTS SHALL BE TURNED OVER TO THE GENERAL CONTRACTOR AT COMPLETION OF CONSTRUCTION AND PRIOR TO PAYMENT.
- 30. CONTRACTOR SHALL SUBMIT A COMPLETE SET OF AS-BUILT REDLINES TO THE GENERAL CONTRACTOR UPON COMPLETION OF PROJECT AND PRIOR TO FINAL PAYMENT.
- 31. CONTRACTOR SHALL LEAVE PREMISES IN A CLEAN CONDITION,
- 32. THE PROPOSED FACILITY WILL BE UNMANNED AND DOES NOT REQUIRE POTABLE WATER OR SEWER SERVICE, AND IS NOT FOR HUMAN HABITAT (NO HANDICAP ACCESS REQUIRED).
- 33. OCCUPANCY IS LIMITED TO PERIODIC MAINTENANCE AND INSPECTION, APPROXIMATELY 2 TIMES PER MONTH BY ATAIT TECHNICIANS.
- 34. NO OUTDOOR STORAGE OR SOLID WASTE CONTAINERS ARE PROPOSED.
- 35. ALL MATERIAL SHALL BE FURNISHED AND WORK SHALL BE PERFORMED IN ACCORDANCE WITH THE LATEST REVISION OF AT&T GROUNDING STANDARD "GROUNDING AND BONDING REQUIREMENTS FOR NETWORK FACILITIES (ATT—TP—76416) AND "TECHNICAL SPECIFICATION FOR CONSTRUCTION OF GSM/GPRS WIRELESS SITES" (ATT—TP—76300). IN CASE OF A CONFLICT BETWEEN THE CONSTRUCTION SPECIFICATION AND THE DRAWINGS, THE DRAWINGS SHALL GOVERN.
- 36. CONTRACTORS SHALL BE RESPONSIBLE FOR OBTAINING ALL PERMITS AND INSPECTIONS REQUIRED FOR CONSTRUCTION. IF CONTRACTOR CANNOT OBTAIN A PERMIT, THEY MUST NOTIFY THE GENERAL CONTRACTOR IMMEDIATELY.
- 37. CONTRACTOR SHALL REMOVE ALL TRASH AND DEBRIS FROM THE SITE ON A DAILY BASIS.
- 38. INFORMATION SHOWN ON THESE DRAWINGS WAS OBTAINED FROM SITE VISITS AND/OR DRAWINGS PROVIDED BY THE SITE OWNER. CONTRACTORS SHALL NOTIFY THE ENGINEER OF ANY DISCREPANCIES PRIOR TO ORDERING MATERIAL OR PROCEEDING WITH CONSTRUCTION.
- 39. NO WHITE STROBIC LIGHTS ARE PERMITTED. LIGHTING IF REQUIRED, WILL MEET FAA STANDARDS AND REQUIREMENTS.
- 40. ALL COAXIAL CABLE INSTALLATIONS TO FOLLOW MANUFACTURER'S INSTRUCTIONS AND RECOMMENDATIONS.

ANTENNA MOUNTING

- 41. DESIGN AND CONSTRUCTION OF ANNTENNA SUPPORTS SHALL CONFORM TO CURRENT ANSI/TIA-222 OR APPLICABLE LOCAL CODES.
- 42. ALL STEEL MATERIALS SHALL BE GALVANIZED AFTER FABRICATION IN ACCORDANCE WITH ASTM A123 "ZINC (HOT-DIP GALVANIZED) COATINGS ON IRON AND STEEL PRODUCTS", UNLESS NOTED OTHERWISE.
- 43. ALL BOLTS, ANCHORS AND MISCELLANEOUS HARDWARE SHALL BE GALVANIZED IN ACCORDANCE WITH ASTM A153 "ZINC-COATING (HOT-DIP) ON IRON AND STEEL HARDWARE", UNLESS NOTED OTHERWISE.
- 44. DAMAGED GALVANIZED SURFACES SHALL BE REPAIRED BY COLD GALVANIZING IN ACCORDANCE WITH ASTM A780.
- 45. ALL ANTENNA MOUNTS SHALL BE INSTALLED WITH LOCK WASHERS AND/OR DOUBLE NUTS, AND SHALL BE TORQUED TO MANUFACTURER'S RECOMMENDATIONS.
- 46. CONTRACTOR SHALL INSTALL ANTENNA PER MANUFACTURER'S RECOMMENDATION FOR INSTALLATION AND GROUNDING.
- 47. ALL UNUSED PORTS ON ANY ANTENNAS SHALL BE TERMINATED WITH A 50-OHM LOAD TO ENSURE ANTENNAS PERFORM AS DESIGNED.
- 48. PRIOR TO SETTING ANTENNA AZIMUTHS AND DOWNTILTS, ANTENNA CONTRACTOR SHALL CHECK THE ANTENNA MOUNT FOR TIGHTNESS AND ENSURE THAT THEY ARE PLUMB. ANTENNA AZIMUTHS SHALL BE SET FROM TRUE NORTH AND BE ORIENTED WITHIN $\pm 3^{\circ}$ AS DEFINED BY THE RFDS. ANTENNA DOWNTILTS SHALL BE WITHIN $\pm 0.5^{\circ}$ AS DEFINED BY THE RFDS. REFER TO ND-00246.
- 49. JUMPERS FROM THE TOWER MOUNTED AMPLIFIERS MUST TERMINATE TO OPPOSITE POLARIZATIONS IN EACH SECTOR.
- 50. CONTRACTOR SHALL RECORD THE SERIAL NUMBER, SECTOR, AND POSITION OF EACH ACTUATOR INSTALLED AT THE ANTENNAS AND PROVIDE THE INFORMATION TO AT&T.
- 51. ANTENNAS SHALL HAVE A 3'-0" MINIMUM CENTER-TO-CENTER HORIZONTAL SEPARATION.

TORQUE REQUIREMENTS

- 52. ALL RF CONNECTIONS SHALL BE TIGHTENED BY A TORQUE WRENCH.
- 53. A TORQUE MARK FORMING A CONTINUOUS STRAIGHT LINE IS TO BE MADE IN THE FOLLOWING APPLICATIONS:
- A. RF CONNECTIONS MARK BOTH SIDES OF THE CONNECTOR
- B. GROUNDING AND ANTENNA HARDWARE MARK ON THE NUT SIDE OF THE BOLT, STARTING FROM

- THE THREADS TO THE SOLID SURFACE. SOLID SURFACE EXAMPLES INCLUDE A GROUND BAR OR
- 54. ALL 8M ANTENNA HARDWARE SHALL BE TIGHTENED TO 9 LB-FT (12 NM).
- 55. ALL 12M ANTENNA HARDWARE SHALL BE TIGHTENED TO 43 LB-FT (58 NM).
- 56. ALL GROUNDING HARDWARE SHALL BE TIGHTENED UNTIL THE LOCK WASHER COLLAPSES AND THE GROUNDING HARDWARE IS NO LONGER LOOSE.
- 57. ALL DIN TYPE CONNECTIONS SHALL BE TIGHTENED TO 18-22 LB-FT (24.4 29.8 NM).
- 58. ALL N TYPE CONNECTIONS SHALL BE TIGHTENED TO 15-20 LB-IN (1.7 2.3 NM).

CIDED . DOWER CARLE MOUNTING

- 59. THE FIBER OPTIC TRUNK CABLES SHALL BE INSTALLED IN CONDUITS, CHANNEL CABLE TRAYS, OR CABLE TRAY. WHEN INSTALLING FIBER OPTIC TRUNK CABLES INTO A CABLE TRAY SYSTEM, THEY SHALL BE INSTALLED INTO AN INTER DUCT AND A PARTITION BARRIER SHALL BE INSTALLED BETWEEN THE 600 VOLT CABLES AND THE INTER DUCT IN ORDER TO SEGREGATE CABLE TYPES. OPTIC FIBER TRUNK CABLES SHALL HAVE APPROVED CABLE RESTRAINTS EVERY (60) SIXTY FEET AND SHALL BE SECURELY FASTENED TO THE CABLE TRAY SYSTEM. NFPA 70 (NEC) ATRICLE 770 RULES SHALL APPLY.
- 60. TYPE TC-ER CABLES SHALL BE INSTALLED INTO CONDUITS OR CABLE TRAYS, AND SHALL BE SECURED AT INTERVALS NOT EXCEEDING (6) FEET. WHERE TYPE TC-ER CABLES ARE NOT SUBJECT TO PHYSICAL DAMAGE, CABLES SHALL BE PERMITTED TO MAKE A TRANSITION BETWEEN CONDUITS OR CABLE TRAYS THAT ARE SERVICING UTILIZATION EQUIPMENT OR DEVICES. A TRANSITION DISTACE EXCEEDING (6) FEET REQUIRES CONTINUOUS SUPPORTING. NFPA 70 (NEC) ARTICLES 336 AND 392 RULES SHALL APPLY.
- WHEN INSTALLING OPTIC FIBER TRUNK CABLES OR TYPE TC-ER CABLES INTO CONDUITS, NFPA 70 (NEC) ARTICLE 300 RULES SHALL APPLY.

COAXIAL CABLE NOTES

- 62. TYPES AND SIZES OF THE ANTENNA CABLES ARE BASED ON ESTIMATED LENGTHS. PRIOR TO ORDERING CABLE, CONTRACTOR SHALL VERIFY ACTUAL LENGTH BASED ON CONSTRUCTION LAYOUT AND NOTIFY THE PROJECT MANAGER IF ACTUAL LENGTHS EXCEED ESTIMATED LENGTHS.
- 63. CONTRACTOR SHALL VERIFY THAT THE DOWNTILT OF EACH ANTENNA IS WITHIN +/- 0.5 DEGREES OF SPECIFICATION WITH AN OCI APPROVED DIGITAL LEVEL.
- 64. CONTRACTOR SHALL CONFIRM COAX COLOR CODING PRIOR TO CONSTRUCTION. REFER TO "ANTENNA SYSTEM LABELING STANDARD" ND-00027 LATEST VERSION.
- 65. ALL JUMPERS TO THE ANTENNAS FROM THE MAIN TRANSMISSION LINE SHALL BE 1/2" DIA. LDF AND SHALL NOT EXCEED 6"-0".
- 66. ALL COAXIAL CABLE SHALL BE SECURED TO THE DESIGNED SUPPORT STRUCTURE, IN AN APPROVED MANNER, NOT TO EXCEED 4'-0° OC.
- 67. COAXIAL CABLE SHALL BE SECURED TO THE DESIGNATED SUPPORT STRUCTURE(S) PER MANUFACTURER'S SPECIFICATIONS.
- 68. CONTRACTOR SHALL FOLLOW ALL MANUFACTURER'S RECOMMENDATIONS REGARDING BOTH THE INSTALLATION AND GROUNDING OF ALL COAXIAL CABLES, CONNECTORS, ANTENNAS, AND ALL OTHER FOLIPMENT.
- 69. CONTRACTOR SHALL WEATHERPROOF ALL ANTENNA CONNECTORS WITH SELF AMALGAMATING TAPE. WEATHERPROOFING SHALL BE COMPLETED IN STRICT ACCORDANCE WITH AT&T STANDARDS.


GENERAL CABLE AND EQUIPMENT NOTES

- 70. CONTRACTOR SHALL BE RESPONSIBLE TO VERIFY ANTENNA, TMAS, DIPLEXERS, COAX CONFIGURATION, MAKES, AND MODELS PRIOR TO INSTALLATION.
- 71. ALL CONNECTIONS FOR HANGERS, SUPPORTS, BRACING, ETC. SHALL BE INSTALLED PER TOWER MANUFACTURER'S RECOMMENDATIONS.
- 72. CONTRACTOR SHALL REFERENCE THE TOWER STRUCTURAL ANALYSIS/DESIGN DRAWINGS FOR DIRECTIONS ON CABLE DISTRIBUTION/ROUTING.
- 73. AFTER INSTALLATION AND FINAL CONNECTIONS ARE MADE, ALL OUTDOOR RF CONNECTORS/CONNECTIONS SHALL BE WEATHERPROOFED, EXCEPT THE RET CONNECTORS, USING BUTYL TAPE OR OTHER APPROVED WEATHERPROOFING METHODS PER AT&T SPECIFICATIONS. BUTYL TAPE SHALL HAVE A MINIMUM OF ONE-HALF TAPE WIDTH OVERLAP ON EACH TURN AND EACH LAYER SHALL BE WRAPPED THREE TIMES. WEATHERPROOFING SHALL BE SMOOTH WITHOUT BUCKLING. BUTYL BLEEDING IS NOT ALLOWED. SELF BONDING TAPE AND PLASTIC ENCLOSURES ARE PERMITTED PER ATT--002--290-041, SECTION 7.
- 74. IF REQUIRED TO PAINT ANTENNAS AND/OR COAX:
- A. TEMPERATURE SHALL BE ABOVE 50 DEGREES FAHRENHEIT.
- B. PAINT COLOR MUST BE APPROVED BY BUILDING OWNER/LANDLORD.
- C. FOR REGULATED TOWERS, FAA/FCC APPROVED PAINT IS REQUIRED.
 D. DO NOT PAINT OVER COLOR CODING OR ON EQUIPMENT MODEL NUMBERS.
- 75. ALL CABLES SHALL BE GROUNDED WITH COAXIAL CABLE GROUND KITS. FOLLOW THE MANUFACTURER'S RECOMMENDATIONS:
- A. GROUNDING AT THE ANTENNA LEVEL.
- B. GROUNDING AT THE MID LEVEL, TOWERS WHICH ARE OVER 200'-0", ADDITIONAL CABLE GROUNDING REQUIRED.
- C. GROUNDING AT BASE OF TOWER PRIOR TO TURNING HORIZONTAL.
- D. GROUNDING OUTSIDE THE EQUIPMENT SHELTER AT ENTRY PORT.
- E. GROUNDING INSIDE THE EQUIPMENT SHELTER AT THE ENTRY PORT.
- ANTENNA CONTRACTOR SHALL FURNISH AND INSTALL A 10'-0" T-BOOM SECTOR ANTENNA MOUNT INCLUDING ALL HARDWARE, IF APPLICABLE.



84 DEERFIELD LN MERIDEN, CT 06450



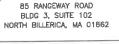



DRAWING SCALES ARE INTENDED FOR 11"x17" SIZE PRINTED MEDIA ONLY.

IRVING, TEXAS 75038

1-855-669-5421

	S	SUBMITTALS	
REV	DATE	DESCRIPTION	BY
Α	11/03/22	90% CD	JSR
В	11/09/22	90% CD	DIN
С	11/30/22	90% CD	DIN
0	01/31/23	100% CD	DIN
1	02/21/23	ADDING FALL ZONE	JSR
2	04/20/23	REDLINES PER CLIENT	JSR
3	05/05/23	REDLINES PER CLIENT	JSR
4	08/19/23	10' EXTENSION	JSR



SITE INFORMATION

WAREHAM BROWN ST MA1883

> FA#: 15283436 USID: 317182


25 BROWN STREET WAREHAM, MA 02571

SHEET DESCRIPTION

GENERAL NOTES

SHEET NO.


T-2

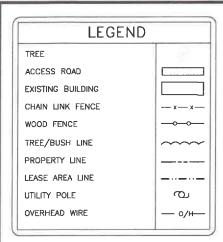

GENERAL NOTES:

- THE CONTRACTOR SHALL COMPLY WITH ALL APPLICABLE CODES ORDINANCES, LAWS AND REGULATIONS OF ALL MUNICIPALITIES, UTILITIES COMPANY OR OTHER PUBLIC AUTHORITIES.
- 2. THE CONTRACTOR SHALL BE RESPONSIBLE FOR OBTAINING ALL PERMITS AND INSPECTIONS THAT MAY BE REQUIRED BY ANY FEDERAL, STATE, COUNTY OR MUNICIPAL AUTHORITIES.
- 3. THE CONTRACTOR SHALL NOTIFY THE AT&T CONSTRUCTION MANAGER IN WRITING, OF ANY CONFLICT, ERRORS OR OMISSION PRIOR TO THE SUBMISSION OF BIDS OR PERFORMANCE OF WORK. MINOR OMISSIONS OR ERRORS IN THE BID DOCUMENTS SHALL NOT RELIEVE THE CONTRACTOR FROM RESPONSIBILITY FOR THE OVERALL INTENT OF THESE DRAWINGS.
- 4. THE CONTRACTOR SHALL BE RESPONSIBLE FOR PROTECTING ALL EXISTING SITE IMPROVEMENTS PRIOR TO COMMENCING CONSTRUCTION. THE CONTRACTOR SHALL REPAIR ANY DAMAGE CAUSED AS A RESULT OF CONSTRUCTION OF THIS FACILITY.
- 5. THE SCOPE OF THE WORK FOR THIS PROJECT SHALL INCLUDE PROVIDING ALL MATERIALS, EQUIPMENT AND LABOR REQUIRED TO COMPLETE THIS PROJECT. ALL EQUIPMENT SHALL BE INSTALLED IN ACCORDANCE WITH THE MANUFACTURER'S RECOMMENDATIONS.
- 6. THE CONTRACTOR SHALL VISIT THE PROJECT SITE PRIOR TO SUBMITTING A BID TO VERIFY THAT THE PROJECT CAN BE CONSTRUCTED IN ACCORDANCE WITH THE CONTRACT DOCUMENTS.
- 7. CONTRACTOR SHALL MAKE A UTILITY "ONE CALL" TO LOCATE ALL UTILITIES AND NOTIFY UNDERGROUND FACILITIES PROTECTIVE ORGANIZATION AT (800) 424-5555 PRIOR TO EYCALADION AT SITE
- 8. ANY UNDERGROUND UTILITIES OR STRUCTURES THAT EXIST BENEATH THE PROJECT AREA, CONTRACTOR MUST LOCATE IT AND CONTACT THE APPLICANT & THE OWNER'S PEOPLES INTATIVE
- NO SIGNIFICANT NOISE, SMOKE, DUST, OR ODOR WILL RESULT FROM THIS FACILITY.
- 10. POWER TO THE FACILITY WILL BE MONITORED BY A SEPARATE METER.
- 11. THERE ARE NO COMMERCIAL SIGNS PROPOSED FOR THIS INSTALLATION.
- 12. NO FILL OR EMBANKMENT MATERIAL SHALL BE PLACED IN ANY FILL OR EMBANKMENT.
- 13. ALL EXISTING ACTIVE SEWER, WATER, GAS, ELECTRIC, AND OTHER UTILITIES WHERE ENCOUNTERED IN THE WORK, SHALL BE PROTECTED AT ALL TIMES, AND WHERE DIRECTED BY UTILITY OWNER. EXTREME CAUTION SHOULD BE USED BY THE CONTRACTOR WHEN EXCAVATING OR PIER DRILLING AROUND OR NEAD LITTLITIES.
- 14. THE AREAS DISTURBED DUE TO CONSTRUCTION ACTIVITY SHALL BE GRADED AND RESTORED PER CODE/LANDLORD REQUIREMENTS.
- 15. CONTRACTOR SHALL MINIMIZE DISTURBANCE TO EXISTING SITE DURING CONSTRUCTION, EROSION CONTROL MEASURES SHALL BE IN CONFORMANCE WITH THE LOCAL GUIDELINES FOR EROSION AND SEDIMENT CONTROL, AND COORDINATED WITH MUNICIPALITY.
- THE MUNICIPALITY.

 16. UTILITY WARNING TAPE SHALL BE PLACED ABOVE ALL NEW CONDUITS AT MAX 18" DEPTH BELOW GRADE.

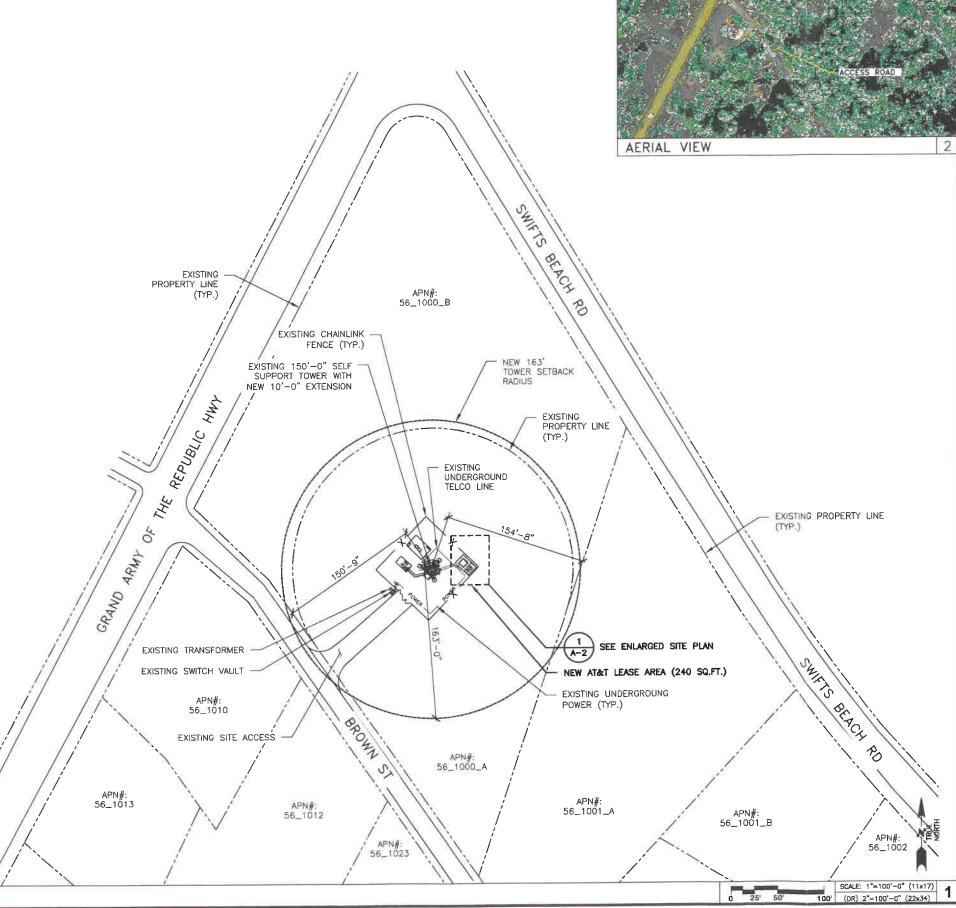





85 RANGEWAY ROAD BLDG 3, SUITE 102 NORTH BILLERICA, MA 01862



1825 W. WALNUT HILL LANE, SUITE 120 IRVING, TEXAS 75038 1-855-669-5421

DRAWING SCALES ARE INTENDED FOR 11"x17" SIZE PRINTED MEDIA ONLY.

4					
	5	SUBMITTALS			
REV	V DATE DESCRIPTION B				
A	11/03/22	90% CD	JSR		
В	11/09/22	80% CD	DIN		
¢	11/30/22	90% CD	DIN		
0	01/31/23	100% CD	DIN		
1	02/21/23	ADDING FALL ZONE	JSR		
2	04/20/23	REDLINES PER CLIENT	JSR		
3	05/05/23	REDLINES PER CLIENT	JSR		
4	08/19/23	10' EXTENSION	JSR		



SITE INFORMATION

WAREHAM BROWN ST

MA1883

FA#: 15283436

USID: 317182


25 BROWN STREET WAREHAM, MA 02571

SHEET DESCRIPTION

OVERALL SITE PLAN

SHEET NO.

A-1

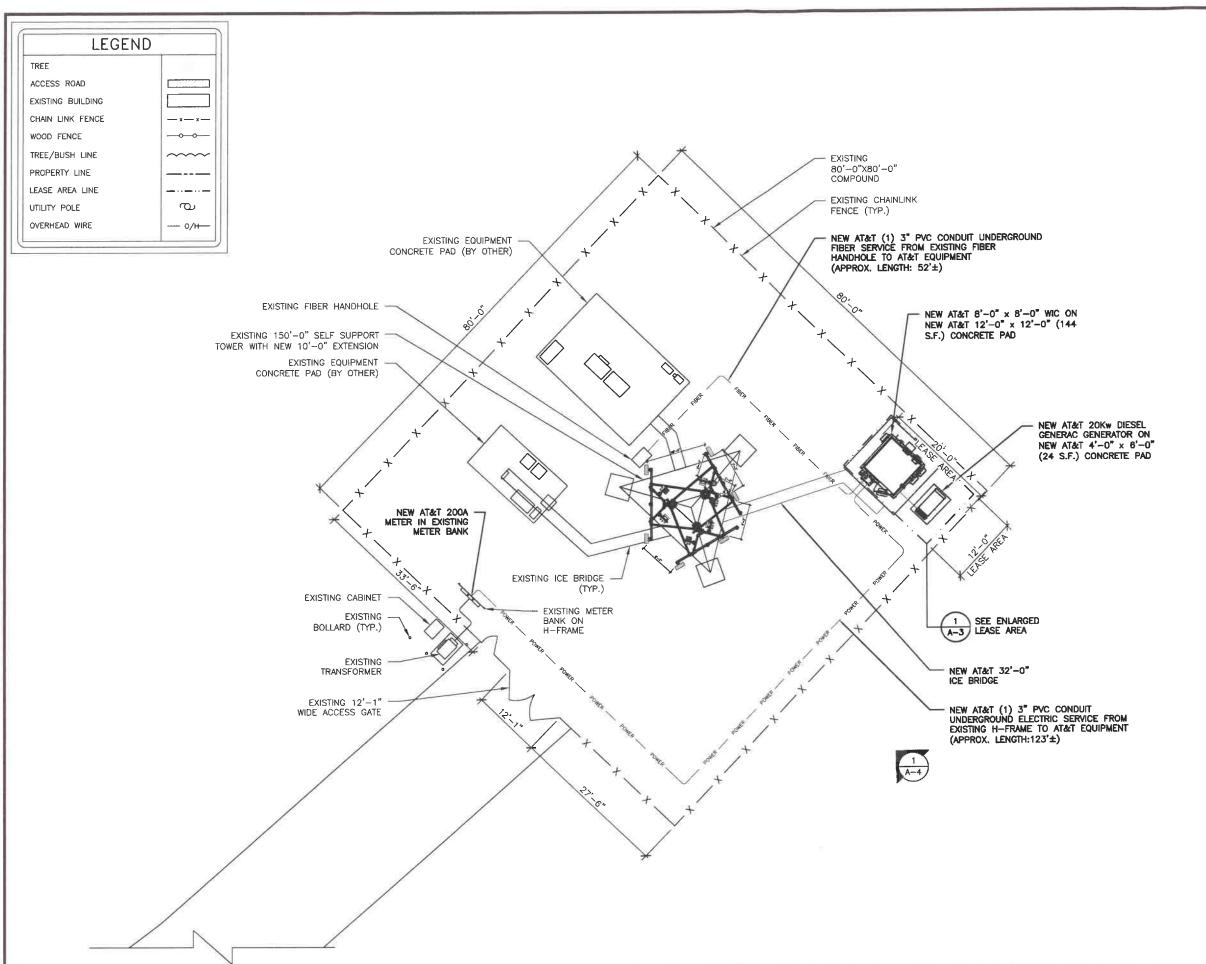

ENLARGED SITE PLAN





85 RANGEWAY ROAD BLDG 3, SUITE 102 NORTH BILLERICA, MA 01862



1825 W. WALNUT HILL LANE, SUITE 120 IRVING, TEXAS 75038 1-855-669-5421

DRAWING SCALES ARE INTENDED FOR 11°x17° SIZE PRINTED MEDIA ONLY.

	SUBMITTALS					
REV	DATE	DESCRIPTION	BY			
Α	11/03/22	90% CD	JSR			
В	11/09/22	90% CD	DIN			
С	11/30/22	90% CD	DIN			
0	01/31/23	100% CD	DIN			
1	02/21/23	ADDING FALL ZONE	JSR			
2	04/20/23	REDLINES PER CLIENT	JSR			
3	05/05/23	REDLINES PER CLIENT	JSR			
4	08/19/23	10' EXTENSION	JSR			



SITE INFORMATION

WAREHAM BROWN ST

MA1883

FA#: 15283436

USID: 317182

25 BROWN STREET WAREHAM, MA 02571

SHEET DESCRIPTION


ENLARGED SITE PLAN

SHEET NO.

A-2



SCALE: 1/16"=1"-0" (11x17) 16' (OR) 1/8"=1"-0" (22x34)

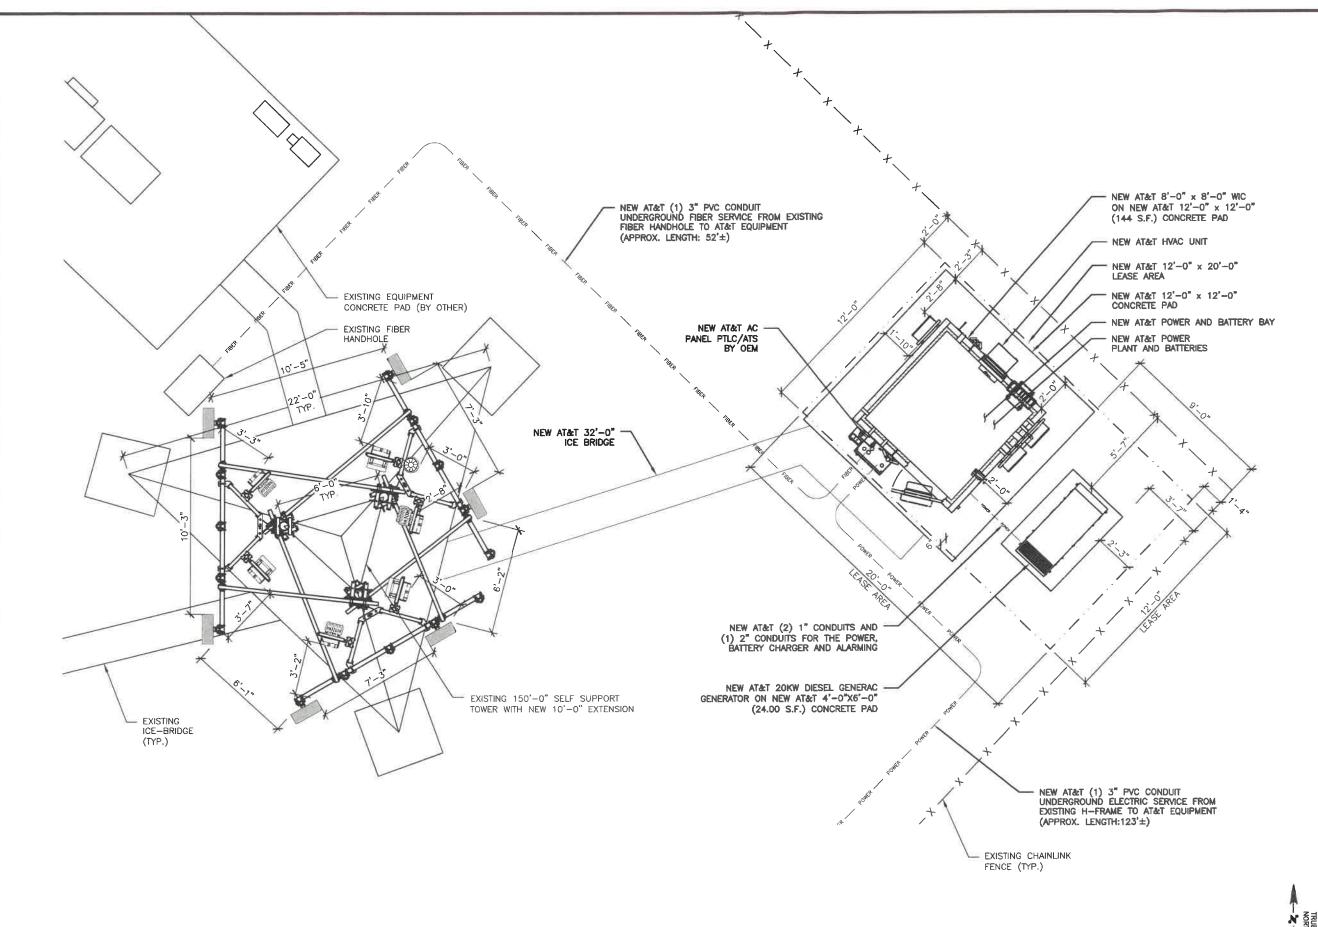



84 DEERFIELD LN MERIDEN, CT 06450

ssmartlink

85 RANGEWAY ROAD BLDG 3, SUITE 102 NORTH BILLERICA, MA 01862



1825 W. WALNUT HILL LANE, SUITE 120 IRVING, TEXAS 75038 1-855-669-5421

DRAWING SCALES ARE INTENDED FOR 11"x17" SIZE PRINTED MEDIA ONLY.

	S	SUBMITTALS	
REV	DATE	DESCRIPTION	BY
Α	11/03/22	90% CD	JSR
В	11/09/22	90% CD	DIN
¢	11/30/22	90% CD	DiN
0	01/31/23	100% CD	DIN
1	02/21/23	ADDING FALL ZONE	JSR
2	04/20/23	REDLINES PER CLIENT	JSR
3	05/05/23	REDLINES PER CLIENT	JSR
4	06/19/23	10' EXTENSION	J5R



SITE INFORMATION

WAREHAM BROWN ST

MA1883

FA#: 15283436

USID: 317182

25 BROWN STREET WAREHAM, MA 02571


SHEET DESCRIPTION

EQUIPMENT AREA


SHEET NO.

A - 3

PROPOSED EQUIPMENT AREA

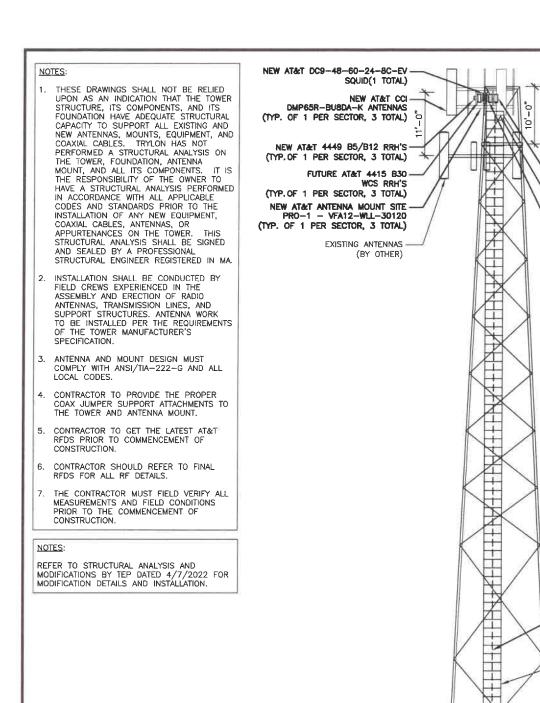

6	6	9	3	12
PROPOSED ANTENNAS	TOTAL ANTENNAS	PROPOSED RRHs	FUTURE WCS RRHs	TOTAL RRHs T INSTALL

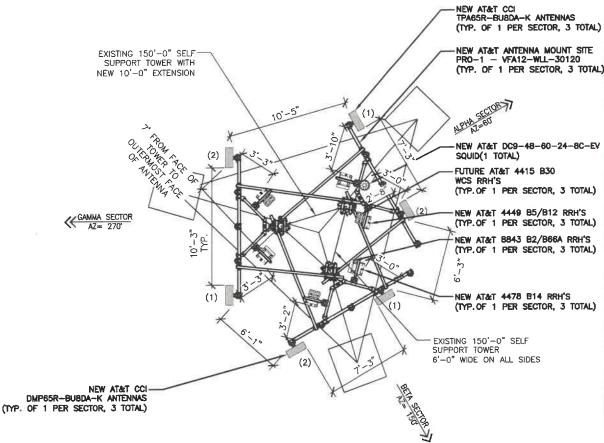







1825 W. WALNUT HILL LANE, SUITE 120 IRVING, TEXAS 75038 1-855-669-5421

DRAWING SCALES ARE INTENDED FOR 11"x17" SIZE PRINTED MEDIA ONLY.

		SUBMITTALS						
	REV	DATE	DESCRIPTION	BY				
	A	11/03/22	90% CD	JSR				
C-EV	В	11/09/22	90% CD	DIN				
	С	11/30/22	90% CD	DIN				
	0	01/31/23	100% CD	DIN				
TAL)	1	02/21/23	ADDING FALL ZONE	JSR				
ı's	2	04/20/23	REDLINES PER CLIENT	JSR				
OTAL)	3	05/05/23	REDLINES PER CLIENT	JSR				
H'S	4	06/19/23	10' EXTENSION	JSR				
OTAL)	_		·					



SITE INFORMATION

WAREHAM BROWN ST

MA1883

FA#: 15283436


USID: 317182

25 BROWN STREET WAREHAM, MA 02571

SHEET DESCRIPTION

ELEVATION AND ANTENNA LAYOUT

SHEET NO.

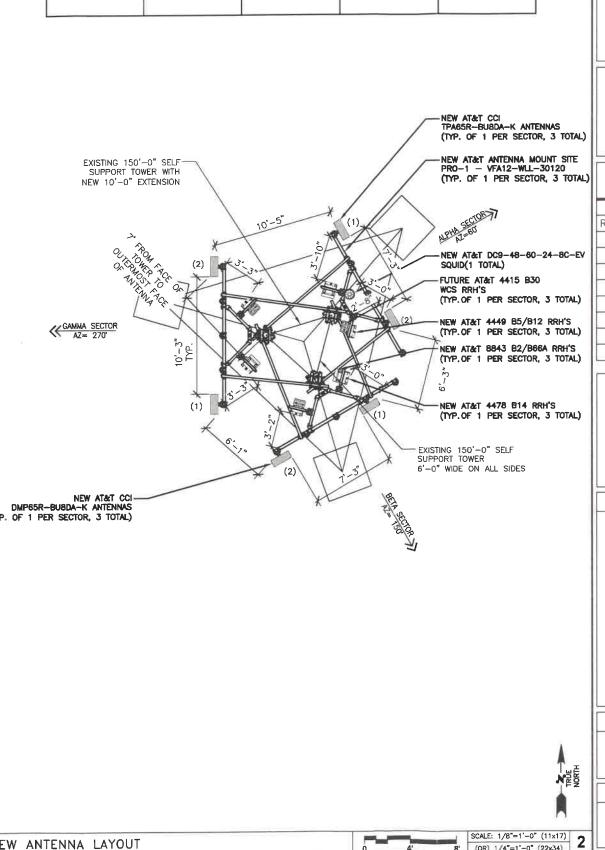

EAST ELEVATION

NEW AT&T ICE BRIDGE

GENERATOR

CONCRETE PAD

NEW AT&T 20Kw DIESEL

NEW AT&T 4'-0" x 6'-0"

NEW AT&T 8'-0"X8'-0" CWIC ON NEW AT&T 12'-0"X12'-0" CONCRETE PAD

FXISTING METER BANK

> SCALE: 1/16"=1'-0" (11x17) **1** NEW ANTENNA LAYOUT (OR) 1/8"=1'-0" (22x34)

TOP OF NEW AT&T ANTENNAS ELEV. 9 163'-0"± AGL

TOP OF NEW EXTENSION ELEV. • 160'-0"± AGL

OF NEW AT&T ANTENNAS ELEV. • 159'-0"± AGL

TOP OF EXISTING SELF

- NEW AT&T 8843 B2/B66A RRH'S

TPA65R-BUBDA-K ANTENNAS

- NEW AT&T 4478 B14 RRH'S

EXISTING 150'-0" SELF SUPPORT TOWER WITH

NEW 10'-0" EXTENSION

NEW AT&T FEEDLINES: (3) DC CABLES

EXISTING CABLE LADDER

(1) 18 PAIR FIBER TRUNKS

- NEW AT&T CCI

(TYP. OF 1 PER SECTOR, 3 TOTAL)

(TYP. OF 1 PER SECTOR, 3 TOTAL)

(TYP. OF 1 PER SECTOR, 3 TOTAL)

SUPPORT TOWER ELEV. 9 150'-0"± AGL

(OR) 1/4"=1'-0" (22x34)

				PROPOS	ED ANTENNA S	CHEDULE AND RF SYST	EM		
SECTOR	ANTENNA POSITION	ANTENNA MAKE/MODEL	AZIMUTH	RAD CENTER	TIP HEIGHT	RRH MAKE/MODEL	RAYCAP DEMARC SQUID	FEEDLINE	FEEDLINE LENGTH
	#1	CCI ANTENNAS TPA65R-BU8DA-K	60*	159'-0"	163'-0"	RRU 4478 B14 RRU 8843 B2/B66A	DC9-48-60-24-8C-EV	(3) DC CABLE	200'-0"
ALPHA #2	#2	CCI ANTENNAS DMP65R-BU8DA-K	60°	159'-0"	163'-0"	RRU 4449 B5/B12 (FUTURE) RRU 4415 B30 WCS	-	(1) 18 PAIR FIBER CABLE	
	#1	CCI ANTENNAS TPA65R-BU8DA-K	150"	159'-0"	163'-0"	RRU 4478 B14 RRU 8843 B2/B66A	_	_	_
BETA	#2	CCI ANTENNAS DMP65R-BU8DA-K	150"	159'-0"	163'-0"	RRU 4449 B5/B12 (FUTURE) RRU 4415 B30 WCS	-		
	#1	CCI ANTENNAS TPA65R-BU8DA-K	270°	159'-0"	163'-0"	RRU 4478 B14 RRU 8843 B2/B66A	-	_	_
GAMMA	#2	CCI ANTENNAS DMP65R-BU8DA-K	270°	159'-0"	163'−0*	RRU 4449 B5/B12 (FUTURE) RRU 4415 B30 WCS	-		

* DENOTES FUTURE RRH

FEEDLINE	FEEDLINE LENGTH	
POWER	200'-0"	
FIBER	200'-0"	

PROPOSED	PROPOSED	FUTURE	TOWER MOUNT
ANTENNAS	RRHs	RRHs	
6	9	3	(3) VFA12-WLL-30120







1825 W. WALNUT HILL LANE, SUITE 12: IRVING, TEXAS 75038 1-855-669-5421

DRAWING SCALES ARE INTENDED FOR 11"x17" SIZE PRINTED MEDIA ONLY.

	9	SUBMITTALS	
REV	DATE	DESCRIPTION	BY
Α	11/03/22	90% CD	JSR
В	11/09/22	90% CD	DIN
С	11/30/22	90% CD	DIN
0	01/31/23	100% CD	DIN
1	02/21/23	ADDING FALL ZONE	JSR
2	04/20/23	REDLINES PER CLIENT	JSR
3	05/05/23	REDLINES PER CLIENT	JSR
4	06/19/23	10' EXTENSION	JSR



SITE INFORMATION

WAREHAM BROWN ST MA1883

> FA#: 15283436 USID: 317182

25 BROWN STREET WAREHAM, MA 02571

SHEET DESCRIPTION

ANTENNA SCHEDULE

SHEET NO.

A - 5


CABLE COUNT			
QUANTITY CABLE TYPE			
3 DC CABLE			
1	18 PAIR FIBER CABLE		


CABLE LENGTH AND COUNT

SNAPTAK PIM FREE POLYMER HANGERS					
	PART #	AT&T ITEM NUMBER	CABLE SIZE RANGE	AT&T APPROVED CABLES	
	SSH-47	ANT. 16979	4.0 TO 7.0 MM	2 FIBER JUMPERS AND 4 FIBER JUMPERS	
TP	SSH-710	ANT. 16980	7 1 TO 10.0 MM	RET CABLES	
P	SSH-1014	ANT: 16981	10.1 TO 14.0 MM	2 CONDUCTOR POWER CABLES	
	SSH-1416	ANT. 16982	14.1 TO 15.0 MM	1/2" COAX CABLE JUMPERS	

NOTE:

- USE SNAPTAK PIM FREE POLYMER HANGERS FOR COAX, DC AND FIBER JUMPER SUPPORT.
- CONTRACTOR TO FOLLOW AT&T CONSTRUCTION STANDARDS DOCUMENT # ATT-CEM-18006 TITLED "HOSE CLAMP & METAL SNAP-IN SUPPORTS PIM PROBLEM RESOLUTION".

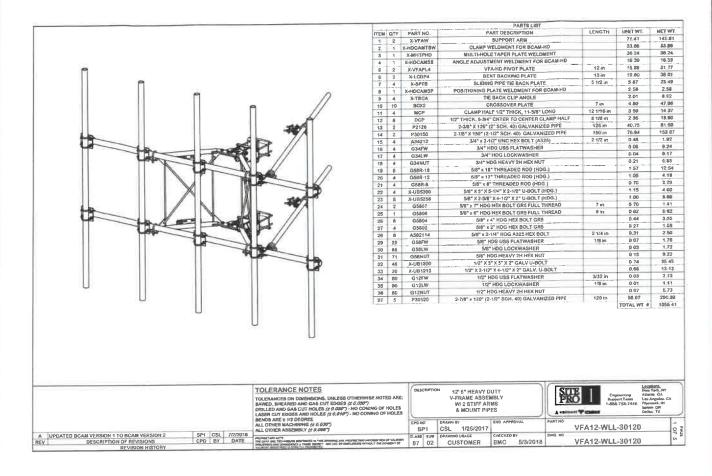

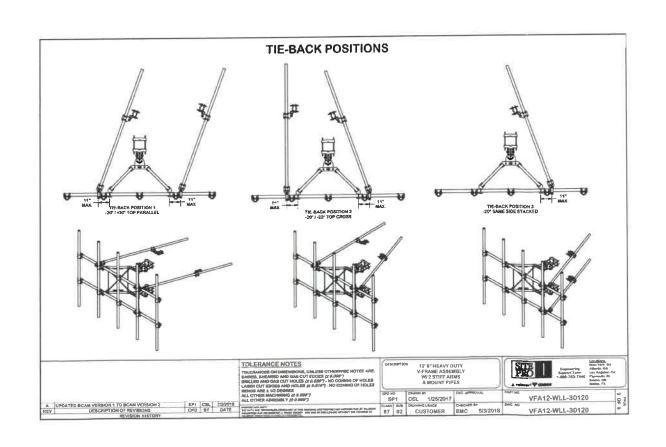





85 RANGEWAY ROAD BLDG 3, SUITE 102 NORTH BILLERICA, MA 01862



DRAWING SCALES ARE INTENDED FOR 11"x17" SIZE PRINTED MEDIA ONLY.

SUBMITTALS					
REV	EV DATE DESCRIPTION		BY		
A	11/03/22	90% CD	J\$R DIN		
В	11/09/22	90% CD			
C 11/30/22		90% CD	DIN		
0	01/31/23	100% CD	DfN		
1 02/21/23 2 04/20/23		ADDING FALL ZONE	JSR		
		REDLINES PER CLIENT	JSR		
3	05/05/23	REDLINES PER CLIENT	JSR		
4	06/19/23	10' EXTENSION	JSR		



SITE INFORMATION

WAREHAM BROWN ST MA1883

FA#: 15283436

USID: 317182

25 BROWN STREET WAREHAM, MA 02571

SHEET DESCRIPTION

CABLE AND MOUNT DETAILS

SHEET NO.

D - 6

PROPOSED MOUNT (VFA12-M3-WLL)

N.T.S.

3

SPECIFICATIONS.

SIDE

©

MEG: ERICSSON MODEL: RRUS 4449 85/812 HEIGHT: 1496 N

WIDTH: 1319 N DEPTH: 10.43 N

WEIGHT, 73 LBS

Distriction Barrel 3 and 2x83W on Bend 664. Carrier Capacity: Jo to 24 center and up to 55-70 III-IZ OBY/ for LTE

2x 10Gbbs CPRi Size and Weigh: iano Alka II. a BAAA

8 amenius pents, 47X/4RX for 2 bends with separate RF piorts.

Up to 320W RF Power shared between 2 bands

Exemples

14/20/4 per each basis of


94/20/4 per 62 and 4/50/4 on Band 65/4

RADIO 8843 - B2 + B66A (PREV 4443)

2x25A fuse (2 power connectors, 2 or 3 wire) (26A for 4x60W) AIBG TMA 6 RET support (2 Bias-T 1 AID port)

Type 4 3-18 RF connectors 2 external atomis 10 of -93 to -55 C



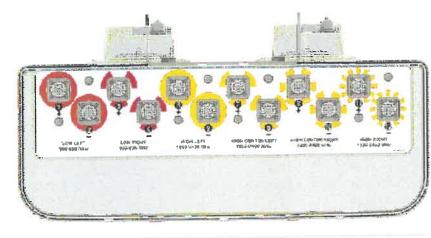

Dimensions (LxWxD) 95.0x20.7x7,7 in (2438x525x197 mm)

Survival Wind Speed > 150 mph (> 241 kph)

Front Wind Load 457 lbs (2033 N) @ 100 mps (161 kpn) Side Wind Load 209 lbs (929 Nr @ 100 mph :161 kph)

> -DOME COVER SECURING BAND AIR VALVE

> > LENGTH (H)

WIDTH (W)

RAYCAP DC9 (SQUID)

18.28"


10.24"

Equivalent Flat Plate Area 17.9 ft² (1.7 m²)

Weight * 87.1 lbs (39.5 kg)

Package Dimensions (LxWxD) 104.3x28.7x16.9 in (2650x730x430 immi

Package Weight 145 lbs (65 8 kg) Connector 12 × 4.3-10 female Mounting Pole 2 to 5 in (5 to 12 cm.

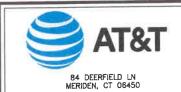



85 RANGEWAY ROAD BLDG 3, SUITE 102 NORTH BILLERICA, MA 01862



1825 W. WALNUT HILL LANE, SUITE 120 IRVING, TEXAS 75038 1-855-669-5421

DRAWING SCALES ARE INTENDED FOR 11"x17" SIZE PRINTED MEDIA ONLY.

	S	UBMITTALS		
REV DATE		DESCRIPTION	BY	
A	11/03/22 90% CD		JSR	
B 11/09/22 C 11/30/22		90% CD	DIN	
		90% CD		
0	01/31/23	100% CD	DIN	
1	02/21/23	ADDING FALL ZONE		
2 04/20/23		REDLINES PER CLIENT	JSR	
3	05/05/23	REDLINES PER CLIENT	JSR	
4	06/19/23	10' EXTENSION	JSR	

RRUS 4449 B5/B12 RRH DETAIL

FRONT

MOUNTING KE OPTIONS:

NOT TO SCALE

RRUS 8843 B2/B66A RRH DETAIL

NOT TO SCALE

TPA65R-BU8DA-K ANTENNA DETAIL

NOT TO SCALE

3

SITE INFORMATION

WAREHAM BROWN ST

MA1883

FA#: 15283436

USID: 317182


25 BROWN STREET WAREHAM, MA 02571

SHEET DESCRIPTION

EQUIPMENT DETAILS

SHEET NO.

D-7

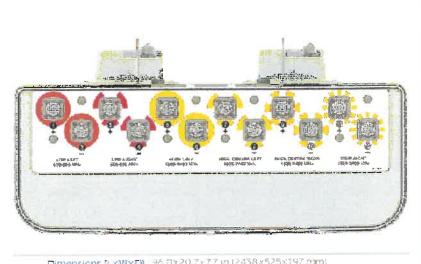

Dimensions (LxWxD) 96 0×20 7×77 in (2438×525×197 mm) Survival Wind Speed > 150 mph (> 241 kph)

Front Wind Load 457 lbs (2033 N) (a 100 mph (161 kph) Side Wind Load 209 lbs |929 N) @ 100 mph [161 kph]

Equivalent Flat Plate Area 17.9 ft2 (1.7 m2)

Weight * 119.0 bs (54.0 kg)

Connector 9 × 4.3-10 female Mounting Pole 2 to 5 in i5 to 12 cm

RAYCAP DC9 OVER VOLTAGE PROTECTOR DOME COVER DOME SECURING BAND RAYCAP SUPPLIED BASE ASSEMBLY POWER CABLE -INGRESS PORTS 00000 CABLE TIE BAR -

HEIGHT (D) 31.4" WEIGHT: 16.0 LBS SYSTEM TOP VIEW MOUNT 10.2 LBS TOTAL: 26.2 LBS =(12 PR) FIBER TRUNK INGRESS OPTIONAL ONE-HOLE GASKET FOR 18 (12 PR) FIBER TRUNK INGRESS -FIBER TRUNK CABLE NOT SHOWN FIBER JUMPER (6) (TYP) TOTAL OF 24 JUMPERS DC JUMPERS DC JUMPERS CLIP LUGS FOR ATTACHING DEVICE TO BASE ASSEMBLY SECURING BAND ALARM OPTION PORT-DC TRUNK INGRESS PORT

BOTTOM VIEW DC9-48-60-24-8C-EV

DC9-48-60-24-8C-EV RAYCAP DETAIL

DMP65R-BU8DA-K ANTENNA DETAIL

NOT TO


NOT TO


RRUS 4478 B14

- - TX = 758 768 MHz
 - -RX = 788 798 MHz
- > CPRI 2 ports x 2.5/4.9/9.9/10.1 Gbps. Install 1 GFP and connect 1 floer pair to the RRUS 4478 during initial install.
- Only use Ericsson supplied and approved SFPs RDH10265/25 until 12/1/2017. after use ROH10247/25
- 2 external alarm inputs
- : Max wind load @ 50m/sec = 260M
- Breaker size = 25A, DC Power Consumption = 650W (for dimensioning)
- 200mm horizontal separation required for side by side mounting
- 200mm separation required from antenna backplane to radio
- + 500mm/800mm venical outdoor/indoor separation required
- Min, Max DC cable size from squid to radio = 10,8 AWG.
 - Adapter is required for 2-wire connection
 - Shielded DC cable is required
- . Ground cable size = 2AWG
- . Dimensions (incl. handles, feet and fan unit)
 - ·· Height: 18.1* (460 mm)
 - Width: 13.4" (342 mm)
 - Dapth: 6.26" (210 mm)

RRUS 4478 B14 RRH DETAIL

Weight, excl. mounting hardware = 59.4 ibs (27 kg)

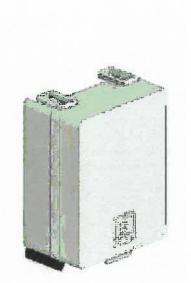

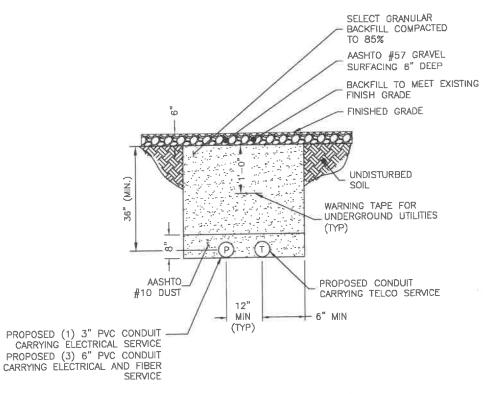

TELCO TO BE DETERMINED EXCAVATE EXISTING SUBGRADE AS REQUIRED TO INSTALL CONDUITS ACCORDING TO OSHA AND ALL APPLICABLE CODES.

NOT TO SCALE





85 RANGEWAY ROAD BLDG 3, SUITE 102 NORTH BILLERICA, MA 01862



DRAWING SCALES ARE INTENDED FOR 11"x17" SIZE PRINTED MEDIA ONLY.

SUBMITTALS					
REV	DATE	DESCRIPTION	BY		
A 11/03/22 B 11/09/22 C 11/30/22 O 01/31/23 1 02/21/23 2 04/20/23		90% CD	JSR DIN		
		90% CD			
		90% CD			
		100% CD	DIN		
		ADDING FALL ZONE	JSR		
		REDLINES PER CLIENT	JSR		
3	05/05/23	REDLINES PER CLIENT	JSR		
4	06/19/23	10' EXTENSION	JSR		



SITE INFORMATION

WAREHAM BROWN ST

MA1883

FA#: 15283436

USID: 317182

25 BROWN STREET WAREHAM, MA 02571

SHEET DESCRIPTION

FOUIPMENT DETAILS

SHEET NO.

D-8

RRUS 4415 B30 - R30 -TX = TBD-PX = TBD> CPRI 2 ports x 2.6/4.9/9.8/10.1 Ghps. Install 2 SFPs and connect 2 fiber pair to the RRUS 4415 during initial install. : Only dee Erlosson supplies and approved SFPs RDH10255/25 Exception: SEP7 (pair); RDH 102 70/1 and RDH 102 70/2 for CPRI > 10km : 2 external alarm inputs Max wind lose @ 50m/sec = 250N Breaker size = 25A, DC Power Consumption = 670 W (for dimensioning)

MANUFACTURER SUPPLIED

POLE MOUNTING BRACKET

ANTENNA MOUNTING PIPE

Exception: SEP7 RDH 10265G/fe* CPRI 1.4km to 10km

200mm horizontal separation reduked for side by side mounting.

. 200mm separation required from antenna backplane to radio

: 400mm vertical outdoor. Indoor separation required between 2 radios

i Sotirim vertical asparation below antenno

, Min Max DC cable size from squid to racio = 10.6 AWG

- Adapter is regulated for 2-wire connection

- Shielded OC cable is required

Ground cable size = 2AWG

TYPICAL TRENCH DETAIL

» Dimensions (incl. handles, feet and sunshield, woo fan Unit)

- Height: 16.5" (420 mm)

- Wieth: 13.4" (342 mm)


- Depth: 5.9" (148 mm)


Weight, excl. prounting hardwere = 43 lbs (21 kg)



RRH MOUNTING DETAIL

(FUTURE) 4415 B30 WCS RRH DETAIL

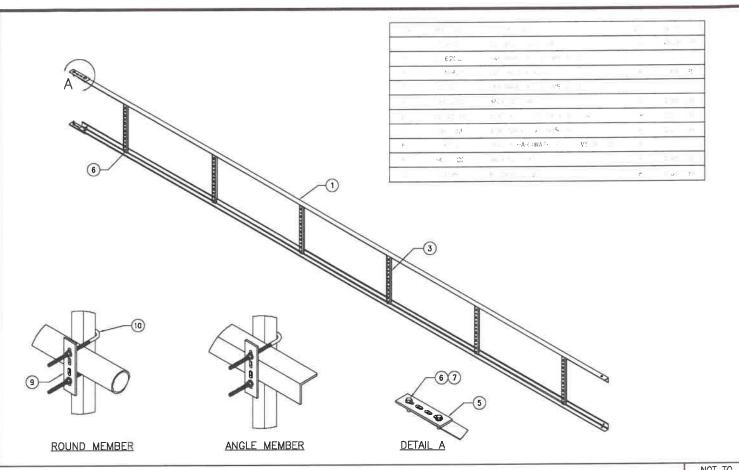

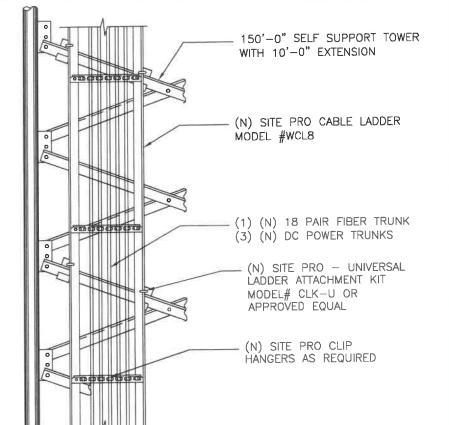







1825 W. WALNUT HILL LANE, SUITE 120 IRVING, TEXAS 75038 1-855-669-5421

DRAWING SCALES ARE INTENDED FOR 11"x17" SIZE PRINTED MEDIA ONLY.

١		5	SUBMITTALS	
ı	REV	DATE	DESCRIPTION	BY
ı	A	11/03/22	90% CD	JSR
l	8	11/09/22	80% CD	DIN
ı	С	11/30/22	90% CD	DłN
l	0 01/31/23		100% CD	DIN
l	1	02/21/23	ADDING FALL ZONE	JSR
١	2	04/20/23	REDLINES PER CLIENT	JSR
1	3	05/05/23	REDLINES PER CLIENT	JSR
1	4	08/19/23	10' EXTENSION	JSR



SITE INFORMATION

WAREHAM BROWN ST

MA1883

FA#: 15283436

USID: 317182

25 BROWN STREET WAREHAM, MA 02571

SHEET DESCRIPTION

EQUIPMENT DETAILS

SHEET NO.

D-9

NOT TO SCALE CABLE LADDER DETAIL

NOT USED

CABLE LADDER DETAIL

3 NOT USED

NOT TO SCALE




8'x8' SATN70

Concrete Walk-In-Cabinet (CWIC)

Sabreindustries.com


5031 Hazel Jones Road Bossier City, LA 71111 (318) 213-2900

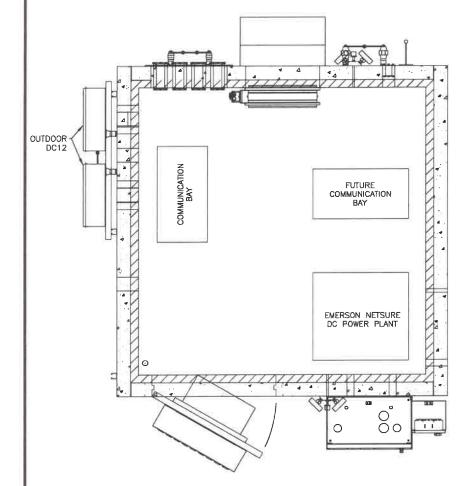



NOTE:
THE WIC IS EQUIPPED WITH TWO 19" WIDE EQUIPMENT BAYS AND EACH PROVIDES 45 RACK

OF THE WIC IS EQUIPPED WITH A FIRE DATCH PANEL (TFLCO RACK) AND THE UNITS. ONE RACK COMES EQUIPPED WITH A FIBER PATCH PANEL (TELCO RACK) AND THE OTHER DOES NOT (LTE RACK).

RF EQUIPMENT IS TO BE IN ONE RACK, AND ANY POWER EQUIPMENT IS TO BE IN THE OTHER RACK (CIVIL VENDOR TO ENSURE RACKS ARE CORRECTLY SEPARATED).

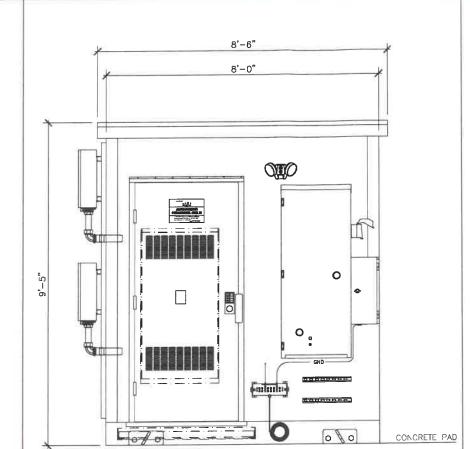

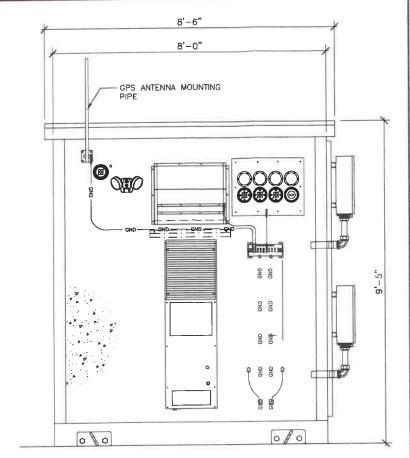

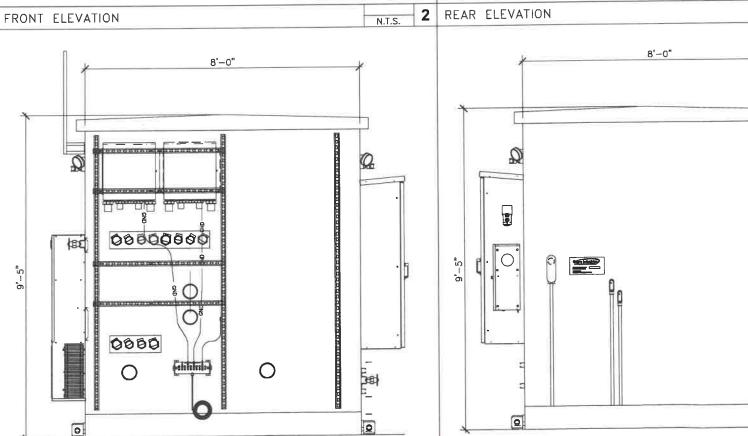






85 RANGEWAY ROAD BLDG 3, SUITE 102 NORTH BILLERICA, MA 01862



1825 W. WALNUT HILL LANE, SUITE 120 IRVING, TEXAS 75038 1-855-669-5421

DRAWING SCALES ARE INTENDED FOR 11°x17" SIZE PRINTED MEDIA ONLY.

			_	
SUBMITTALS				
REV DATE A 11/03/22		DESCRIPTION	BY JSR	
		90% CD		
В	11/09/22	90% CD	DIN	
C 11/30/22		90% CD	DIN	
0	01/31/23	100% CD	DIN	
1	02/21/23	ADDING FALL ZONE	JSR	
2 04/20/23		REDLINES PER CLIENT	JSR	
3	05/05/23	REDLINES PER CLIENT	JSR	
4	06/19/23	10' EXTENSION	JSR	

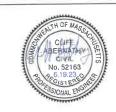

N.T.S.

N.T.S. **5**

SITE INFORMATION

WAREHAM BROWN ST

MA1883

FA#: 15283436

USID: 317182


25 BROWN STREET WAREHAM, MA 02571

SHEET DESCRIPTION

WALK IN CABINET DETAILS

SHEET NO.


D - 10

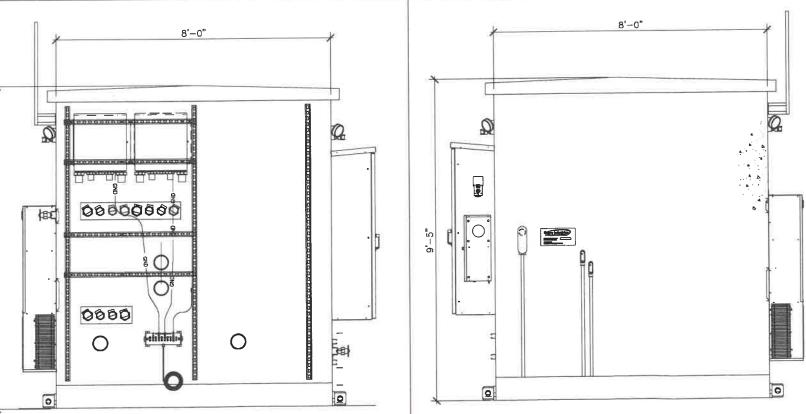


CONCRETE WALK-IN-CABINET PLAN (CWIC)

1 SIDE ELEVATION

N.T.S. 4 SIDE ELEVATION

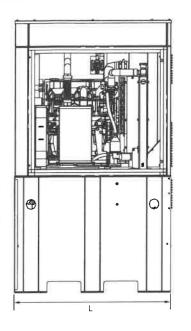

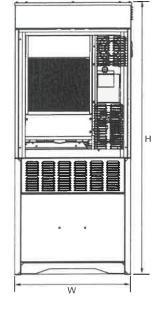

Level 2 Sound Attenuation Enclosure			
Run Time Hours	48		
Usable Capacity Gal (L)	92 (348.2)		
L \ A L L ! ()	48 x 36 x 90		
L x W x H in (mm)	(1219.2 x 914.4 x 2286)		
Weight lbs (kg)	2400 (1089)		
Sound Level	71 dBA		

OPERATING DATA

POWER RATINGS

Single-Phase 120/240 VAC @1.0pf 20 kW Amps: 83 Circuit Breaker Size 100A

FUEL CONSUMPTION RATES*

Diesel - gph (lph)

		91	()
Percent	Load		Standby
25%		0.	.74 (2.80)
50%		0.	.99 (3.75)
75%		1.	41 (5.30)
100%		1.	.90 (7.19)

^{*} Fuel supply installation must accommodate fuel consumption rates at 100% load.

COOLING

		Standby
Coolant Flow per Minute	gpm (lpm)	11.9 (45)
Coolant System Capacity	gal (L)	3.5 (13.2)
Heat Rejection to Coolant	BTU/hr	238,200
Inlet Air	cfm (m3/min)	2365 (67)
Max. Operating Ambient Temperature (Before Derate)	°F (°C)	77° (25°)
Maximum Radiator Backpressure	in H2O	0.50

COMBUSTION AIR REQUIREMENTS

Standby

Flow at Rated Power cfm (m3/min) 88 (2.49)

ENGINE

EXHAUST

		Standby			Standby
Rated Engine Speed	rpm 18	00	Exhaust Flow (Rated Output)	cfm (m3/min) 1	193 (328)
Horsepower at Rated kW**	hp	33.5	Max. Backpressure (Post Silencer)	inHg (kPa)	1.38 (4.67)
Piston Speed	ft/min	1220.47	Exhaust Temp (Rated Output - Post Silend	er) °F (°C)	928 (497.7)
RMED	nsi	96.5			

^{**} Refer to "Emissions Data Sheet" for maximum bHP for EPA and SCAQMD permitting purposes.

SDC20 | 2.5L | 20 kW - AC INDUSTRIAL DIESEL GENERATOR



Model G007098-0 (Steel)

EPA Certified Stationary Emergency

APPLICATION AND ENGINEERING DATA

ENGINE SPECIFICATIONS

General

Make	Mitsubishi
EPA Emissions Compliance	Interim Tier 4
Cylinder #	4
Туре	In-Line
Displacement - L (Cu In)	2.5 (158)
Bore - mm (in)	88 (3.5)
Stroke - mm (in)	103 (4.1)
Compression Ratio	22:1
Intake Air Method	Naturally Aspirated

Engine Governing

Governor Electronic Isochronous Frequency Regulation (Steady State) \pm 0.25%

Lubrication System

Oil Pump Type Trochoid Gear Pump
Oil Filter Type Filtering Paper, Full Flow
Crankcase Capacity - L (qts) 6.5 (6.9)

Cooling System

Cooling System Type	Forced Circulation
Water Pump Type	Centrifugal Pump
Fan Type	Pusher
Fan Speed (rpm)	2100
Fan Diameter - mm (in)	431.8 (17)
Coolant Heater Wattage	1000
Coolant Heater Voltage	120

Fuel System

Fuel Type	Ultra Low Sulfur Diesel
Fuel Specifications	ASTM
Fuel Filtering (microns)	6
Fuel Inject Pump Make	Bosch
Injector Type	Engine Driven Gear
Engine Type	Diesel
Fuel Supply Line - mm (in.)	6.6 (0.26)
Engine Electrical System	

System Voltage	12 VDC
Battery Charger Alternator	12V-50A
Battery Size	650 CCA
Battery Group	35
Battery Voltage	12 VDC
Ground Polarity	Negative

ALTERNATOR SPECIFICATIONS

Field Type Revolving Load Capacity - Standby 100% Insulation Class - Rotor H Prototype Short Circuit Test Yes Insulation Class - Stator H Voltage Regulator Type Digital Total Harmonic Distortion <5% Number of Sensed Phases All Telephone Interference Factor (TIF) <45 Regulation Accuracy (Steady State) ±0.5% Standard Excitation Brushless	Insulation Class - Rotor Insulation Class - Stator Total Harmonic Distortion Telephone Interference Factor (TIF	H H <5% E) <45	Prototype Short Circuit Test Voltage Regulator Type Number of Sensed Phases	Yes Digital All
---------------------------------------------------------------------------------------------------------------------------------------------------------------------------------------------------------------------------------------------------------------------------------------------------------------------------------------------------	-----------------------------------------------------------------------------------------------------------------	-------------------------	-----------------------------------------------------------------------------------	-----------------------





BLDG 3, SUITE 102

NORTH BILLERICA, MA 01862



1825 W. WALNUT HILL LANE, SUITE 120 IRVING, TEXAS 75038 1-855-669-5421

DRAWING SCALES ARE INTENDED FOR 11"x17" SIZE PRINTED MEDIA ONLY.

	SUBMITTALS REV DATE DESCRIPTION BY				
REV					
A	11/03/22	90% CD	JSR		
8	11/09/22	80% CD	DIN		
С	11/30/22	90% CD	DIN		
0	01/31/23	100% CD	DIN		
1	02/21/23	ADDING FALL ZONE	JSR		
2	04/20/23	REDLINES PER CLIENT	JSR		
3	05/05/23	REDLINES PER CLIENT	JSR		
4	08/19/23	10' EXTENSION	JSR		



SITE INFORMATION

WAREHAM BROWN ST MA1883

FA#: 15283436

USID: 317182

25 BROWN STREET WAREHAM, MA 02571

SHEET DESCRIPTION


WALK IN CABINET DETAILS

SHEET NO.

D - 11

20KW AC GENERATOR (SDC20 2.5L)

NOT TO SCALE

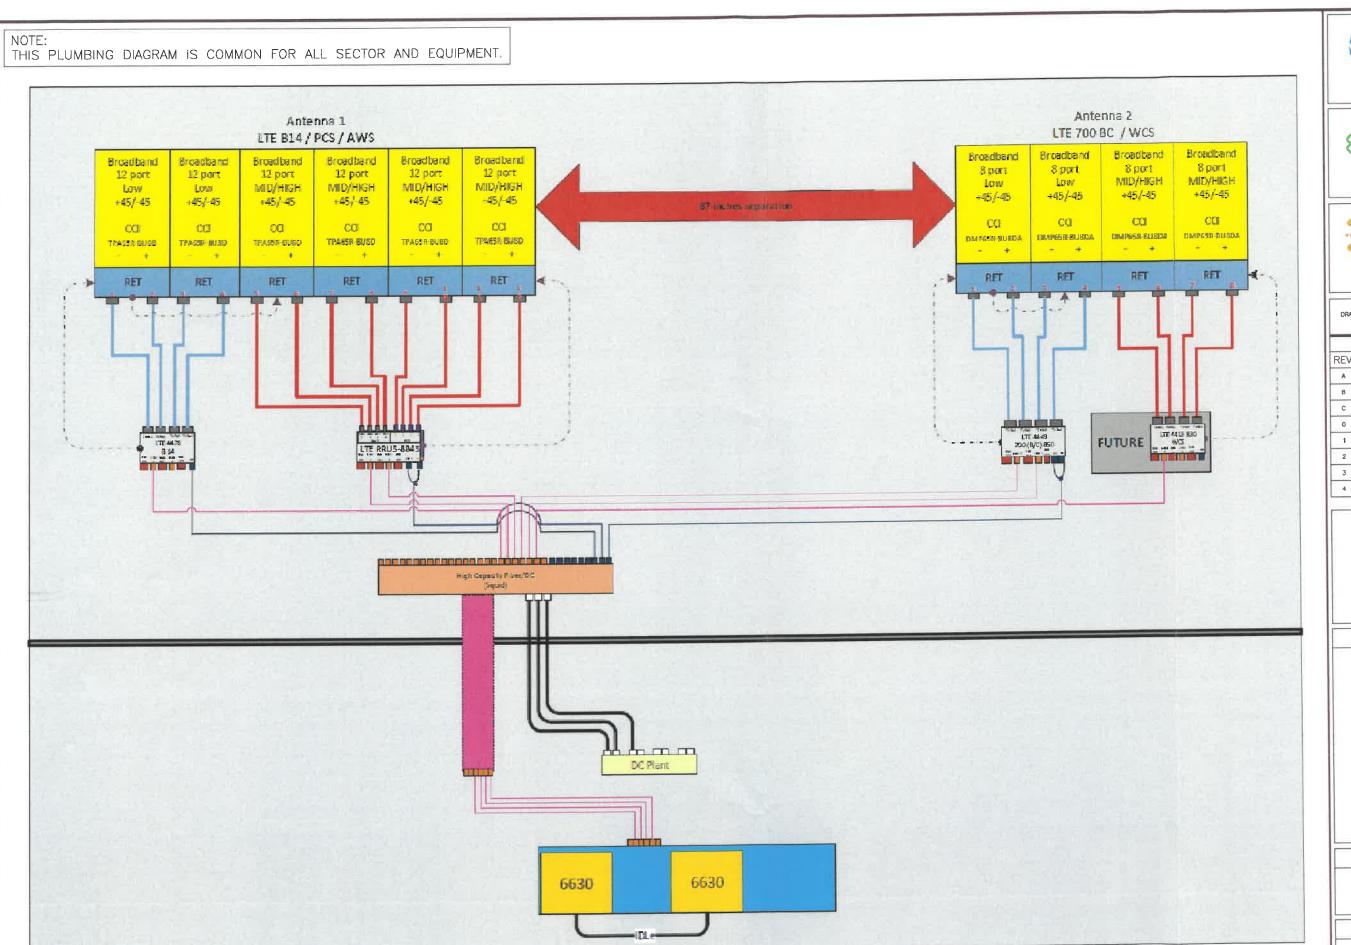

PLUMBING DIAGRAM FOR ALL SECTOR





BLDG 3, SUITE 102 NORTH BILLERICA, MA 01862



1825 W. WALNUT HILL LANE, SUITE 120 IRVING, TEXAS 75038 1-855-669-5421

DRAWING SCALES ARE INTENDED FOR 11°x17" SIZE PRINTED MEDIA ONLY.

SUBMITTALS				
REV	DATE	DESCRIPTION	BY	
A	11/03/22	90% CD	JSR	
В	11/09/22	90% CD	DIN	
c	11/30/22	90% CD	DIN	
0	01/31/23	100% CD	DIN	
1	02/21/23	ADDING FALL ZONE	JSR	
2	04/20/23	REDLINES PER CLIENT	JSR	
3	05/05/23	REDLINES PER CLIENT	JSR	
4	08/19/23	10' EXTENSION	JSR	



SITE INFORMATION

WAREHAM BROWN ST

MA1883

FA#: 15283436

USID: 317182


25 BROWN STREET WAREHAM, MA 02571

SHEET DESCRIPTION

PLUMBING DIAGRAM

SHEET NO.

D - 12

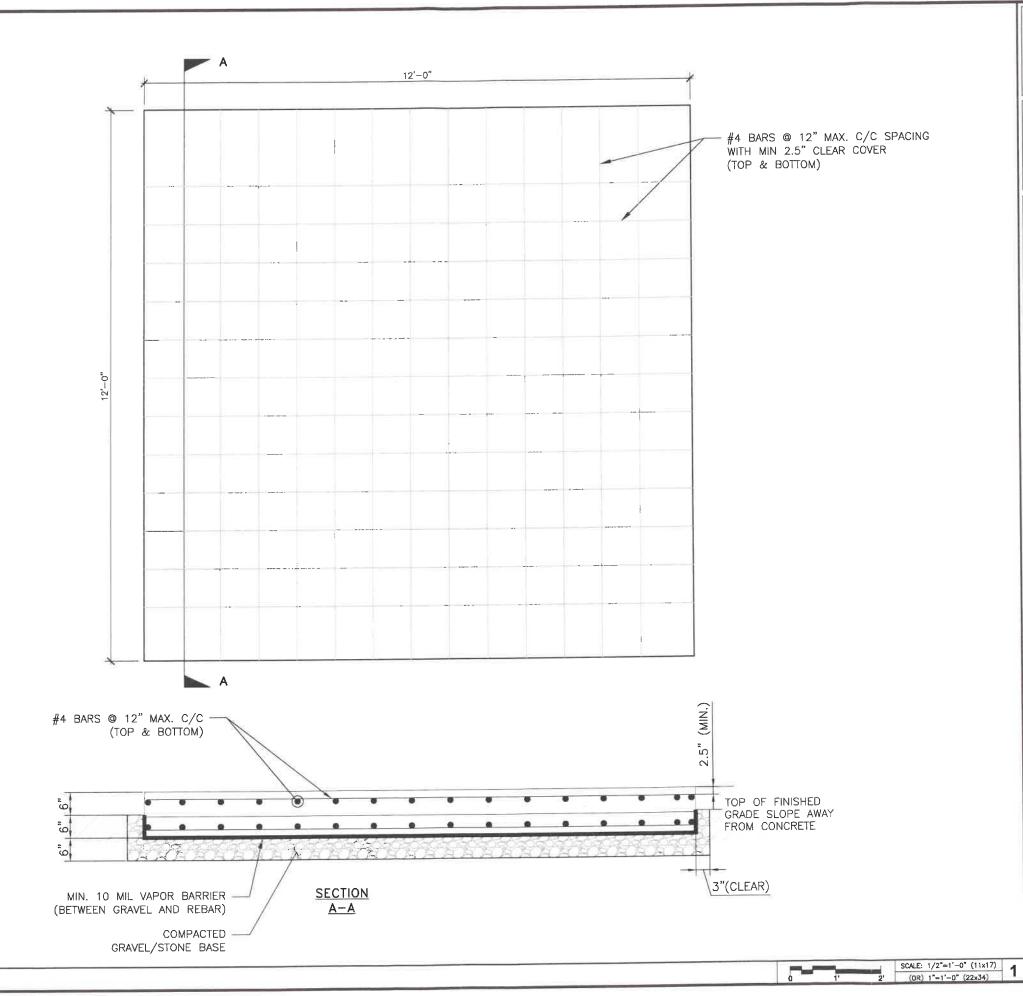

CONCRETE PAD DETAILS





85 RANGEWAY ROAD BLDG 3, SUITE 102 NORTH BILLERICA, MA 01862



1825 W. WALNUT HILL LANE, SUITE 120 IRVING, TEXAS 75038 1-855-669-5421

DRAWING SCALES ARE INTENDED FOR 11"x17" SIZE PRINTED MEDIA ONLY.

	SUBMITTALS				
REV	DATE	DESCRIPTION	BY		
A	11/03/22	90% CD	JSR		
В	11/09/22	90% CD	DIN		
c	11/30/22	90% CD	DIN		
0	01/31/23	100% CD	DłN		
1	02/21/23	ADDING FALL ZONE	JSR		
2	04/20/23	REDLINES PER CLIENT	JSR		
3	05/05/23	REDLINES PER CLIENT	JSR		
4	08/19/23	10' EXTENSION	JSR		



SITE INFORMATION

WAREHAM BROWN ST

MA1883

FA#: 15283436

USID: 317182

25 BROWN STREET WAREHAM, MA 02571

SHEET DESCRIPTION

CONCRETE PAD DETAILS


SHEET NO.

S-1


NOTES:

- ALL CONCRETE CONSTRUCTION SHALL MEET THE REQUIREMENTS OF THE AMERICAN CONCRETE INSTITUTE (ACI 318-14) BUILDING CODE REQUIREMENTS FOR REINFORCED CONCRETE AND (ACI 301) STANDARD SPECIFICATION FOR STRUCTURAL CONCRETE. ALL CONCRETE WORK SHALL BE IN ACCORDANCE WITH THE ACIW301, ACIW318, ASTM A184 AND ASTM A185.
 MINIMUM ALLOWABLE CONCRETE COMPRESSIVE STRENGTH SHALL BE 2500 PSI AT 28 DAYS WHEN TESTED IN ACCORDANCE WITH THE AMERICAN SOCIETY FOR TESTING AND MATERIALS METHODS STANDARDS ASTM C172, ASTM C31 AND ASTM C39 UNLESS OTHERWISE NOTED.
- NOTED.

 3. REINFORCING STEEL SHALL CONFORM TO ASTM A615, GRADE 60, DEFORMED UNLESS NOTED OTHERWISE. WELDING WIRE FABRIC SHALL CONFORM TO ASTM A185 WELDED STEEL WIRE FABRIC UNLESS NOTED OTHERWISE. SPLICES SHALL BE CLASS "8" AND ALL HOOKS SHALL BE STANDARD, UNLESS NOTED OTHERWISE.
- 4. DETAILING SHALL BE IN ACCORDANCE WITH MANUAL OF STANDARD PRACTICE OF DETAILING REINFORCED CONCRETE STRUCTURES (ACI STD-315-92).
- CHAMFER ALL EXPOSED EDGES OF CONCRETE 3/4" IN ACCORDANCE WITH ACI 301 SECTION 4.2.2. UNLESS OTHERWISE NOTED. REINFORCING STEEL SHALL BE ACCURATELY PLACED AND ADEQUATELY SECURED IN POSITION. LOCATION OF REINFORCEMENT SHALL BE INDICATED ON THE DRAWINGS. CONCRETE COVER SHALL DEPEND ON WHETHER CONCRETE IS PRE-CAST OR CAST IN PLACE.
- TOP OF FOUNDATION TO HAVE A "BRUSH FINISH".
- EXPOSED FINISHED SURFACE IS NOT TO HOLD WATER.
- ALL SURFACES ARE TO BE CLEANED OF ANY RESIDUAL CONCRETE FROM SPLASHING OR SPILLS.

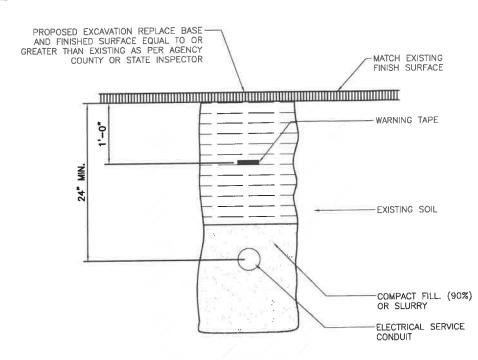



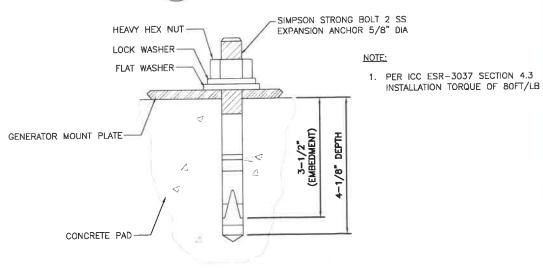

ANCHOR BOLT DETAIL S-2 SCALE (11" X 17"): N.T.S





85 RANGEWAY ROAD BLDG 3, SUITE 102 NORTH BILLERICA, MA 01862



1825 W. WALNUT HILL LANE, SUITE 120 IRVING, TEXAS 75038 1-855-669-5421

DRAWING SCALES ARE INTENDED FOR 11"x17" SIZE PRINTED MEDIA ONLY.

SUBMITTALS				
REV	DATE	DESCRIPTION	BY	
A	11/03/22	90% CD	JSR	
В	11/09/22	90% CD	DIN	
С	11/30/22	90% CD	DIN	
0	01/31/23	100% CD	DIN	
1	02/21/23	ADDING FALL ZONE	JSR	
2	04/20/23	REDLINES PER CLIENT	JSR	
3	05/05/23	REDLINES PER CLIENT	JSR	
4	08/19/23	10' EXTENSION	JSR	
1 2	02/21/23 04/20/23 05/05/23	ADDING FALL ZONE REDLINES PER CLIENT REDLINES PER CLIENT		



SITE INFORMATION

WAREHAM BROWN ST

MA1883

FA#: 15283436

USID: 317182


25 BROWN STREET WAREHAM, MA 02571

SHEET DESCRIPTION


FOUNDATION DETAILS

SHEET NO.


S-2

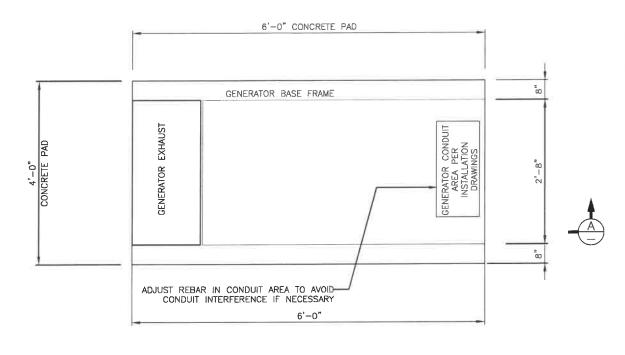

FOUNDATION PLAN S-2 SCALE (11" X 17"): 1' = 1/2"

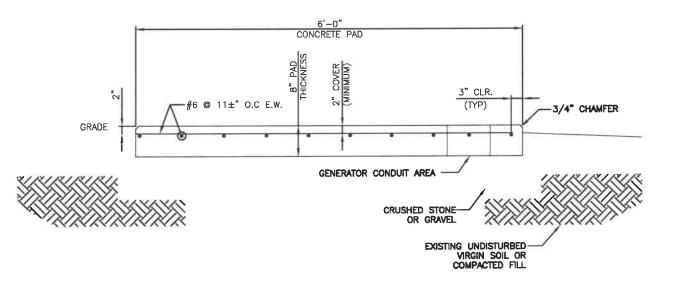

SECTION A-A S-2 SCALE (11" X 17"): 1 = 1/2"

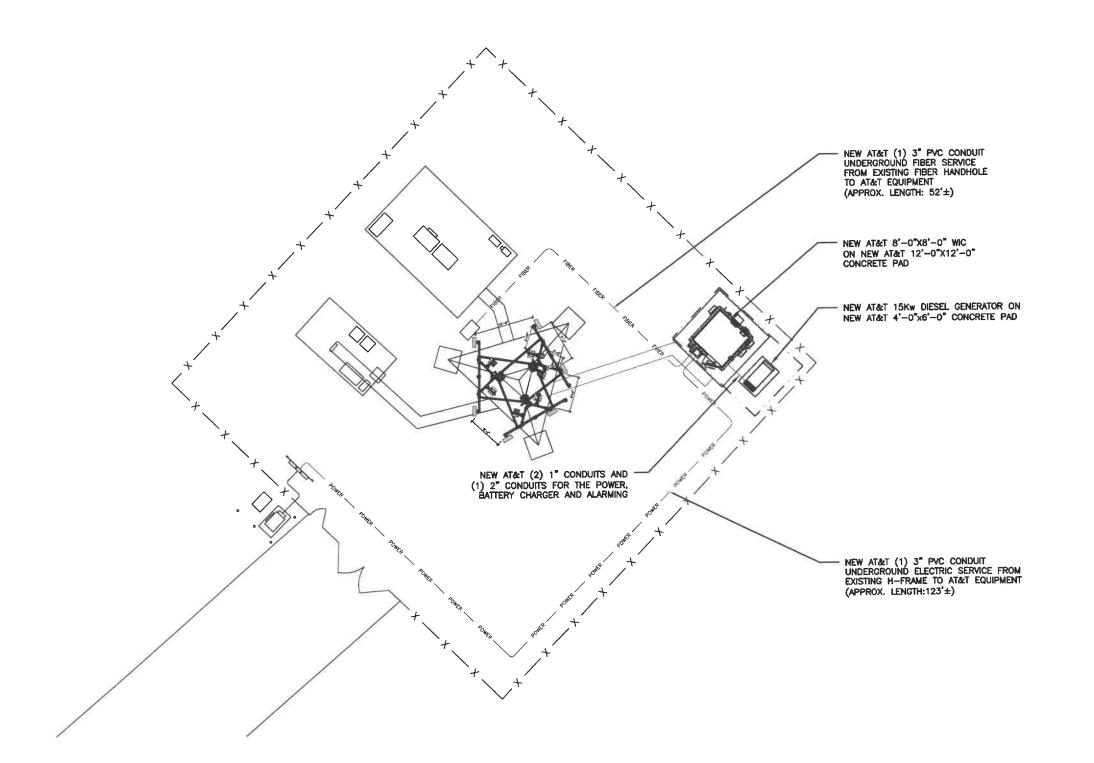





1825 W. WALNUT HILL LANE, SUITE 120 IRVING, TEXAS 7503B 1-855-669-5421

DRAWING SCALES ARE INTENDED FOR 11"x17" SIZE PRINTED MEDIA ONLY.

SUBMITTALS					
REV	DATE	DESCRIPTION	BY		
Α	11/03/22	90% CD	JSR		
В	11/09/22	90% CD	DIN		
С	11/30/22	90% CD	DIN		
0	01/31/23	100% CD	DIN		
1	02/21/23	ADDING FALL ZONE	JSR		
2	04/20/23	REDLINES PER CLIENT	JSR		
3	05/05/23	REDLINES PER CLIENT	JSR		
4	06/19/23	10' EXTENSION	JSR		



SITE INFORMATION

WAREHAM BROWN ST

MA1883

FA#: 15283436

USID: 317182

25 BROWN STREET WAREHAM, MA 02571


SHEET DESCRIPTION


UTILITY PLAN

SHEET NO.

NOT TO SCALE

UTILITY PLAN

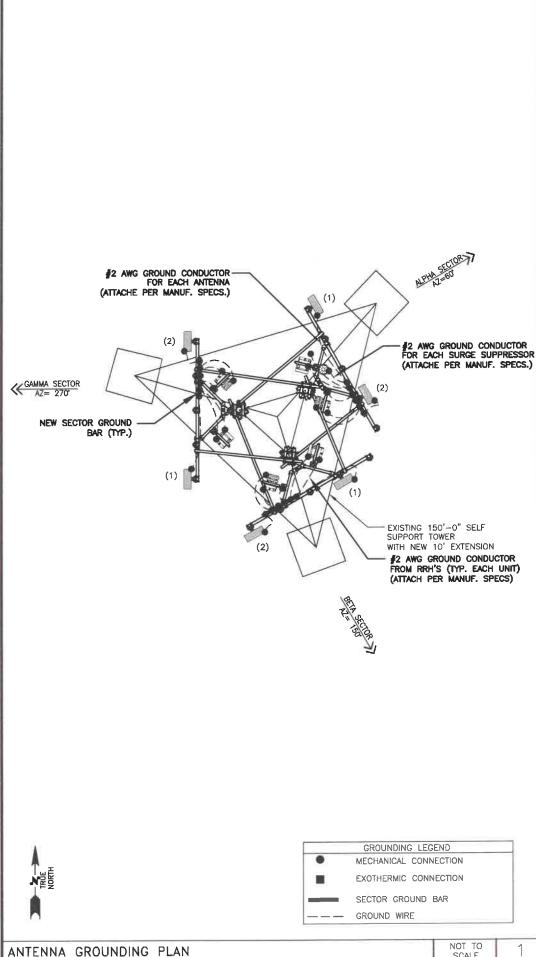

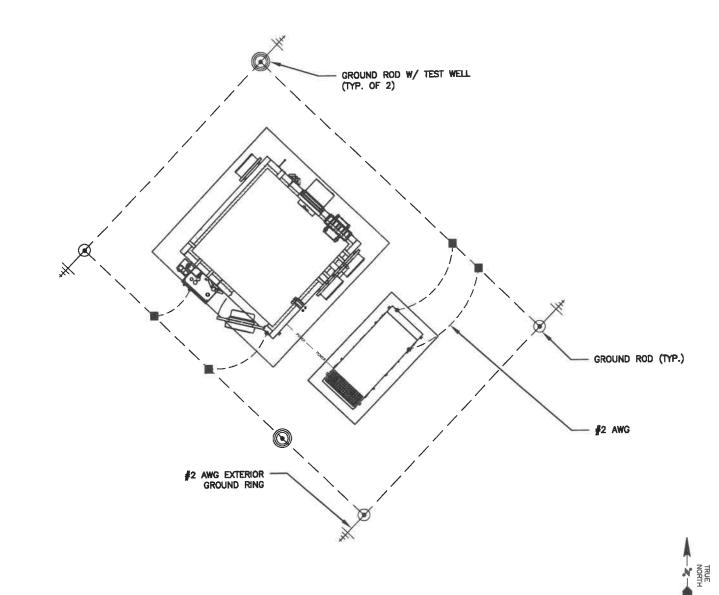

- 2. APPROVED ANTIOXIDANT COATINGS (I.E., CONDUCTIVE GEL OR PASTE) SHALL BE USED ON ALL COMPRESSION AND BOLTED GROUND CONNECTIONS.
- 3. MISCELLANEOUS ELECTRICAL AND NON-ELECTRICAL METAL BOXES, FRAMES AND SUPPORTS SHALL BE BONDED TO THE GROUND RING, IN ACCORDANCE WITH THE NEC.
- 4. METAL CONDUIT AND TRAY SHALL BE GROUNDED AND MADE ELECTRICALLY CONTINUOUS WITH LISTED BONDING FITTINGS OR BY BONDING ACROSS THE DISCONTINUITY WITH 6 AWG COPPER WIRE AND UL APPROVED GROUNDING TYPE CONDUIT CLAMPS.
- GROUND CONDUCTORS USED IN THE FACILITY GROUND AND LIGHTNING PROTECTION SYSTEMS SHALL NOT BE ROUTED THROUGH METALLIC OBJECTS THAT FORM A RING AROUND THE CONDUCTOR, SUCH AS METALLIC CONDUITS, METAL SUPPORT CLIPS OR SLEEVES THROUGH WALLS OR FLOORS. WHEN IT IS REQUIRED TO BE HOUSED IN CONDUIT TO MEET CODE REQUIREMENTS OR LOCAL CONDITIONS, NON-METALLIC MATERIAL SUCH AS 11. ALUMINUM CONDUCTOR OR COPPER CLAD STEEL CONDUCTOR SHALL NOT BE USED FOR PLASTIC CONDUIT SHALL BE USED. WHERE USE OF METAL CONDUIT IS UNAVOIDABLE GROUNDING CONNECTIONS. (E.G., NON-METALLIC CONDUIT PROHIBITED BY LOCAL CODE) THE GROUND CONDUCTOR SHALL BE BONDED TO EACH END OF THE METAL CONDUIT.
- ANY EQUIPMENT, BOX, SKID TO BE GROUNDED AND DOES NOT HAVE A DESIGNATED GROUND CONNECTION SHALL BE DRILLED AS NECESSARY TO CONNECT A GROUND WIRE. REMOVE PAINT IN AREA UNDER LUG. APPLY ANTI-OXIDANT COMPOUND AND CONNECT WITH
- 7. GROUND BARS SHALL BE TINNED COPPER AND SHALL BE ENGRAVED OR IMPRESSED "STOLEN-DO NOT RECYCLE" AND/OR "PROPERTY OF AT&T", ETCHED OR STAMPED WITH SITE FA LOCATION AND SECURED WITH ANTI-THEFT HARDWARE.

- 1. EXOTHERMIC WELDS SHALL BE USED FOR ALL GROUNDING CONNECTIONS BELOW GRADE. 8. THE SUBCONTRACTOR SHALL PERFORM IEEE FALL—OF—POTENTIAL RESISTANCE TO EARTH TESTING FOR GROUND ELECTRODE SYSTEMS. TESTING SHALL BE IN ACCORDANCE WITH IEEE STD 81.
 - THE SUBCONTRACTOR SHALL FURNISH AND INSTALL SUPPLEMENTAL GROUND ELECTRODES AS NEEDED TO ACHIEVE A TEST RESULT OF 5 OHMS OR LESS. WHEN ADDING ELECTRODES, CONTRACTOR SHALL MAINTAIN A MINIMUM DISTANCE BETWEEN THE ADDED ELECTRODE AND ANY OTHER EXISTING ELECTRODE EQUAL TO THE BURIED LENGTH OF THE ROD. IDEALLY, CONTRACTOR SHALL STRIVE TO KEEP THE SEPARATION DISTANCE EQUAL TO OR LESS THAN TWICE THE BURIED LENGTH OF THE RODS.
 - 10. METAL RACEWAY SHALL NOT BE USED AS THE NEC REQUIRED EQUIPMENT GROUND CONDUCTOR, STRANDED COPPER CONDUCTORS WITH GREEN INSULATION, SIZED IN ACCORDANCE WITH THE NEC, SHALL BE FURNISHED AND INSTALLED WITH THE POWER CIRCUITS TO BTS EQUIPMENT.

 - 12. EACH INTERIOR COMMUNICATION CABINET FRAME/PLINTH SHALL BE ELECTRICALLY ISOLATED FROM GROUNDS AND SHALL BE DIRECTLY CONNECTED TO THE CELL REFERENCE GROUND BAR WITH 6 AWG OR LARGER STRANDED, GREEN INSULATED GROUND WIRES.
 - 13. GROUND WIRING INSTALLED OUTDOOR EXPOSED SHALL BE 600V, GREEN SUNLIGHT RESISTANT UL LISTED TYPE THW OR THWN OR XHHW, ANNEALED, TINNED, OR UN-TUNNED CLASS B OR CLASS I STRANDED COPPER, SIZE 6 UNLESS OTHERWISE SPECIFIED.
 - 14. GROUND RODS SHOULD BE SPACED AT APPROXIMATELY TWICE THEIR LENGTH AS PER ATT-TP-76416 SPECIFICATIONS.







1825 W. WALNUT HILL LANE, SUITE 120 IRVING, TEXAS 75038 1-855-669-5421

DRAWING SCALES ARE INTENDED FOR 11"x17" SIZE PRINTED MEDIA ONLY.

SUBMITTALS				
REV	DATE	DESCRIPTION	BY	
A	11/03/22	90% CD	JSR	
В	11/09/22	90% CD	DIN	
С	11/30/22	90% CD	DIN	
0	01/31/23	100% CD	DIN	
1	02/21/23	ADDING FALL ZONE	JSR	
2	04/20/23	REDLINES PER CLIENT	JSR	
3	05/05/23	REDLINES PER CLIENT	JSR	
4	06/19/23	10' EXTENSION	JSR	



SITE INFORMATION

WAREHAM BROWN ST MA1883

> FA#: 15283436 USID: 317182

25 BROWN STREET WAREHAM, MA 02571

SHEET DESCRIPTION

GROUNDING PLAN

SHEET NO.

TWO-HOLE, COMPRESSION LUG.

EQUIPMENT GROUNDING PLAN


NOT TO SCALE



PARALLEL EXOTHERMIC WELD (CADWELD®, THERMOWELD® OR EQUIVALENT). NO "T" (90°)-WELDS ALLOWED. -NO SLAG OR DEFORMITIES ALLOWED

MINIMUM BENDING RADIUS 6 INCHES. (12 INCHES PREFERRED) TYPICAL

BRANCH, 2 AWG SOLID. BARE, TINNED COPPER GROUNDING CONDUCTOR

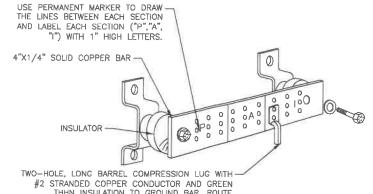

THHN INSULATION TO GROUND BAR, ROUTE CONDUCTOR TO MASTER GROUND BAR, AND CONNECT WITH TWO-HOLE LUG.

EACH GROUND CONDUCTOR TERMINATING ON ANY GROUND BAR SHALL HAVE AN IDENTIFICATION TAG ATTACHED AT EACH END THAT WILL IDENTIFY ITS ORIGIN AND DESTINATION.

SECTION "P" - SURGE PRODUCERS

CABLE ENTRY PORTS (HATCH PLATES) GENERATOR FRAMEWORK (IF AVAILABLE) TELCO GROUND BAR COMMERCIAL POWER COMMON NEUTRAL/GROUND BOND +24V POWER SUPPLY RETURN BAR (#2) -48V POWER SUPPLY RETURN BAR (#2)



85 RANGEWAY ROAD

BLDG 3, SUITE 102 NORTH BILLERICA, MA 01862



1825 W. WALNUT HILL LANE, SUITE 120 IRVING, TEXAS 75038 1-855-669-5421

DRAWING SCALES ARE INTENDED FOR 11"x17" SIZE PRINTED MEDIA ONLY.

-				
- 1	REV	DATE	DESCRIPTION	BY
-	A	11/03/22	90% CD	JSR
- 1	8	11/09/22	90% CD	DIN
-	С	11/30/22	90% CD	DiN
-	0	01/31/23	100% CD	DIN
-	1	02/21/23	ADDING FALL ZONE	JSR
-	2	04/20/23	REDLINES PER CLIENT	JSR
┥	3	05/05/23	REDLINES PER CLIENT	JSR
	4	06/19/23	10' EXTENSION	JSR

UTILIZE EXISTING GROUND -BAR ON WALL OR TOWER. IF EXISTING GROUND BAR IS FULL THEN CONTRACTOR SHALL PROVIDE A NEW GROUND BAR #4/0 TO GROUND RING VIA BOTTOM GROUND BAR AND INTERMEDIATE GROUND BARS AS REQUIRED.

TYPICAL EXTERIOR GROUND RING CONNECTION NOT TO SCALE GROUND BAR SECTOR GROUND BAR SCALE



TYPE HS












































ERICO EXOTHERMIC "MOLD TYPES" SHOWN HERE ARE EXAMPLES. CONSULT WITH CONSTRUCTION MANAGER FOR SPECIFIC MOLDS TO BE USED FOR THIS PROJECT.
 MOLD TYPE ONLY TO BE USED BELOW GRADE WHEN CONNECTING GROUND RING TO GROUND ROD.

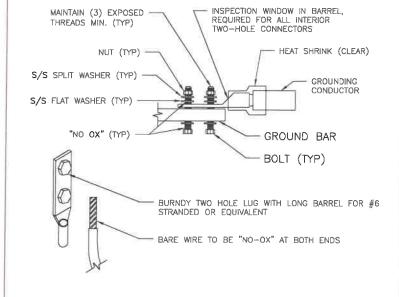


1. ALL HARDWARE SHALL BE 18—8 STAINLESS STEEL.
 2. COAT ALL SURFACES WITH ANTIOXIDANT COMPOUND BEFORE

MATING.

ALL EXPOSED EASILY ACCESSIBLE GROUND BARS SHALL BE TAGGED "DO NOT DISCONNECT".

4. COAT ALL BARRELS WITH ANTIOXIDANT BEFORE CRIMPING.

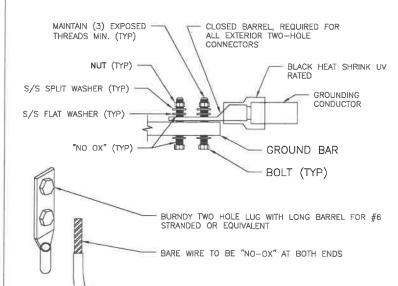

1. ALL HARDWARE SHALL BE 18-8 STAINLESS STEEL.
2. COAT ALL SURFACES WITH ANTIOXIDANT COMPOUND BEFORE MATING

ALL EXPOSED EASILY ACCESSIBLE GROUND BARS SHALL BE TAGGED "DO NOT DISCONNECT".

4. COAT ALL BARRELS WITH ANTIOXIDANT BEFORE CRIMPING.

ABERNATAD No. 52163

SITE INFORMATION

WAREHAM BROWN ST

MA1883 FA#: 15283436

USID: 317182

25 BROWN STREET WAREHAM, MA 02571

SHEET DESCRIPTION

GROUNDING DETAILS

SHEET NO.

CADWELD GROUNDING CONNECTIONS NOT TO SCALE NOT TO SCALE 4 6 INTERIOR GROUND BAR LUG EXTERIOR GROUND BAR LUG